SITE PLAN REVIEW

FOR **748 HOMESTEAD** 748 WASHINGTON STREET, WOODLAND, WA 98674

PREPARED FOR: HOMESTEAD, LLC

P.O. BOX 255 YACOLT, WA 98675 CONTACT: ROGER FOLEY PHONE: (360) 901-0056 EMAIL: ROGER.FOLEY505@GMAIL.COM

PREPARED BY: WINDSOR ENGINEERS

CONTACT: DAN KOISTINEN PHONE: (360) 852-4971 EMAIL: DKOISTINEN@WINDSORENGINEERS.COM



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PROJECT NUMBER: 21035.1

CONSTRUCTION SHALL CONFORM TO THE REQUIREMENTS OF THE CITY OF WOODLAND ENGINEERING STANDARDS FOR CONSTRUCTION

PARCEL INFORMATION: PARCEL NUMBER: 50346 LOT SIZE: 0.75 AC ZONING: LOW DENSITY RESIDENTIAL (LDR-6)

LEGAL DESCRIPTION: IN A PORTION OF THE S&M D.L.C. IN SECTION 24, T. 5 N., R. 1 W., W.M. CITY OF WOODLAND, COWLITZ COUNTY, WASHINGTON

BASIS OF BEARING: BASED ON FOUND STREET MONUMENTS ON THE CENTERLINE OF PARK STREET PER AMENDED SHORT SUBDIVISION BOOK 12, PAGE 55

VERTICAL DATUM: NAVD 88 BASED ON WSDOT MON. 4081 EL = 30.07

CITY OF WOODLAND


CITY OF WOODLAND PERSONNEL

230 DAVIDSON AVE PO BOX 9 WOODLAND, WA 98674

PHONE: 360-225-8281 TRAVIS GODDARD - COMMUNITY DEVELOPMENT TRACY COLEMAN - PUBLIC WORKS DIRECTOR DEBI CLER - BUILDING OFFICIAL MARK NELSON - ENGINEERING KATHRYN MYKLEBUST - ENGINEERING AIDE MIKE JACKSON - DIVISION FIRE CHIEF

SHEET INDEX

- G001 COVER SHEET
- G002 CIVIL NOTES AND ABBREVIATIONS
- G003 LEGENDS
- C000 EXISTING CONDITIONS
- C001 DEMOLITION PLAN
- C105 SITE PLAN
- C106 COMPOSITE UTILITY PLAN
- C110 EROSION CONTROL PLAN
- C130 GRADING PLAN
- C390 STORMWATER PLAN
- C601 EROSION CONTROL DETAILS
- C602 SITE DETAILS
- C603 STORMWATER DETAILS
- C604 UTILITY DETAILS
- C605 SITE DETAILS

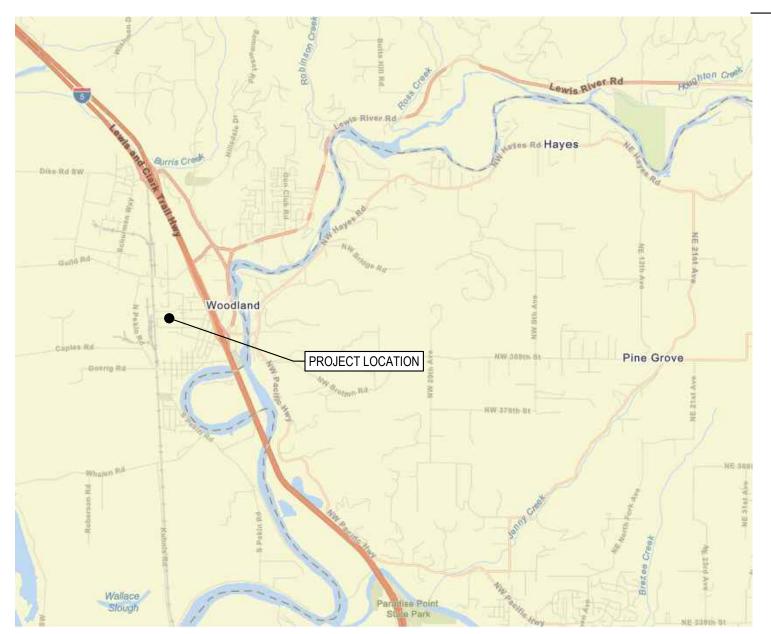

VICINITY MAP

UTILITY

WATER SEWER WASTE SERVICES POWER INTERNET

JURISDICTION

CITY OF WOODLAND CITY OF WOODLAND CITY OF WOODLAND COWLITZ PUD COMCAST

PHONE NUMBER

360-225-8281 360-225-8281 360-225-8281 360-423-2210 800-934-6489

WOODLAND WASHINGTON	City of Woodland Public Works Department PO Box 9 236 Ste B Davidson Woodland, WA 98674 www.ci.woodland.wa.us		(360) 22 0) 225-74	
Pla	ans reviewed for compliance City Standards and Policie			
Permit Number:	SPR-23-XXX			
Recommended for Ap	proval:			
PUBLIC WORKS DIR	ECTOR	DATE		
Improvement Sum	mary:			
STREET IMPROVEMENTS	S	_	169	LF
WATER MAIN FOOTAGE		N/A	LF	
SEWER MAIN FOOTAGE			N/A	LF
SEPTIC SYSTEM DECOMMISSIONED			N/A	EA
TRENCHING WITHIN CITY RIGHT-OF-WAY			196	LF
TOTAL IMPRERVIOUS SURFACE			17,750	SF
PRIVATE IMPERVIOUS SURFACE		0.388	AC	
GRADING:	CUT <u>~50</u> CY	FILL _	~50	CY

REVISIONS:

SUED FOR SITE PLAN REVIEW

PROJECT NOTES

PROJECT INCLUDES A FIVE LOT SUBDIVISION AND INFRASTRUCTURE INCLUDING FRONTAGE IMPROVEMENTS, STORMWATER FACILITIES, AND UTILITIES

PARCEL NO.(S): 50346

SITE ADDRESS: 748 WASHINGTON STREET, WOODLAND, WA

QUARTER SECTION: SECTION 24, T5N, R1W, W.M. COUNTY: COWLITZ

CRITICAL AREAS:

- 1. ON THE SUBJECT PARCEL, THERE ARE NO KNOWN: ON SITE SEPTIC TANKS DRAIN FIELDS, EXISTING / PROPOSED WELLS
- GAS PIPELINES / EASMENTS.
- 2. A GEOTECHNICAL REPORT PREPARED BY (STRATA DESIGN, LLC) PROVIDES RECOMMENDATIONS FOR THIS SITE.

CONTACT INFORMATION

APPLICANT / PROPERTY OWNER HOMESTEAD, LLC (DEVELOPER) CONTACT: ROGER FOLEY ROGER.FOLEY505@GMAIL.COM

REPRESENTATIVE / CONTACT WINDSOR ENGINEERS, LLC

(E) EXISTING

C CONCRETE

CB CATCH BASIN

CL CENTERLINE

CO CLEAN OUT

CR CURB RETURN

D DIRT / DRAINAGE

FG FINISHED GRADE

FH FIRE HYDRANT

FL FLOW LINE

FM FORCE MAIN

GB GRADE BREAK

HP HIGH POINT

LF LINEAR FOOT

LP LOW POINT

MH MANHOLE

NS NATIVE SOIL

P PAVEMENT

NTS NOT TO SCALE

PC POINT OF CURVATURE POC POINT OF CONNECTION

POS POINT OF SERVICE

PT POINT OF TANGENCY

PP POWER POLE

ROW RIGHT OF WAY

S SLOPE / SANITARY

SSMH SANITARY MANHOLE

SAN SEWER SEWER

STA STATION

STM STORM DRAIN

TC TOP OF CURB TOE TOE OF BANK TOP TOP OF BANK TP TELEPHONE POLE U UNDERGROUND

W WATER MAIN

XFMR TRANSFORMER

STMH STORM MANHOLE

TBD TO BE DETERMINED

TBL TO BE RELOCATED BY RESPECTIVE UTILITY

VIP VERIFY IN FIELD PRIOR TO CONSTRUCTION

TBR TO BE REMOVED BY CONTRACTOR

R RADIUS

G

CNS COMPACTED NATIVE SOIL

DCDA DOUBLE CHECK DETECTOR ASSEMBLY

NATURAL GAS (LOW PRESSURE)

MG NATURAL GAS (MEDIUM PRESSURE)

MG MATCH EXISTING GRADE

27300 NE 10TH AVE. RIDGEFIELD, WA 68642 CONTACT: EMILY STEPHENS (612) 351-2331 ESTEPHENS@WINDSORENGINEERS.COM

GENERAL ABBREVIATIONS

CONTACT: EVAN MARTTILA PHONE: (360) 553-5992 EMAIL: EVAN@NORTHERN-LS.COM GEOTECHNICAL ENGINEER

BATTLE GROUND, WA 98604

NORTHERN LAND SURVEYING, LLC

SURVEYOR

STRATA DESIGN, LLC PORTLAND, OR 97232 CONTACT: RANDY GOODE PHONE: (360) 450-7574 EMAIL: RANDY@STRATA-DESIGN.COM

GENERAL PLAN NOTES (PRIVATE)

1. CONTRACTOR TO VERIFY ALL UTILITY LOCATIONS AND DEPTHS PRIOR TO CONSTRUC TWO FULL BUSINESS DAYS PRIOR TO BEGINNING CONSTRUCTION, THE CONTRACTOR S NOTIFICATION CENTER) FOR LOCATION MARK-UP OF EXISTING UTILITIES

2. ALL CONSTRUCTION, MATERIALS, AND WORKMANSHIP SHALL CONFORM TO THE LATE PRACTICES OF THE COWLITZ COUNTY AND THE LATEST EDITION OF THE "STANDARD SP ROAD, BRIDGE, AND MUNICIPAL CONSTRUCTION" PREPARED BY WSDOT/APWA

3. IN CASE OF A CONFLICT BETWEEN THE REGULATORY STANDARDS OR SPECIFICATION STRINGENT REQUIREMENT WILL PREVAIL.

4. ANY CHANGES TO THE DESIGN AND/OR CONSTRUCTION SHALL BE APPROVED BY THE

5. APPROVAL OF THESE PLANS DOES NOT CONSTITUTE AN APPROVAL OF ANY OTHER C SPECIFICALLY SHOWN ON THE PLANS. PLANS FOR STRUCTURES SUCH AS BRIDGES, BU VAULTS, ROCKERIES, AND RETAINING WALLS MAY REQUIRE A SEPARATE REVIEW AND A BUILDING DEPARTMENT PRIOR TO CONSTRUCTION.

6. A COPY OF THESE APPROVED PLANS SHALL BE ON THE JOB SITE WHENEVER CONSTR PROGRESS.

7. IT SHALL BE THE CONTRACTOR'S RESPONSIBILITY TO OBTAIN ALL CONSTRUCTION EA PERMITS NECESSARY TO PERFORM THE WORK.

8. THE CONTRACTOR IS RESPONSIBLE FOR ALL CONSTRUCTION STAKING.

9. PUBLIC AND PRIVATE DRAINAGE WAYS SHALL BE PROTECTED FROM POLLUTION. NO I DISCHARGED TO OR DEPOSITED IN STORMWATER SYSTEMS THAT MAY RESULT IN VIOL FEDERAL WATER QUALITY STANDARDS.

10. ALL CONSTRUCTION WITHIN THE PUBLIC RIGHT-OF-WAY SHALL HAVE AN APPROVED WORK PERMIT PRIOR TO ANY CONSTRUCTION ACTIVITY WITHIN THE RIGHT-OF- WAY.

11. THE CONTRACTOR SHALL BE RESPONSIBLE FOR PROVIDING ADEQUATE SAFEGUARE PROTECTIVE EQUIPMENT, FLAGGERS, AND ANY OTHER NEEDED ACTIONS TO PROTECT SAFETY OF THE PUBLIC, AND TO PROTECT PROPERTY IN CONNECTION WITH THE PERFO COVERED BY THE CONTRACTOR, ALL TRAFFIC CONTROL DEVICES SHALL CONFORM TO EDITION OF THE "MANUAL ON UNIFORM TRAFFIC CONTROL DEVICES" (MUTCD) PUBLISHE DEPARTMENT OF TRANSPORTATION. TWO-WAY TRAFFIC MUST BE MAINTAINED AT ALL T ADJACENT PUBLIC STREETS.

12. ANY PUBLIC OR PRIVATE CURB, GUTTER, SIDEWALK, OR ASPHALT DAMAGED DURING SHALL BE REPAIRED TO CITY/COUNTY STANDARDS AND PRACTICES.

13. THE CONTRACTOR SHALL BE RESPONSIBLE FOR MAINTAINING THE INTEGRITY OF AD WHICH MAY INCLUDE, BUT ARE NOT LIMITED TO, WATER, SANITARY SEWER, STORMWAT TELEPHONE, CABLE TV, GAS, IRRIGATION, AND STREET LIGHTING. THE CONTRACTOR SH RESIDENTS AND BUSINESSES 48 HOURS IN ADVANCE OF ANY WORK AFFECTING ACCESS SHALL MINIMIZE INTERRUPTIONS TO DRIVEWAYS FOR RESIDENTS AND BUSINESSES AD. PROJECT.

14. ALL LAWN AND VEGETATED AREAS DISTURBED WILL BE RESTORED TO ORIGINAL CO DISTURBANCE OR DAMAGE TO OTHER PROPERTY ON ADJACENT PARCELS OR IN THE PL SHALL ALSO BE REPAIRED OR RESTORED TO ORIGINAL CONDITION.

15. ALL MATERIALS AND METHODS OF CONSTRUCTION AND INSTALLATION FOR WATER, STORM FACILITIES SHALL CONFORM TO THE CITY OF WOODLAND DESIGN GUIDELINES. BE AS PER THE MOST CURRENT STANDARD DETAIL CONTAINED THEREIN.

16. THE TYPES, LOCATIONS, SIZES AND/OR DEPTHS OF EXISTING UNDERGROUND UTILIT AS SHOWN ON THE DRAWINGS ARE APPROXIMATE AND WERE OBTAINED FROM SOURCE RELIABILITY. THE CONTRACTOR IS CAUTIONED THAT ONLY ACTUAL EXCAVATION WILL R EXTENT, SIZES, LOCATIONS, AND DEPTHS OF UTILITIES. A REASONABLE EFFORT HAS BE AND DELINEATE ALL KNOWN UNDERGROUND UTILITIES. THE CONTRACTOR SHALL VERIF AND PROVIDE PROTECTION FOR ALL UTILITIES AND STRUCTURES. OVERHEAD UTILITIES

17. EXISTING UTILITIES DAMAGED BY THE CONTRACTOR SHALL BE REPAIRED BY THE CO UTILITY.

18. WHERE THE CONTRACTOR MUST RELOCATE WATER AND GAS UTILITIES, SHUTDOWN ACCOMPLISHED BY THE CITY OR UTILITY PURVEYOR.

19. ALL OPEN TRENCHES THAT IMPACT PUBLIC ACCESS OR OTHER PROJECT WORK ACC PROJECTS SITE, MUST BE STEEL PLATED OR BACKFILLED AND PAVED WITH AT LEAST 2" ADJACENT EXISTING GRADE AT THE END OF EACH WORKDAY.

20. NOTIFY ADJACENT RESIDENCES AT LEAST ONE DAY PRIOR TO COMMENCING WORK. RESIDENCES.

21. SAWCUT ALL PAVEMENT JOINT LINES. WHERE THERE IS A PREVIOUS PAVING EDGE C THE SAWCUT EDGE, REMOVE THE PAVEMENT TO THE PREVIOUS PAVING EDGE.

22. THE CONTRACTOR SHALL COMPLY WITH WASHINGTON REQUIREMENTS FOR TRENCH

23. THE CONTRACTOR SHALL REPLACE ALL SURVEY MONUMENTS THAT ARE DESTROYE CONSTRUCTION.

24. ALL WATER PIPING SHALL BE CONSTRUCTED WITH 3' MINIMUM COVER, 1' VERTICAL S UTILITIES, AND A MINIMUM OF 10' HORIZONTAL SEPARATION AND 18" ABOVE SEWER LINE OTHERWISE NOTED.

25. THE CONTRACTOR SHALL RESTORE PAVEMENT AND LANDSCAPING DISTURBED BY T THE PREVIOUSLY UNDISTURBED CONDITION.

26. CONTRACTOR TO DISPOSE OF TREES, SHRUBS, SOD AND OTHER DEBRIS IN A PROPER MANNER OF THE CONTRACTOR'S CHOOSING.

$\mathbf{O}\mathbf{n}$	Revisions:	LINE IS 1" ON FULL SCALE DRAWING		
				Rid
				Dul
Know what's below.				WW
Call before you dig.			WINDSOR	Convri
CALL 2 BUSINESS DAYS BEFORE YOU DIG. CAUTION UTILITY INFORMATION IS APPROXIMATE. VERIFY ALL UTILITIES PRIOR TO CONSTRUCTION.			ENGINEERS	Copyrig All Rigl

OFNEDAL ON UL NOTEO

	GENERAL CIVIL NOTES	DOE STAN
ICTION. A MINIMUM OF SHALL CALL 811 (UTILITY	SURVEY TOPOGRAPHIC SURVEY BY: NORTHERN LAND SURVEYING LLC HORIZONTAL DATUM: LOCAL COORDINATE SYSTEM ELEVATION DATUM: NAVD 88	1. APPROVAL C OF PERMANEN CHANNELS, RE
TEST STANDARDS AND SPECIFICATIONS FOR	STORM DRAINAGE: ON-SITE STORM SEWER IMPROVEMENTS SHALL CONFORM TO THE LATEST VERSION OF THE UPC, AND CONFORM TO WSDOT SPECIFICATIONS WHERE NOTED.	2. THE IMPLEM AND UPGRADIN ALL CONSTRUC
ONS, THE MORE	THE CONTRACTOR SHALL MAINTAIN 6" MINIMUM VERTICAL AND 3' MINIMUM HORIZONTAL CLEARANCE (OUTSIDE	3. THE BOUNDA
HE OWNER OR ENGINEER.	SURFACES) BETWEEN STORM DRAIN PIPES AND OTHER UTILITY PIPES AND CONDUITS. FOR CROSSINGS OF SANITARY SEWER LINES, THE WASHINGTON DEPARTMENT OF ECOLOGY CRITERIA APPLY.	FLAGGED CLEA APPLICANT/CO
CONSTRUCTION NOT UILDINGS, TANKS, APPROVAL BY THE	ALL CATCH BASINS SHALL BE LABELED WITH "NO DUMPING*PROTECT WATER*ONLY RAIN IN DRAIN" MEDALLIONS. MEDALLIONS SHALL BE AFFIXED TO DRY SURFACE WITH HIGH QUALITY POLYURETHANE SEALANT AND RIVETS.	4. THE ESC FAC AND GRADING WATER DO NO
TRUCTION IS IN	STORM DRAIN PIPE, BENDS, AND FITTINGS SHALL BE PVC, ASTM D 3034, SDR 35, OR SMOOTH INTERIOR, HIGH DENSITY POLYETHYLENE CORRUGATED PIPE AASHTO M252 OR M294, TYPE S AS PRODUCED AND SPECIFIED BY ADS, PRODUCT NAME N12, OR APPROVED EQUAL. ALL STORM SEWER FITTINGS AND PIPE JOINTS SHALL BE GASKETED.	5. THE ESC FAC CONDITIONS, D FOR UNEXPEC LEAVE THE SIT
EASEMENTS AND	2' SUMP INCLUDED ON ALL CATCH BASIN MANHOLES. 1.5' MIN SUMP INCLUDED ON CATCH BASINS.	6. THE ESC FAC
	PERFORATED PIPE SHALL BE ADS SINGLE WALL PERFORATED PIPE WITH SOCK OR APPROVED EQUAL.	NECESSARY TO
D MATERIAL IS TO BE	ALL STORM SEWER PIPE SHALL HAVE A MINIMUM 12" DIAMETER WITHIN ROADWAY	7. THE ESC FAC MONTH OR WIT
LATION OF STATE OR	ALL ON-SITE STORMWATER FACILITIES SHALL BE PRIVATELY MAINTAINED BY THE CURRENT OR FUTURE	8. AT NO TIME S
D PUBLIC RIGHT-OF-WAY	PROPERTY OWNER(S). ALL VAULT, UTILITY BOX, INLET, MANHOLE AND CLEANOUT RIMS SHALL BE ADJUSTED TO FINISH GRADE	CATCH BASIN.
RDS, SAFETY DEVICES, T THE LIFE, HEALTH, AND	UNLESS OTHERWISE NOTED.	9. STABILIZED (MAINTAINED FO PAVED AREAS
FORMANCE OF WORK O THE LATEST ADOPTED	EXISTING DRAINAGE APPURTENANCES TO REMAIN.	10. THE PROPC
hed by the U.S. . Times on the	SANITARY SEWER: ON-SITE (PRIVATE) SANITARY SEWER IMPROVEMENTS SHALL CONFORM TO THE LATEST VERSION OF THE IBC, THE UPC, AND WSDOT SPECIFICATIONS WHERE NOTED AND THE CITY OF WOODLAND GENERAL REQUIREMENTS.	VEGETATION T INUNDATED WI PRIOR TO PRO
IG CONSTRUCTION	SANITARY SEWER PIPE SHALL BE POLYVINYL CHLORIDE (PVC) AND CONFORM TO ASTM D3034, SDR35.	RECOMME
ADJACENT UTILITIES	CONTRACTOR SHALL COORDINATE ALL BUILDING SANITARY CONNECTIONS WITH PLUMBING PLAN PRIOR TO	1. PRE-CONSTR
ATER, POWER, SHALL NOTIFY	CONSTRUCTION.	2. FLAG OR FEI
SS OR SERVICE AND DJACENT TO THE	CONTRACTOR IS RESPONSIBLE FOR ALL PERMITS AND INSPECTIONS.	3. POST NOTIC SEDIMENT COM
ONDITION. ANY	WATER: ALL WATERMAIN INSTALLATION, DISINFECTION AND TESTING SHALL COMPLY WITH WSDOT STANDARD SPECIFICATIONS. UNIFORM PLUMBING CODE, AND CITY OF WOODLAND WATER DESIGN AND CONSTRUCTION	4. INSTALL CAT
PUBLIC RIGHT OF WAY	STANDARDS.	5. INSTALL PER
R, SANITARY SEWER, AND	FIRE SPRINKLER: UNDERGROUND FIRE SPRINKLER SUPPLY MAINS SHALL BE INSTALLED ONLY BY CONTRACTORS IN	6. INSTALL TRE
S. CONSTRUCTION SHALL	COMPLIANCE WITH WAC 212-80	7. GRADE AND
ITIES AND STRUCTURES	ARCHAEOLOGY IF ANY CULTURAL RESOURCES AND/OR HUMAN REMAINS ARE DISCOVERED IN THE COURSE OF UNDERTAKING	8. CONSTRUCT
CES OF VARYING REVEAL THE TYPES,	THE DEVELOPMENT ACTIVITY, THE DEPARTMENT OF ARCHAEOLOGY AND HISTORIC PRESERVATION IN OLYMPIA AND COWLITZ COUNTY SHALL BE NOTIFIED. FAILURE TO COMPLY WITH THESE STATE REQUIREMENTS	9. GRADE AND
BEEN MADE TO LOCATE RIFY THE LOCATION OF ES ARE NOT SHOWN.	MAY CONSTITUTE A CLASS C FELONY, SUBJECT TO IMPRISONMENT AND/OR FINES. STANDARD DETAIL STATEMENT	10. CONSTRUC
CONTRACTOR OR BY THE	ALL MATERIALS AND METHODS OF CONSTRUCTION AND INSTALLATION FOR WATER, SEWER, STORM WATER FACILITIES, AND EROSION CONTROL MEASURES, SHALL CONFORM TO CITY OF WOODLAND ENGINEERING SERVICES "WOODLAND DEVELOPMENT GUIDELINES." CONSTRUCTION SHALL BE AS PER THE MOST CURRENT	11. MAINTAIN E FOR WESTERN
/N SHALL ONLY BE	STANDARD DETAIL CONTAINED THEREIN. GRADING & EROSION CONTROL NOTES	12. RELOCATE SO THAT AS SI
CCESS OUTSIDE OF THIS	NO GRADING WITHIN 2' OF ADJACENT PARCELS PER IBC.	WITH THE COW
2" OF COLD MIX TO	STRIP ORGANICS PER GEOTECH REPORT. RE-DEPOSIT ABOVE COMPACTED FILL TO A MAX DEPTH OF 6" (12" IN LANDSCAPE AREAS).	13. COVER ALL TWO DAYS DUI EQUIVALENT.
K ADJACENT TO THEIR	FINISH GRADE CONTOURS ARE TO TOP OF FINISHED SURFACE IN IMPERVIOUS AREAS AND TOP OF REPLACED	14. STABILIZE A
OR CRACK WITHIN 5' OF	STRIPPINGS IN PERVIOUS AREAS.	15. SEED OR SO
CH SAFETY.	STRIPPINGS TO REMAIN ON SITE AND BE RE-DISTRIBUTED OVER LANDSCAPE AREAS AFTER ALL GRADING ACTIVITIES ARE COMPLETED. CONTRACTOR SHALL BE RESPONSIBLE FOR HAUL-OFF OF EXCESS MATERIAL.	16. ALL DISTUR NEED TO BE AN CONTENT AND
ED BY THE	CUT AND FILL QUANTITIES ARE BASED ON GENERAL SITE GRADING ESTABLISHED FROM THE STRIPPED GRADE TO THE FINISHED PROPOSED SUBGRADE AND TRENCH SPOILS. THESE VOLUMES DO NOT TAKE INTO ACCOUNT ANY UNKNOWN SOIL DEPOSITS OR OVER-EXCAVATION OF NON-ORGANIC MATERIALS THAT ARE DISCOVERED	17. UPON COM
- SEPARATION BETWEEN NES, UNLESS	ANY UNKNOWN SOIL DEPOSITS OR OVER-EXCAVATION OF NON-ORGANIC MATERIALS THAT ARE DISCOVERED ON SITE, NOR WET WEATHER CONDITIONS. CONTRACTOR SHALL BE RESPONSIBLE TO PRODUCE INDEPENDENT GRADING VOLUMES AS WELL AS ACCOUNT FOR OBSERVATION OF MEASURES DIRECTED WITHIN THE GEOTECHNICAL REPORT OR AS DIRECTED BY THE GEOTECHNICAL ENGINEER DURING THE COURSE OF CONSTRUCTION.	MANAGEMENT
THE CONSTRUCTION TO	PRIOR TO ACCEPTANCE OF THE COMPACTED SUB-GRADE, THE CONTRACTOR SHALL PROVIDE A TEST ROLL IN THE PRESENCE OF OWNER / CITY REPRESENTATIVE UNLESS OTHERWISE APPROVED BY THE GEOTECHNICAL	

ENGINEER.

dgefield, WA Iluth + Minneapolis, MN vw.windsorengineers.com



THE PRESENCE OF OWNER / CITY REPRESENTATIVE UNLESS OTHERWISE APPROVED BY THE GEOTECHNICAL

DOE STANDARD NOTES FOR EROSION CONTROL PLAN

_ OF THIS EROSION/SEDIMENTATION CONTROL (ESC) PLAN DOES IENT ROAD OR DRAINAGE DESIGN (E.G. SIZE AND LOCATION OF R RETENTION FACILITIES, UTILITIES, ETC.)

MENTATIONS OF THESE ESC PLANS AND THE CONSTRUCTIONS. DING OF THESE ESC FACILITIES IS THE RESPONSIBILITY OF THE JCTION IS COMPLETED AND APPROVED AND VEGETATION/LAND

DARIES OF THE CLEARING LIMITS SHOWN ON THIS PLAN SHALL TO CONSTRUCTION. DURING THE CONSTRUCTION PERIOD, NO I EARING LIMITS SHALL BE PERMITTED. THE FLAGGING SHALL BE CONTRACTOR FOR THE DURATION OF CONSTRUCTION.

FACILITIES SHOWN ON THIS PLAN MUST BE CONSTRUCTED IN CC IG ACTIVITIES, AND IN SUCH A MANNER AS TO INSURE THAT SED NOT ENTER THE DRAINAGE SYSTEMS, ROADWAYS, OR VIOLATE A

ACILITIES SHOWN ON THIS PLAN ARE THE MINIMUM REQUIREME , DURING THE CONSTRUCTION PERIOD, THESE ESC FACILITIES CTED STORM EVENTS AND TO ENSURE THAT SEDIMENT AND SE

FACILITIES SHALL BE INSPECTED DAILY BY THE APPLICANT/CONT TO ENSURE THEIR CONTINUED FUNCTIONING.

FACILITIES ON INACTIVE SITES SHALL BE INSPECTED AND MAINT/ VITHIN THE 48 HOURS FOLLOWING A STORM EVENT.

SHALL MORE THAN ONE FOOT OF SEDIMENT BE ALLOWED TO . . ALL CATCH BASINS AND CONVEYANCE LINES SHALL BE CLEAN PERATIONS SHALL NOT FLUSH SEDIMENT LADEN WATER INTO TI

) CONSTRUCTION ENTRANCES SHALL BE INSTALLED AT THE BE FOR THE DURATION OF THE PROJECT. ADDITIONAL MEASURES S ARE KEPT CLEAN FOR THE DURATION OF THE PROJECT.

POSED STORMWATER FACILITY MUST REMAIN OFFLINE UNTIL TH I THROUGHOUT THE SITE HAS BEEN ESTABLISHED. IF AT ANY TIN WITH SEDIMENT FILLED RUNOFF, THE TOP 2" OF MATERIAL MUST ROJECT COMPLETION.

IENDED CONSTRUCTION SEQUENCE FOR E

STRUCTION MEETING.

ENCE CLEARING LIMITS

TICE OF CONSTRUCTION ACTIVITY SIGN WITH THE NAME AND PHO ONTROL SUPERVISOR.

ATCH BASIN PROTECTION, IF REQUIRED.

ERIMETER PROTECTION (SILT FENCE, BRUSH BARRIER, ETC.).

REE PROTECTION FENCING.

ID INSTALL CONSTRUCTION ENTRANCE(S).

CT SEDIMENT POND(S) AND TRAP(S).

ID STABILIZE CONSTRUCTION ROADS.

JCT SURFACE WATER CONTROLS (INTERCEPT DIKES, PIPE SLOP ING AND GRADING FOR PROJECT DEVELOPMENT.

I EROSION CONTROL MEASURES IN ACCORDANCE WITH STORM RN WASHINGTON AND MANUFACTURER'S RECOMMENDATIONS

E SURFACE WATER CONTROLS AND EROSION CONTROL MEASU SITE CONDITIONS CHANGE THE EROSION AND SEDIMENT CONT OWLITZ COUNTY EROSION AND SEDIMENT CONTROL STANDARD

LL AREAS THAT WILL BE UNWORKED FOR MORE THAN SEVEN DA URING THE WET SEASON WITH STRAW, WOOD FIBER MULCH, C

ALL AREAS THAT REACH FINAL GRADE WITHIN SEVEN DAYS.

R SOD ANY AREAS TO REMAIN UNWORKED FOR MORE THAN 30 DA URBED PERVIOUS AREAS MUST MEET BMP T5.13 IN THE 2019 MA AMENDED TO REACH APPROVED RATES, OR IMPORT TOPSOIL W

ND WIDTH. MPLETION OF THE PROJECT, ALL DISTURBED AREAS MUST BE S NT PRACTICES REMOVED IF APPROPRIATE.

748 HOMESTEAD 748 WASHINGTON STREET, WOODLAND, WA 98674

SITE PLAN REVIEW

Project No: 21035.1 Issue Date: 6/28/2023

PLAN	AMERICANS WITH DISABILITIES ACT (ADA) NOTES
ES NOT CONSTITUTE AN APPROVAL ROADS, PIPES, RESTRICTIONS,	1. CONTRACTORS SHALL EXERCISE APPROPRIATE CARE AND PRECISION IN CONSTRUCTION OF ADA ACCESSIBLE COMPONENTS ON THE PROJECT, THE ADA COMPONENTS MUST COMPLY WITH ALL LOCAL, ST AND FEDERAL ACCESSIBILITY RULES, CODES, AND REGULATIONS.
S, MAINTENANCE, REPLACEMENT, E APPLICANT/CONTRACTOR, UNTIL NDSCAPING IS ESTABLISHED.	2. FINISHED SURFACES ALONG THE ACCESSIBLE PATH OF TRAVEL FROM PARKING STALLS, PUBLIC TRANSPORTATION, AND PEDESTRIAN ACCESS WAYS TO THE POINT(S) OF ACCESSIBLE BUILDING INGRESS EGRESS SHALL COMPLY WITH ADA CODE REQUIREMENTS.
L BE CLEARLY FLAGGED IN THE D DISTURBANCE BEYOND THE E MAINTAINED BY THE	3. PARKING SPACE AND AISLE SLOPE SHALL NOT EXCEED 1:48 (1/4" PER FOOT OR NOMINALLY 2.0%) IN ANY DIRECTION.
	4. CURB RAMP SLOPE SHALL NOT EXCEED 1:12 (8.3%) AND RAMP LENGTH IS LIMITED TO 15 FEET.
CONJUNCTION WITH ALL CLEARING EDIMENT AND SEDIMENT LADEN E APPLICABLE WATER STANDARDS.	5. LANDINGS SHALL BE PROVIDED AT EACH END OF RAMPS, SHALL HAVE POSITIVE DRAINAGE, AND SHALL EXCEED 1:48 (1/4"PER FOOT OR NOMINALLY 2.0%) IN ANY DIRECTION.
MENTS FOR ANTICIPATED SITE S SHALL BE UPGRADED AS NEEDED SEDIMENT LADEN WATER DO NOT	6. PATH OF TRAVEL ALONG ACCESSIBLE ROUTE SHALL PROVIDE A MINIMUM OF 36 INCH UNOBSTRUCTED WIDTH OF TRAVEL. SLOPE SHALL BE NO GREATER THAN 1:20 (5.0% OR 5/8" PER FOOT) IN THE DIRECTION OF TRAVEL, AND SHALL NOT EXCEED 1:48 (1/4" PER FOOT OR NOMINALLY 2.0%) IN CROSS SLOPE. WHERE PAT TRAVEL BE GREATER THAN 1:20 (5.0%), AN ACCESSIBLE RAMP WITH A MAXIMUM SLOPE OF 1:12 (8.3%) FOR MAXIMUM DISTANCE OF 30 FEET SHALL BE PROVIDED INCLUDING HANDRAILS. THE RAMP SHALL HAVE ACCESSIBLE HAND RAILS AND LANDINGS ON EACH END WITH A SLOPE IN ANY DIRECTION NOT EXCEEDING
NTRACTOR AND MAINTAINED AS	(1/4" PER FOOT OR NOMINALLY 2.0%).
TAINED A MINIMUM OF ONCE A	7. DOORWAYS SHALL HAVE A LANDING AREA ON THE EXTERIOR SIDE OF THE DOOR THAT IS SLOPED NO M THAN 1:48 (1/4" PER FOOT OR NOMINALLY 2.0%) FOR POSITIVE DRAINAGE. THIS LANDING AREA SHALL BE N LESS THAN 60 INCHES (5 FEET) LONG, EXCEPT HERE OTHERWSE PERMITTED BY ACCESSIBILITY STANDARI FOR ALTERNATIVE DOORWAY OPENING CONDITIONS AND APPROVED BY THE OWNER'S REPRESENTATIVE.
O ACCUMULATE WITHIN A TRAPPED ANED PRIOR TO PAVING. THE THE DOWNSTREAM SYSTEM.	8. WHERE PEDESTRIAN ACCESS ROUTES ARE CONTAINED WITHIN A STREET OR HIGHWAY RIGHT-OF-WAY, GRADE OF THE PEDESTRIAN ACCESS ROUTE IS PERMITTED TO EQUAL THE GENERAL GRADE ESTABLISHED FOR THE ADJACENT STREET OR HIGHWAY, EXCEPT THAT WHERE PEDESTRIAN ACCESS ROUTES ARE
EGINNING OF CONSTRUCTION AND S MAY BE REQUIRED TO ENSURE ALL	CONTAINED WITHIN PEDESTRIAN STREET CROSSINGS A MAXIMUM GRADE OF 5 PERCENT IS REQUIRED. (EXCERPT FROM PROWAG)
THE PROJECT IS COMPLETE AND	GENERAL FIRE NOTES
TIME THE FACILITY BECOMES ST BE REMOVED AND REPLACED	1. GENERAL FIRE SAFETY PRECAUTIONS SHALL BE MAINTAINED, IN ACCORDANCE WITH CHAPTER 33 OF TH INTERNATIONAL FIRE CODE; FIRE SAFETY DURING CONSTRUCTION
EROSION CONTROL	2. ALL WORK SUBJECT TO FIELD INSPECTION AND CORRECTION(S) AS IDENTIFIED AT THE TIME OF THE ON INSPECTION; ALL WORK SHALL BE COMPLIANT WITH THE APPLICABLE STANDARDS AND CODES; TO INCLUE THE ADOPTED EDITION OF THE INTERNATIONAL FIRE CODE AND THE CITY'S MUNICIPAL CODE.
	3. ALL FIRE ALARM AND FIRE SPRINKLERS SHALL BE SUBMITTED SEPARATELY AND DIRECTLY TO THE FIRE MARSHAL.
HONE NUMBER OF EROSION	4. MODIFICATIONS FOR FUTURE TENANT IMPROVEMENT(S) MAY REQUIRE AN ALTERNATE PLANS RE-SUBMITTAL.
	5. APPENDIX D FOR FIRE APPARATUS ACCESS ROADSALL ON-SITE PRIVATE UNDERGROUND FIRE SUPPRESSION WATER SUPPLY SHALL BE SUBMITTED TO THE FIRE MARSHAL (THIS INLCUDES PRIVATE HYDRANTS, UNDERGROUND FOR FDC'S AND FIRE SPRINKLER UNDERGROUND CONNECTIONS).
	6. IFC APPENDIX D FIRE APPARATUS ACCESS ROADS. WHERE HYDRANTS ARE ON A FIRE APPARATUS ACCER ROAD, THE MINIMUM WITH OF THE ROAD SHALL BE 26 FEET FOR A DISTANCE OF 20 FEET; 10 FEET IN EITHE DIRECTION.
OPE DRAINS, ETC) SIMULTANEOUSLY	7. IFC 503.3 MARKING WHERE REQUIRED BY THE FIRE CODE OFFICIAL, APPROVED SIGNS OR OTHER APPRONUM NOTICES OR MARKINGS THAT INCLUDE THE WORDS NO PARKING FIRE LANE SHALL BE PROVIDED FOR FIRE APPARATUS ACCESS ROADS TO IDENTIFY SUCH ROADS OR PROHIBIT THE OBSTRUCTION THEREOF. THE MEANS BY WHICH FIRE LANES ARE DESIGNATED SHALL BE MAINTAINED IN A CLEAN AND LEGIBLE CONDITION AT ALL TIMES AND BE REPLACED OR REPAIRED WHEN NECESSARY TO PROVIDE ADEQUATE VISIBILITY.
MWATER MANAGEMENT MANUAL	8. IFC D103.6 FIRE APPARATUS ACCESS PARKING RESTRICTIONSSIGNS: REQUIRED ROADWAYS MUST HAV SIGNAGE FOR PARKING RESTRICTIONS AS FOLLOWS: SIGNS FOR NO-PARKINGFIRE LANE SHALL COMPLY
SURE OR INSTALL NEW MEASURES TROL IS ALWAYS IN ACCORDANCE DS.	A MINIMUM DIMENSION OF 12 INCHES WIDE BY 18 INCHES HIGH AND HAVE RED LETTERS ON A WHITE REFLECTIVE BACKGROUND. SIGN'S SHALL BE PROVIDED ON BOTH SIDES OF ALL STREETS THAT ARE LESS THAN 26 IN WIDTH IN ACCORDANCE WITH LOCAL STANDARDS FOR ACCESS AND FUTURE ENFORCEMENT; SIGNS FOR NO-PARKING MUST BE PROVIDED ON ONE SIDE OF ALL STREETS THAT ARE BETWEEN 26 AND 3 WIDTH ACCORDANCE WITH LOCAL STANDARDS FOR ACCESS AND FUTURE ENFORCEMENT.
DAYS DURING THE DRY SEASON OR COMPOST, PLASTIC SHEETING OR	9. IFC 506 WHERE REQUIRED ACCESS IS RESTRICTED WITH A GATE, AN APPROVED PADLOCK OR KEY SWIT (FOR ELECTRONIC/AUTOMATED GATES) SHALL BE PROVIDED TO ALLOW FIRE DEPARTMENT ACCESS.
DAYS.	10. IFC 503.1.1 / D102 / D103 ROADWAYS TO ACCESS STRUCTURES: THE PERIMETER OF ALL STRUCTURES IN BE WITHIN 150 FEET OF AN APPROVED ACCESS ROAD WITH A MINIMUM CLEAR WIDTH OF 20 FEET (26 FEET WHERE A HYDRANT IS LOCATED). BUILDING SHALL BE INSTALLED WITH AUTOMATIC FIRE SPRINKLERS AS A ALTERNATIVE TO DISTANCE FROM A FIRE ACCESS ROAD.
ANUAL. EXISTING TOPSOIL MAY WITH SUFFICIENT ORGANIC	11. IFC 507.5.4 FIRE PROTECTION WATER SUPPLY: UNOBSTRUCTED ACCESS TO FIRE HYDRANTS SHALL BE MAINTAINED AT ALL TIMES. THE FIRE DEPARTMENT SHALL NOT BE DETERRED OR HINDERED FROM GAININ IMMEDIATE ACCESS TO FIRE PROTECTION EQUIPMENT OR FIRE HYDRANTS REQUIRED ACCESS ROADWAY AND HYDRANTS SHALL BE SERVICEABLE AND UNOBSTRUCTED PRIOR TO COMBUSTIBLE CONSTRUCTION.
STABILIZED AND BEST	<u>GENERAL UTILITY SHEET NOTES:</u>

1. MARK CURB AND GUTTER WITH A "W" OR "S" TO SHOW LOCATION OF UTILITY SERVICE LINE CROSSINGS.

SANITARY SEWER DETAILS - SHEET C604. WATER DETAILS - SHEET C604.

CIVIL NOTES AND ABBREVIATIONS

AMEDICANG WITH DIGABILITIES ACT (ADA) NOTES


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GENERAL UTILITY SHEET NOTES:

2. SEE DETAIL SHEETS FOR CONSTRUCTION DETAILS

G002



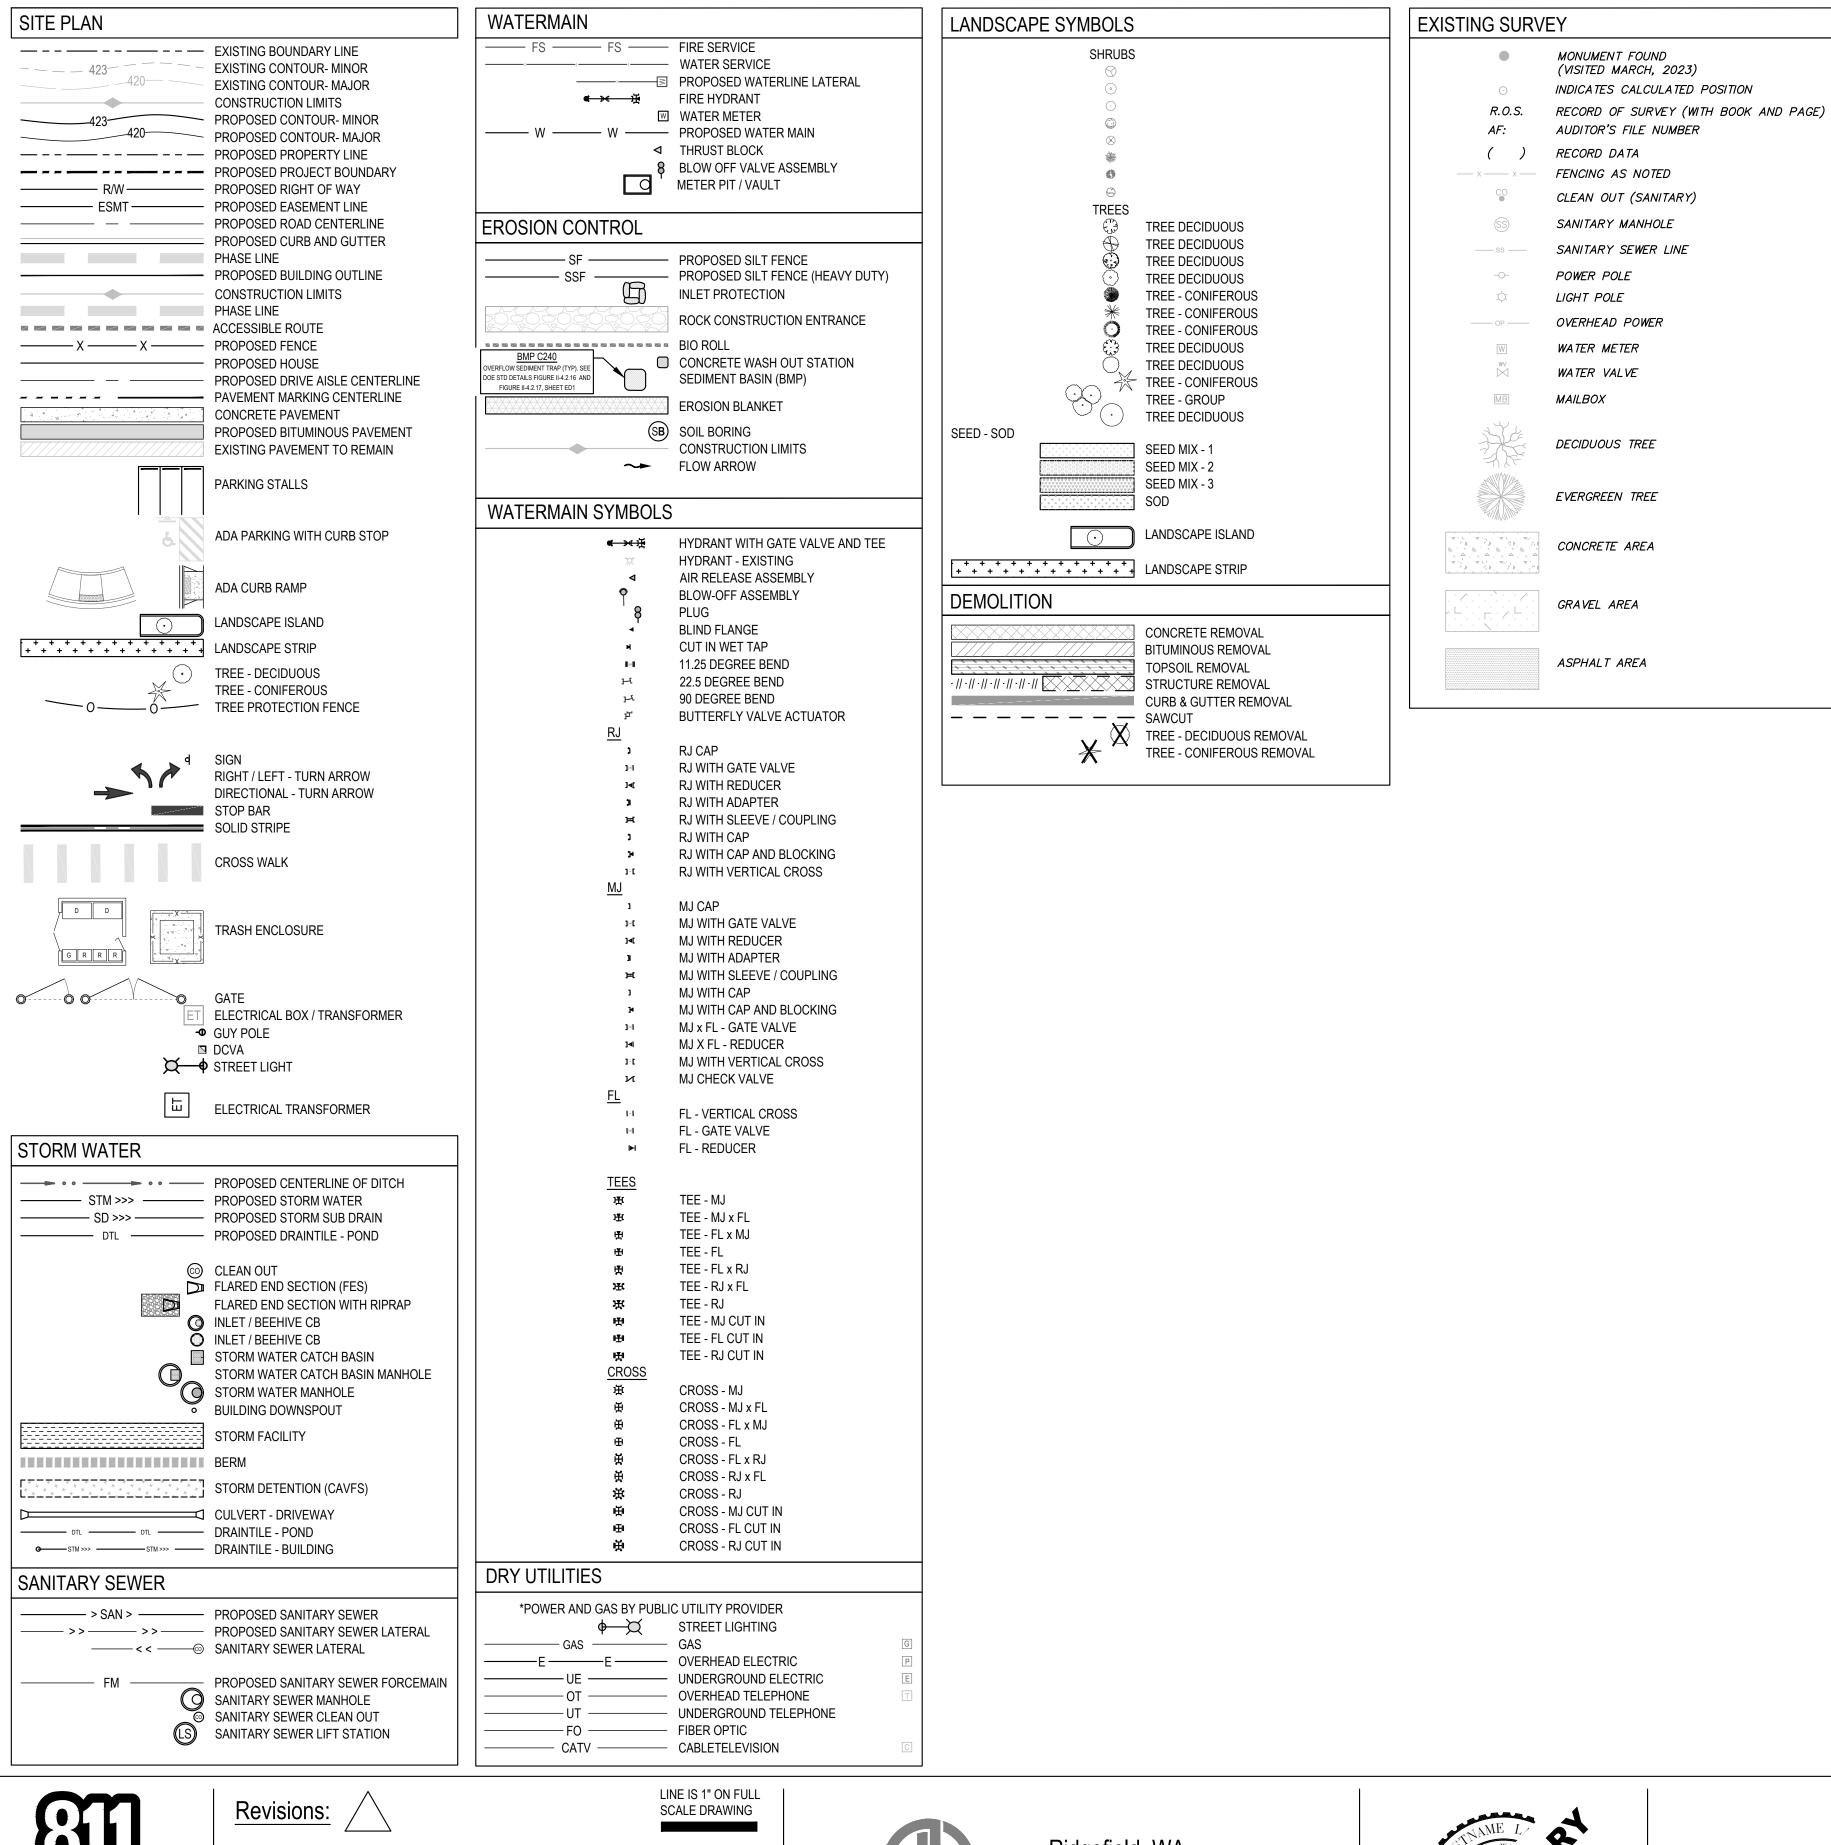

WINDSOR

ENGINEERS

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(E)	EXISTING
С	CONCRETE
СВ	CATCH BASIN
CL	CENTERLINE
CNS	COMPACTED NATIVE SOIL
со	CLEAN OUT
CR	CURB RETURN
D	DIRT / DRAINAGE
FG	FINISHED GRADE
FH	FIRE HYDRANT
FL	FLOW LINE
FM	FORCE MAIN
G	NATURAL GAS (LOW PRESSURE)
GB	GRADE BREAK
HP	HIGH POINT
LF	LINEAR FOOT
LP	LOW POINT
MG	NATURAL GAS (MEDIUM PRESSURE)
MG	MATCH EXISTING GRADE
MH	MANHOLE
NS	NATIVE SOIL
NTS	NOT TO SCALE
Р	PAVEMENT
PC	POINT OF CURVATURE
POC	POINT OF CONNECTION
POS	POINT OF SERVICE
PP	POWER POLE
PT	POINT OF TANGENCY
R	RADIUS
ROW	RIGHT OF WAY
S	SLOPE / SANITARY
SAN	SEWER SEWER
SSMH	SANITARY MANHOLE
STA	STATION
STM	STORM DRAIN
STMH	STORM MANHOLE
TBD	TO BE DETERMINED
TBL	TO BE RELOCATED BY RESPECTIVE UTILIT
TBR	TO BE REMOVED BY CONTRACTOR
тс	TOP OF CURB
TOE	TOE OF BANK

- TOE TOE OF BANK
- TOP TOP OF BANK
- TP TELEPHONE POLE
- U UNDERGROUND
- VIP VERIFY IN FIELD PRIOR TO CONSTRUCTION
- W WATER MAIN

SITE - ABBREVIATIONS

FFE - FIRST FLOOR FINISH ELEVATION LLE - LOWER LEVEL FINISH ELEVATION WO - WALKOUT LO - LOOKOUT

GRADING LEGEND / ABBREVIATIONS

TC: 391.49 FL: 390.99

TW: 391.49 BW: 380.99

GB: GRADE BREAK

LP: LOW POINT HP: HIGH POINT FC: FLUSH CURB MG: MATCH GRADE FL: FLOWLINE SW: SIDEWALK TC: TOP OF CURB FG: FINISH GRADE (DEFAULT- IF NOT LABELED)

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SITE PLAN REVIEW

Project No: 21035.1 Issue Date: 6/28/2023


Project Manager <u>DCK</u> Drawn by <u>CKJ / OK</u> Checked by <u>TWT</u>


G003

LEGENDS

PLAN SITE FOR ISSUED


REVIEW

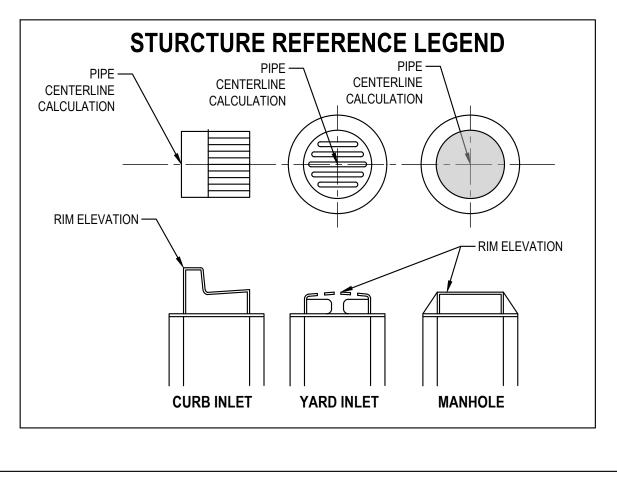

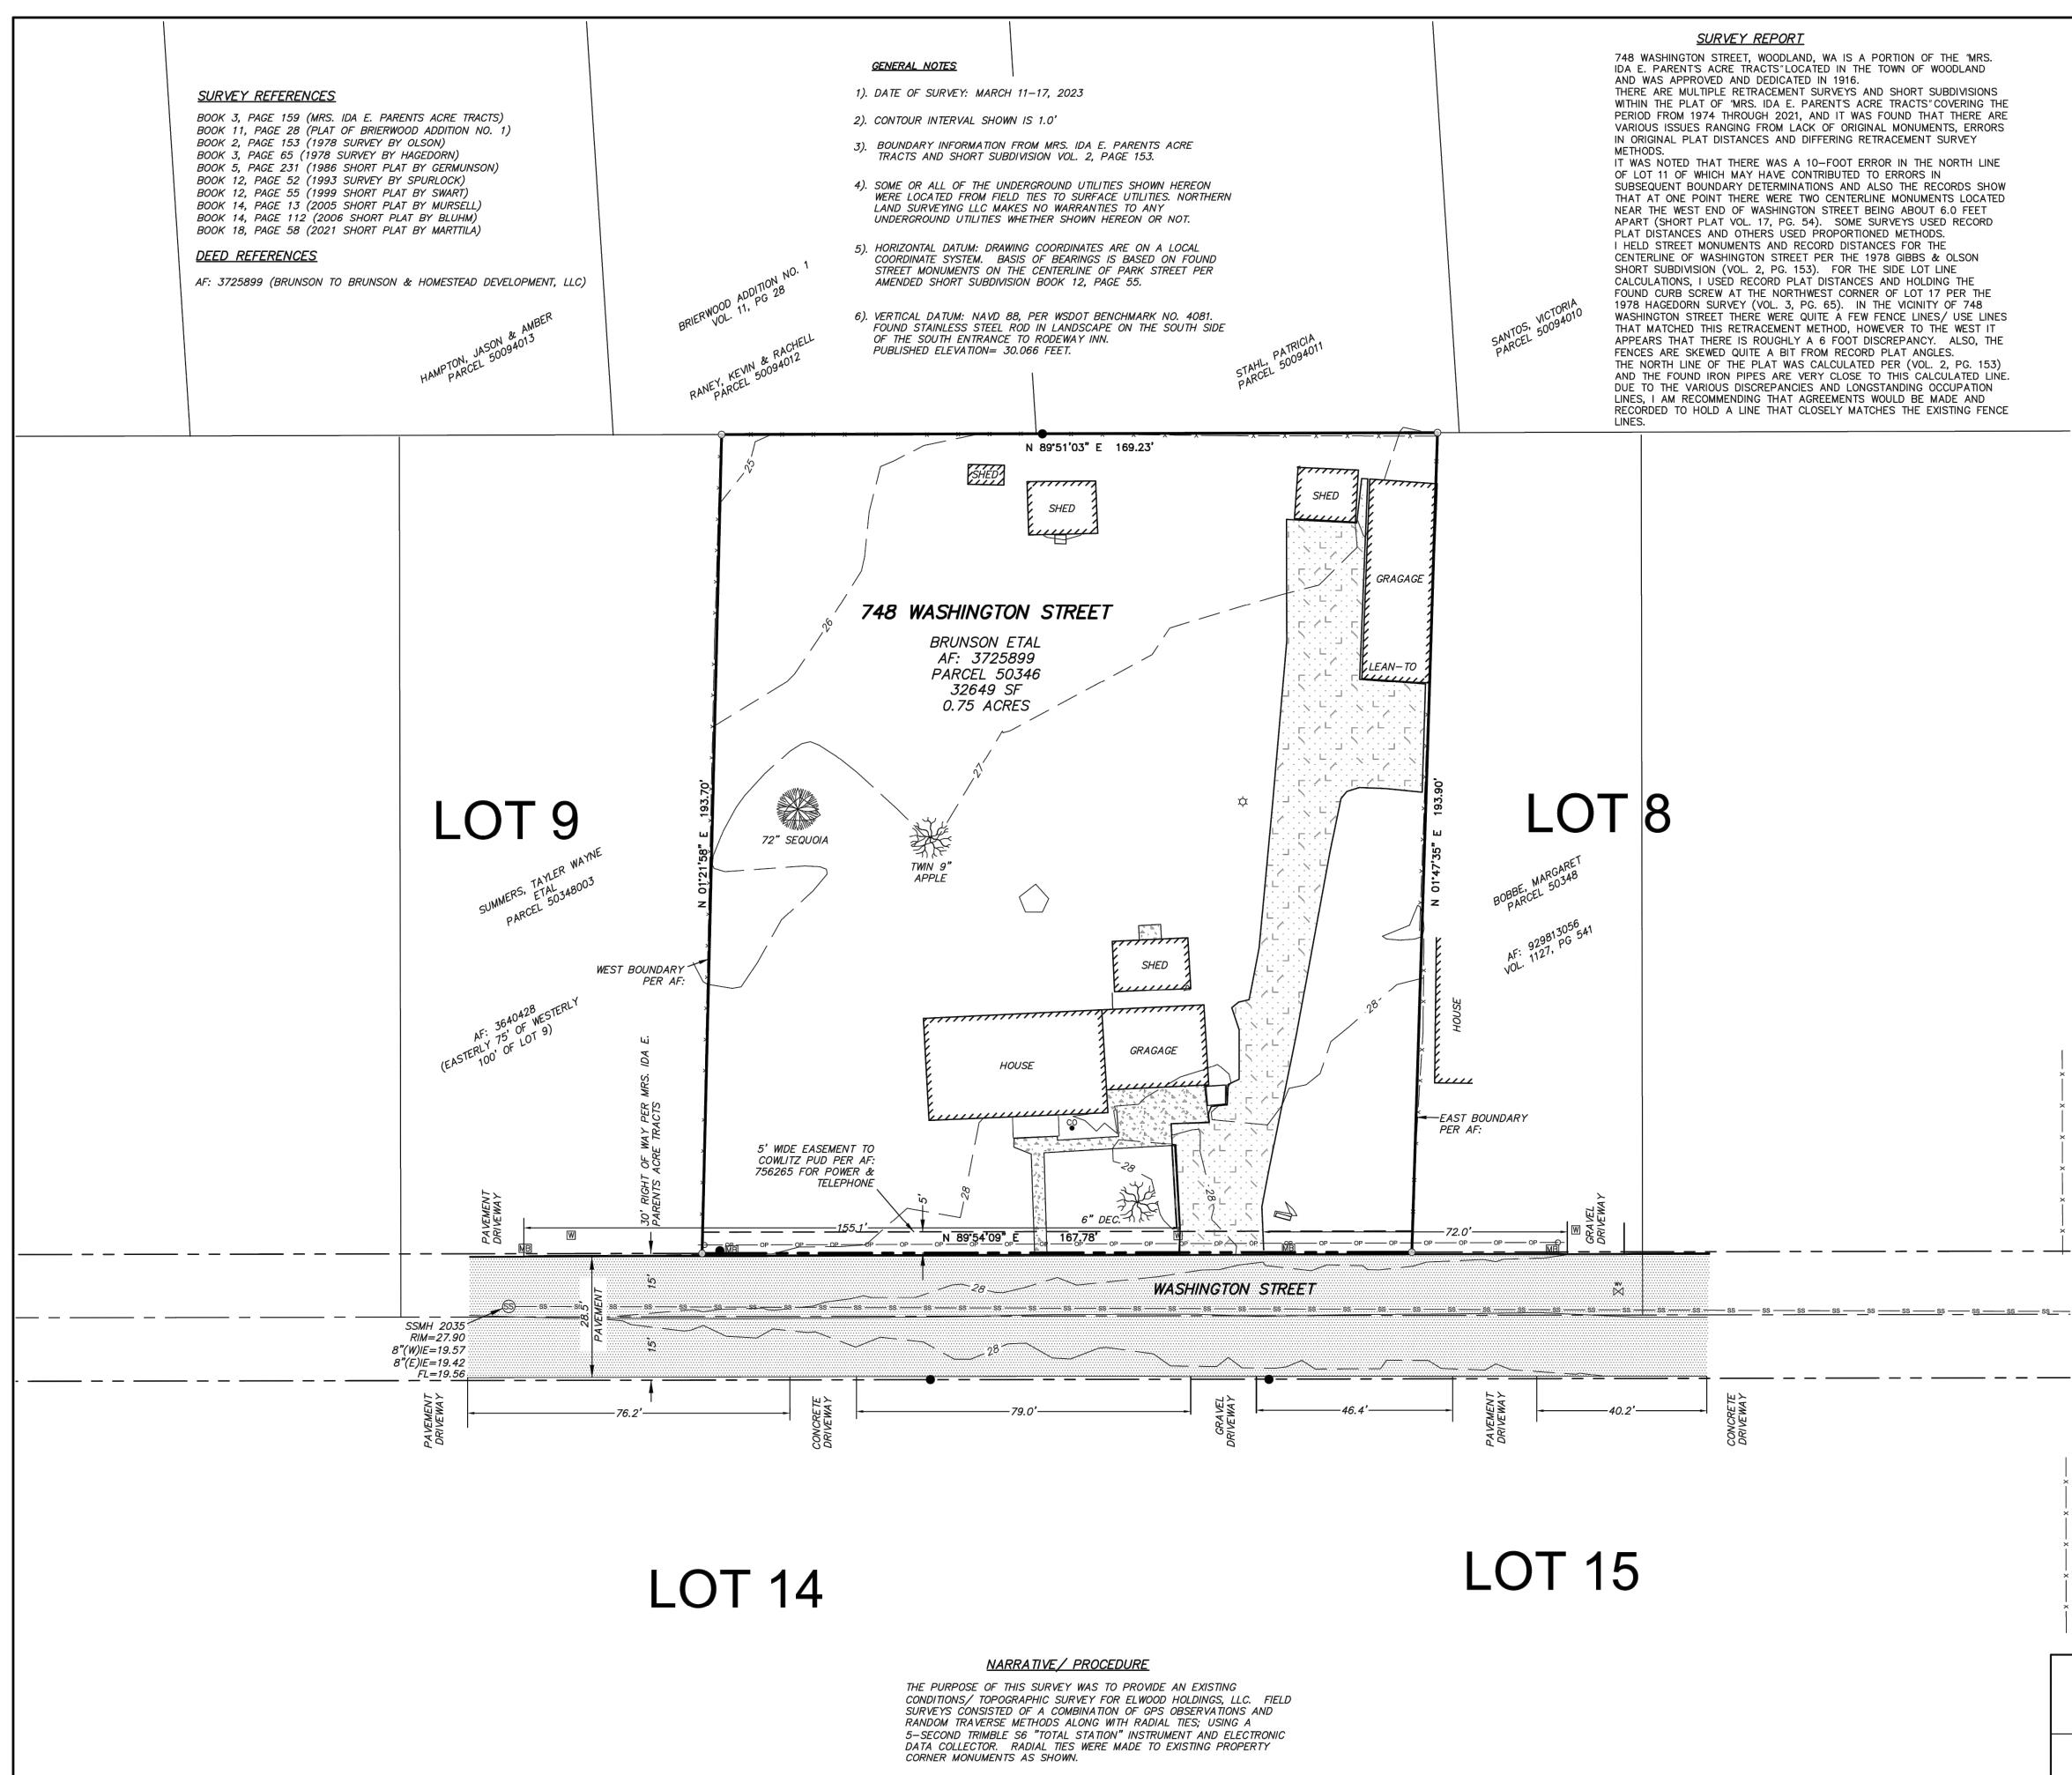

EXISTING CONDITIONS SURVEY for ELWOOD HOLDINGS, LLC

A PORTION OF LOTS 8 & 9 OF MRS. IDA E. PARENT'S ACRE TRACTS IN THE TOWN OF WOODLAND, WASHINGTON IN A PORTION OF THE S&M BOZARTH D.L.C. IN SECTION 24, T5N, R1W, W.M. COWLITZ COUNTY, WA

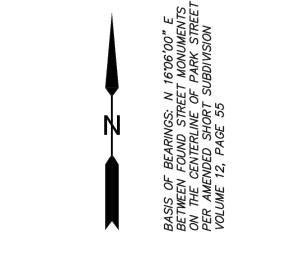




1"=20'

<u>LEGEND</u>

•	MONUMENT FOUND (VISITED MARCH, 2023)
\odot	INDICATES CALCULATED POSITION
R.O.S.	RECORD OF SURVEY (WITH BOOK AND PAGE)
AF:	AUDITOR'S FILE NUMBER
()	RECORD DATA
x x	FENCING AS NOTED
co	CLEAN OUT (SANITARY)
S	SANITARY MANHOLE
ss	SANITARY SEWER LINE
-0-	POWER POLE
¢	LIGHT POLE
OP	OVERHEAD POWER
W	WATER METER
₩ ¥	WATER VALVE
MB	MAILBOX
X	DECIDUOUS TREE
	EVERGREEN TREE
	CONCRETE AREA
	GRAVEL AREA
	ASPHALT AREA

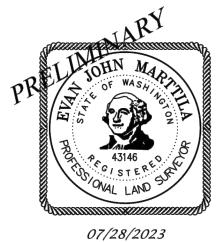

TE PLAN REVIEW

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SSU

EXISTING CONDITIONS




P.O. Box 2017 Battle Ground, WA 98604 360.553.5992

ELWOOD HOLDINGS, LLC Drawn By: Checked E


By: EJM Sca	le: 1"=20'

EXISTING CONDITIONS SURVEY


for

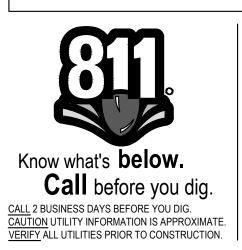

Re	visions	<u>:</u> \triangle	

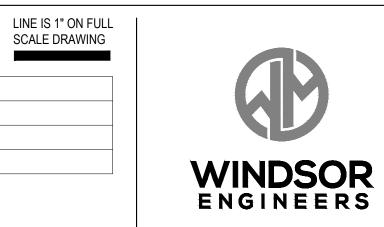

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DEMOLITION PLAN

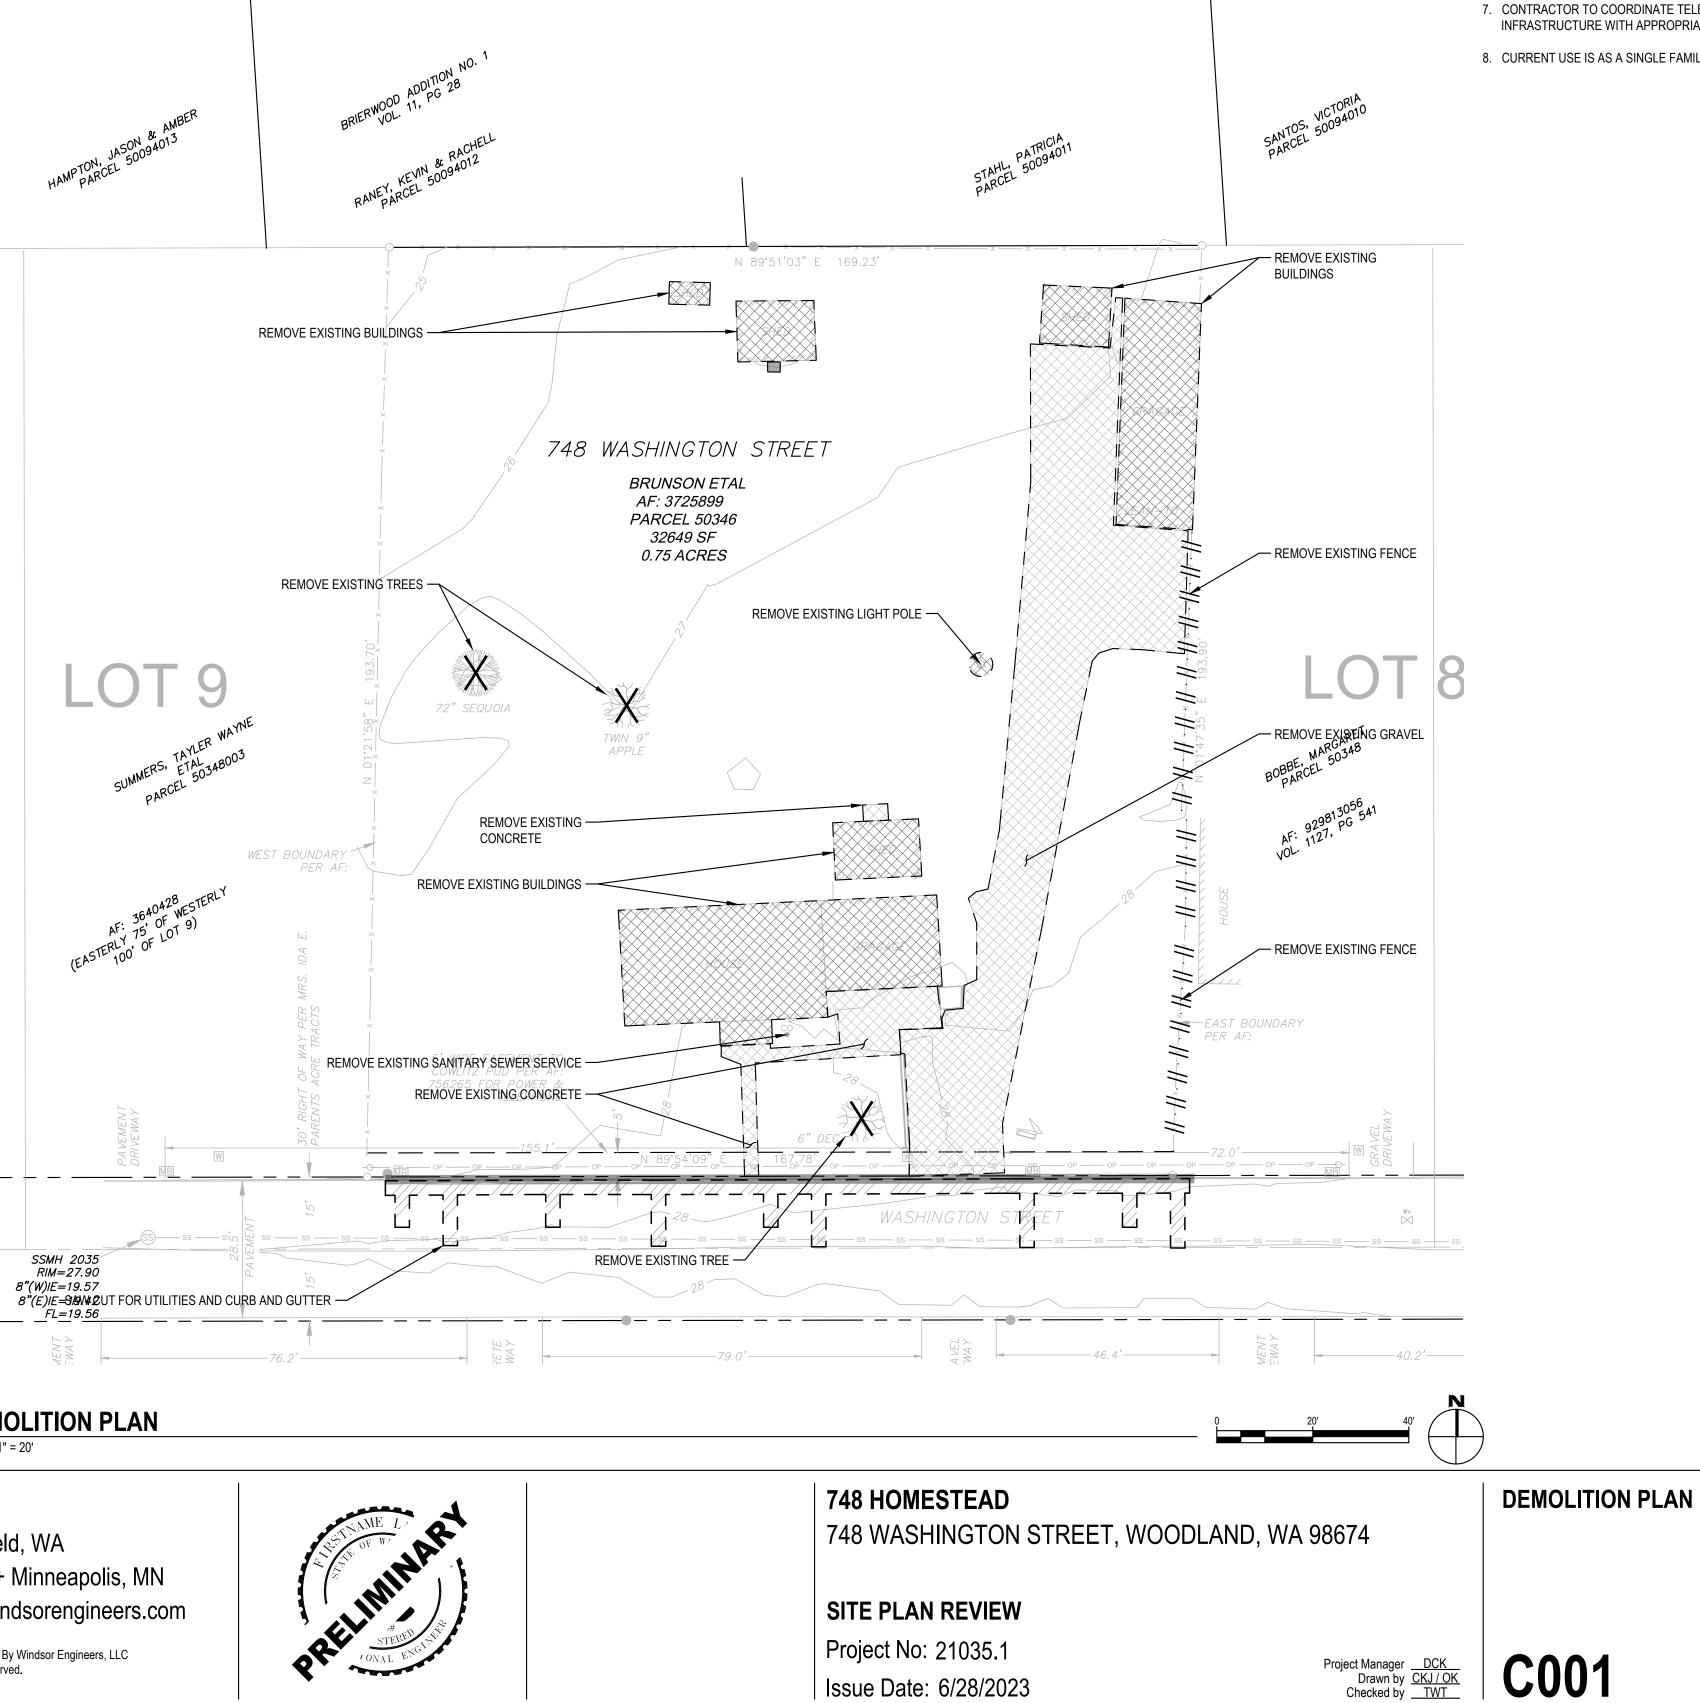SCALE: 1" = 20'

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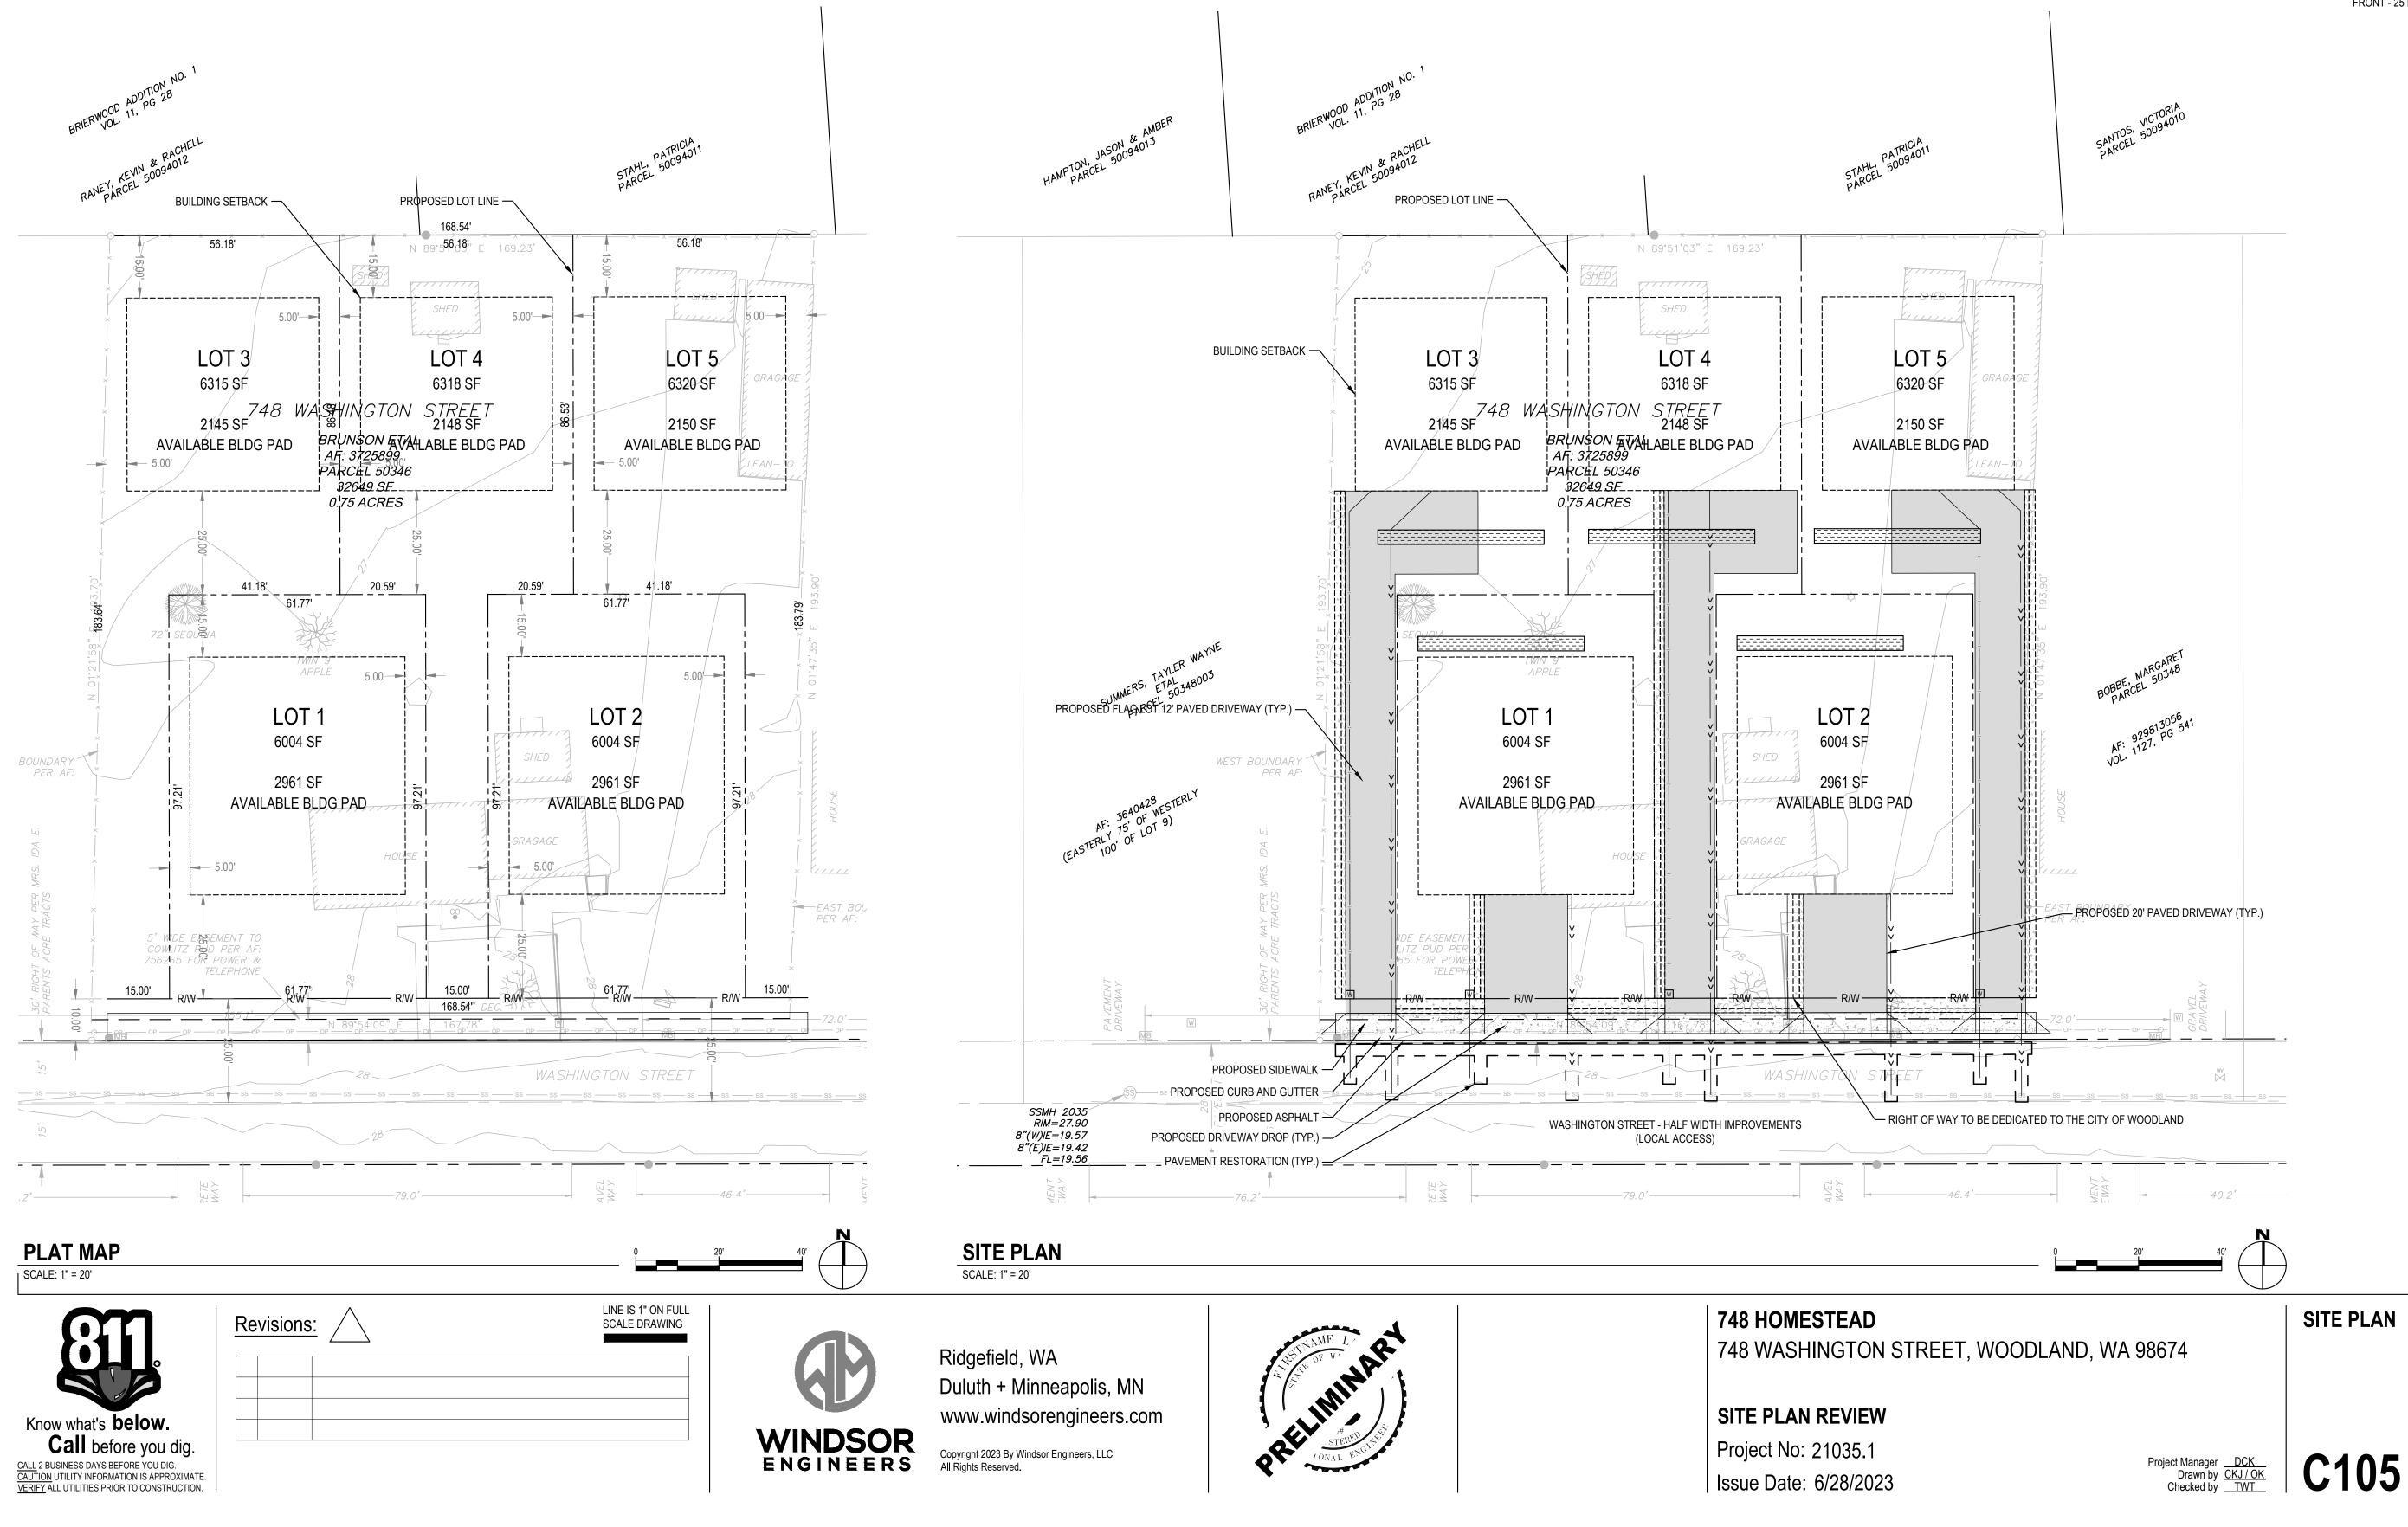
Issue Date: 6/28/2023

GENERAL SHEET NOTES:

- 1. SEE SHEET G002 FOR PROJECT NOTES.
- 2. CONTRACTOR TO VERIFY ALL UTILITY LOCATIONS AND DEPTHS PRIOR TO CONSTRUCTION.
- 3. CONTRACTOR TO TAKE PRECAUTIONS TO PROTECT UNDERGROUND UTILITIES.
- 4. CONTRACTOR TO ONLY REMOVE EXISTING VEGETATION AS NECESSARY TO COMPLETE THE WORK.
- 5. NO CONSTRUCTION WORK SHALL BEGIN PRIOR TO A PRECONSTRUCTION MEETING CONFERENCE WITH A PUBLIC WORKS AND A BUILDING INSPECTIONS REPRESENTATIVE.
- 6. CONTRACTOR TO DISPOSE OF EXISTING TREES, SHRUBS, AND OTHER DEMOLITION DEBRIS IN AN ACCEPTABLE MANNER OF THE CONTRACTOR'S CHOOSING
- 7. CONTRACTOR TO COORDINATE TELECOM LINES, POWER LINES, AND ASSOCIATED INFRASTRUCTURE WITH APPROPRIATE UTILITY COMPANY.


ISSUED FOR SITE PLAN REVIEW


8. CURRENT USE IS AS A SINGLE FAMILY HOME, GARAGE AND STORAGE.



NOTES:

- 1. SEE SHEETS #### AND ####, CIVIL NOTES, LEGENDS AND ABBREVIATIONS.
- 2. SIDEWALK PER CITY OF WOODLAND DETAIL T-07.
- 3. CURB AND GUTTER PER CITY OF WOODLAND DETAIL T-01.
- 4. STREET FRONTAGE IMPROVEMENTS PER CITY OF WOODLAND DETAIL T-27.
- 5. DRIVEWAY APPROACH PER CITY OF WOODLAND DETAIL T-05.
- 6. STREET SECTION PER CITY OF WOODLAND DETAIL T-27.
- 7. MAXIMUM LOT COVERAGE: 50%
- 8. INTERIOR LOT SET BACKS:
 - REAR 15 FEET SIDE - 5 FEET
 - FRONT 25 FEET

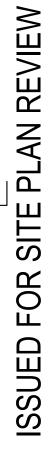


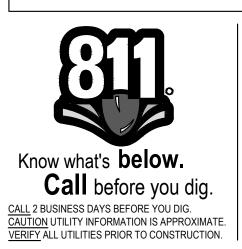

-	Re	visions	



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SITE PLAN REVIEW Project No: 21035.1 Issue Date: 6/28/2023

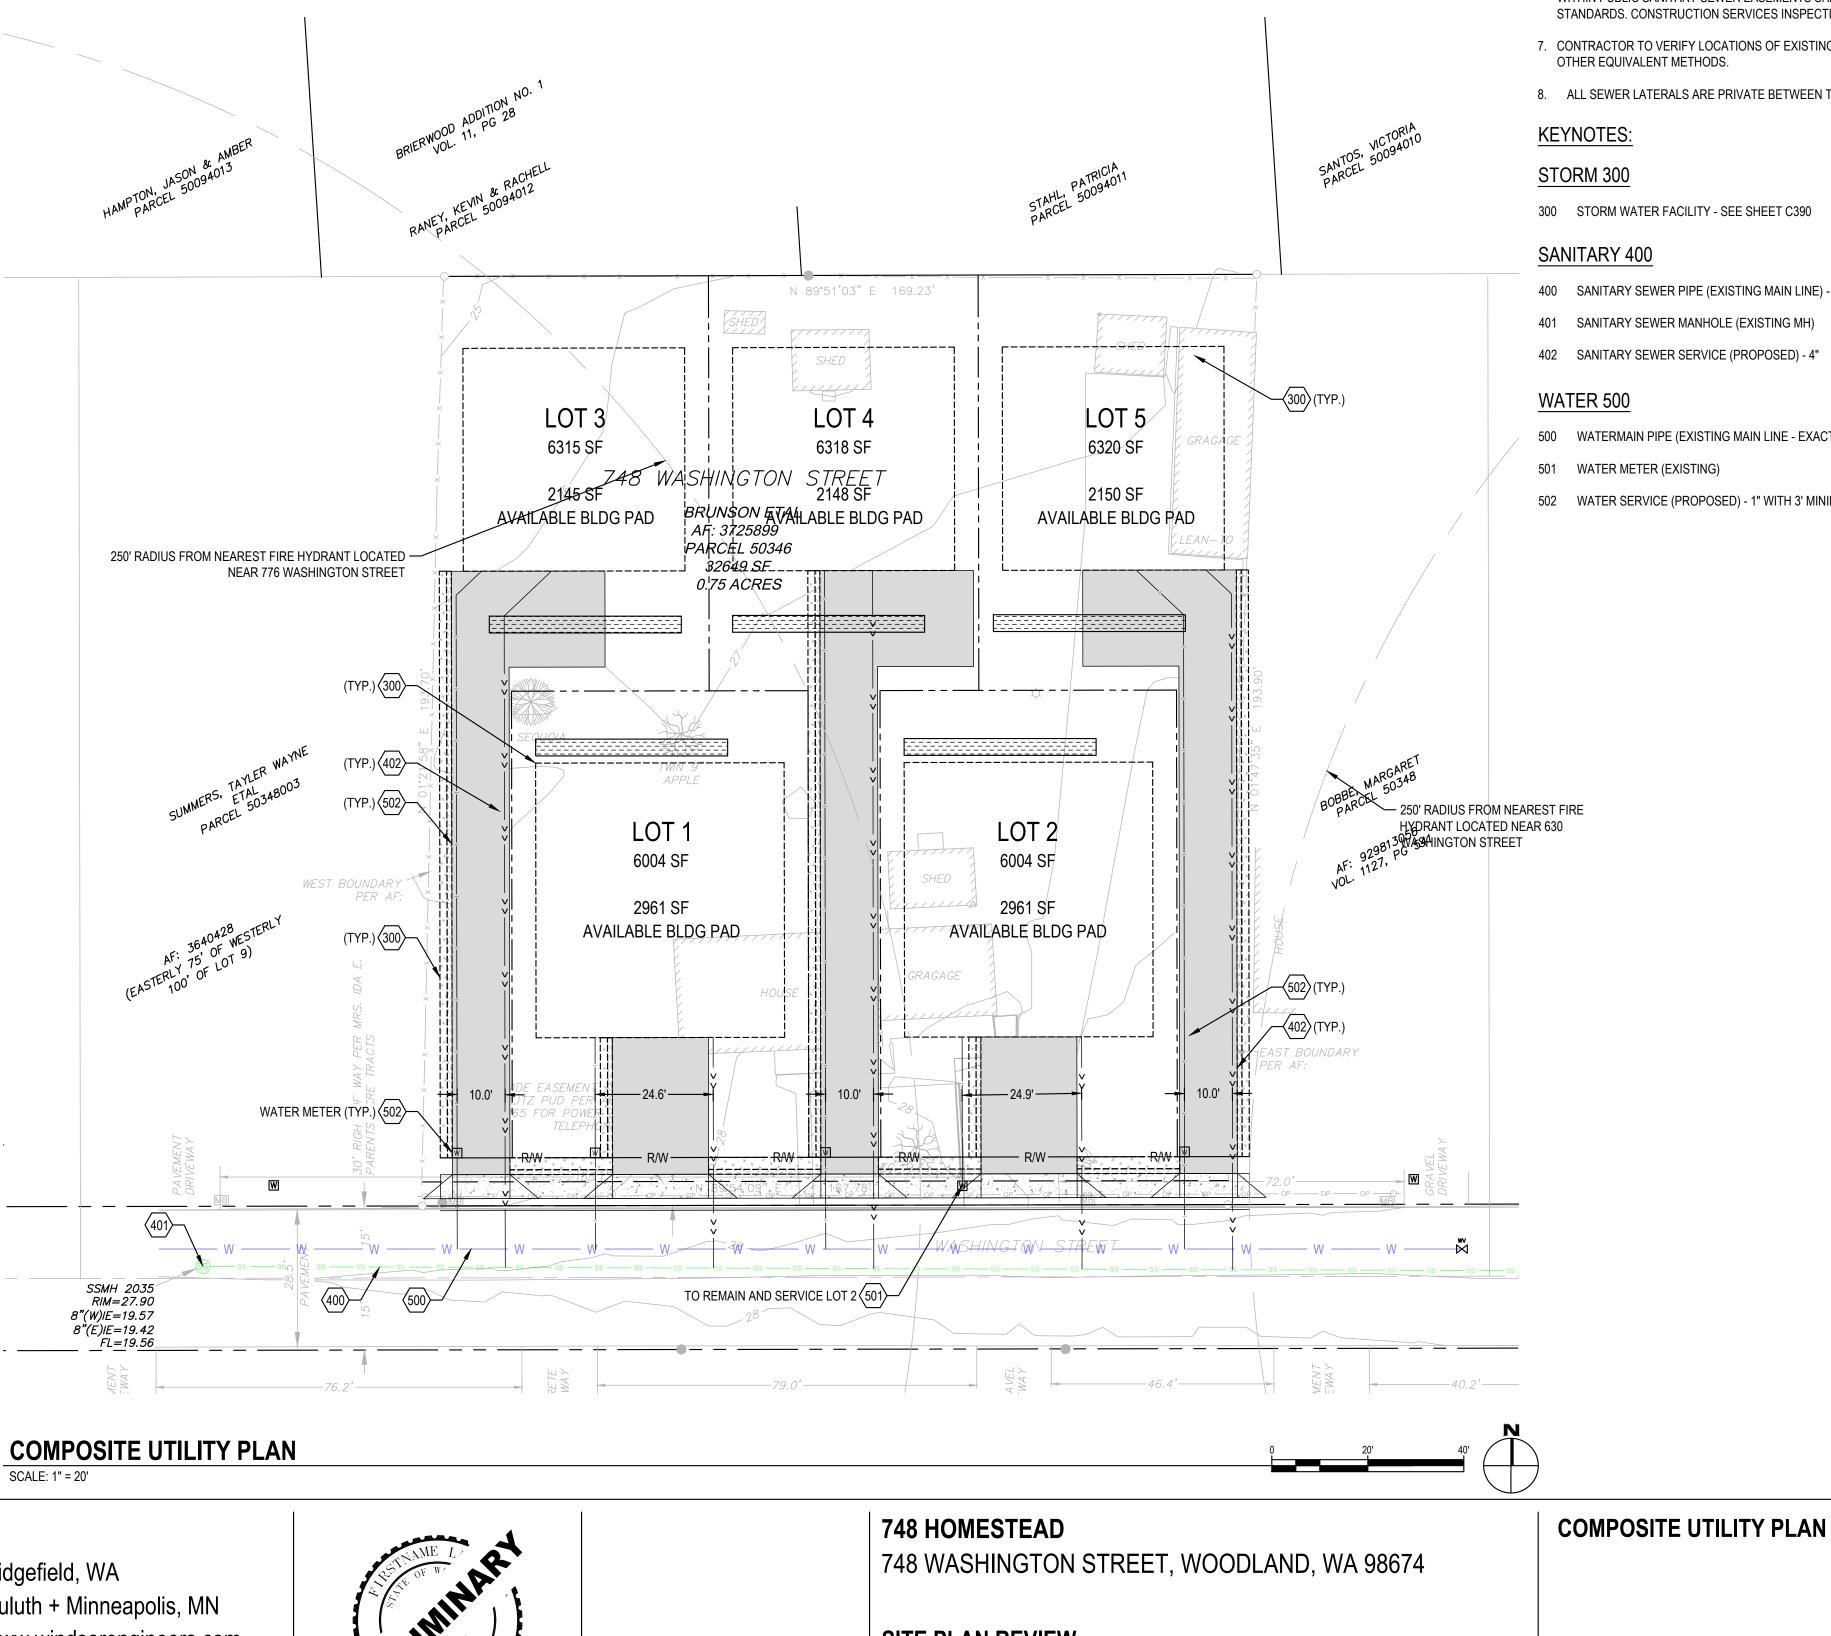GENERAL UTILITY SHEET NOTES:

- 1. MARK CURB AND GUTTER WITH A "W" OR "S" TO SHOW LOCATION OF UTILITY SERVICE LINE CROSSINGS.
- 2. SEE DETAIL SHEETS FOR CONSTRUCTION DETAILS
- 3. STORMWATER DETAILS SHEET ####. SANITARY SEWER DETAILS - SHEET ####. WATER DETAILS - SHEET ####.
- 4. SEE SHEET #### AND ####, CIVIL NOTES, LEGENDS AND ABBREVIATIONS.
- 5. MAINTAIN 18" MIN. VERTICAL SEPARATION AND 10' MIN. HORIZONTAL SEPARATION BETWEEN WATER UTILITY AND SANITARY SEWER (TYP.)
- 6. SERVICE LATERAL CONSTRUCTION: SERVICE LATERAL CONNECTIONS AND PIPING WITHIN PUBLIC SANITARY SEWER EASEMENTS SHALL BE CONSTRUCTED TO PUBLIC STANDARDS. CONSTRUCTION SERVICES INSPECTIONS REQUIRED.
- 7. CONTRACTOR TO VERIFY LOCATIONS OF EXISTING UTILITIES USING POT HOLING OR OTHER EQUIVALENT METHODS.
- 8. ALL SEWER LATERALS ARE PRIVATE BETWEEN THE PROPERTY LINE AND BUILDING

KEYNOTES:

STORM 300

300 STORM WATER FACILITY - SEE SHEET C390

SANITARY 400

- 400 SANITARY SEWER PIPE (EXISTING MAIN LINE) 8"
- 401 SANITARY SEWER MANHOLE (EXISTING MH)
- 402 SANITARY SEWER SERVICE (PROPOSED) 4"


WATER 500

Project Manager <u>DCK</u> Drawn by <u>CKJ / OK</u> Checked by <u>TWT</u>

C106

- 500 WATERMAIN PIPE (EXISTING MAIN LINE EXACT LOCATION UNKNOWN) 6"
- 501 WATER METER (EXISTING)
- 502 WATER SERVICE (PROPOSED) 1" WITH 3' MINIMUM DEPTH.

ISSUED FOR SITE PLAN REVIEW

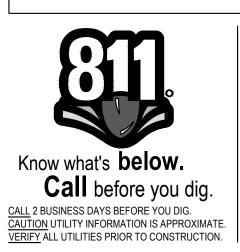


Re	visions	<u>:</u> \triangle	

LINE IS 1" ON FULL SCALE DRAWING



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EROSION CONTROL PLAN

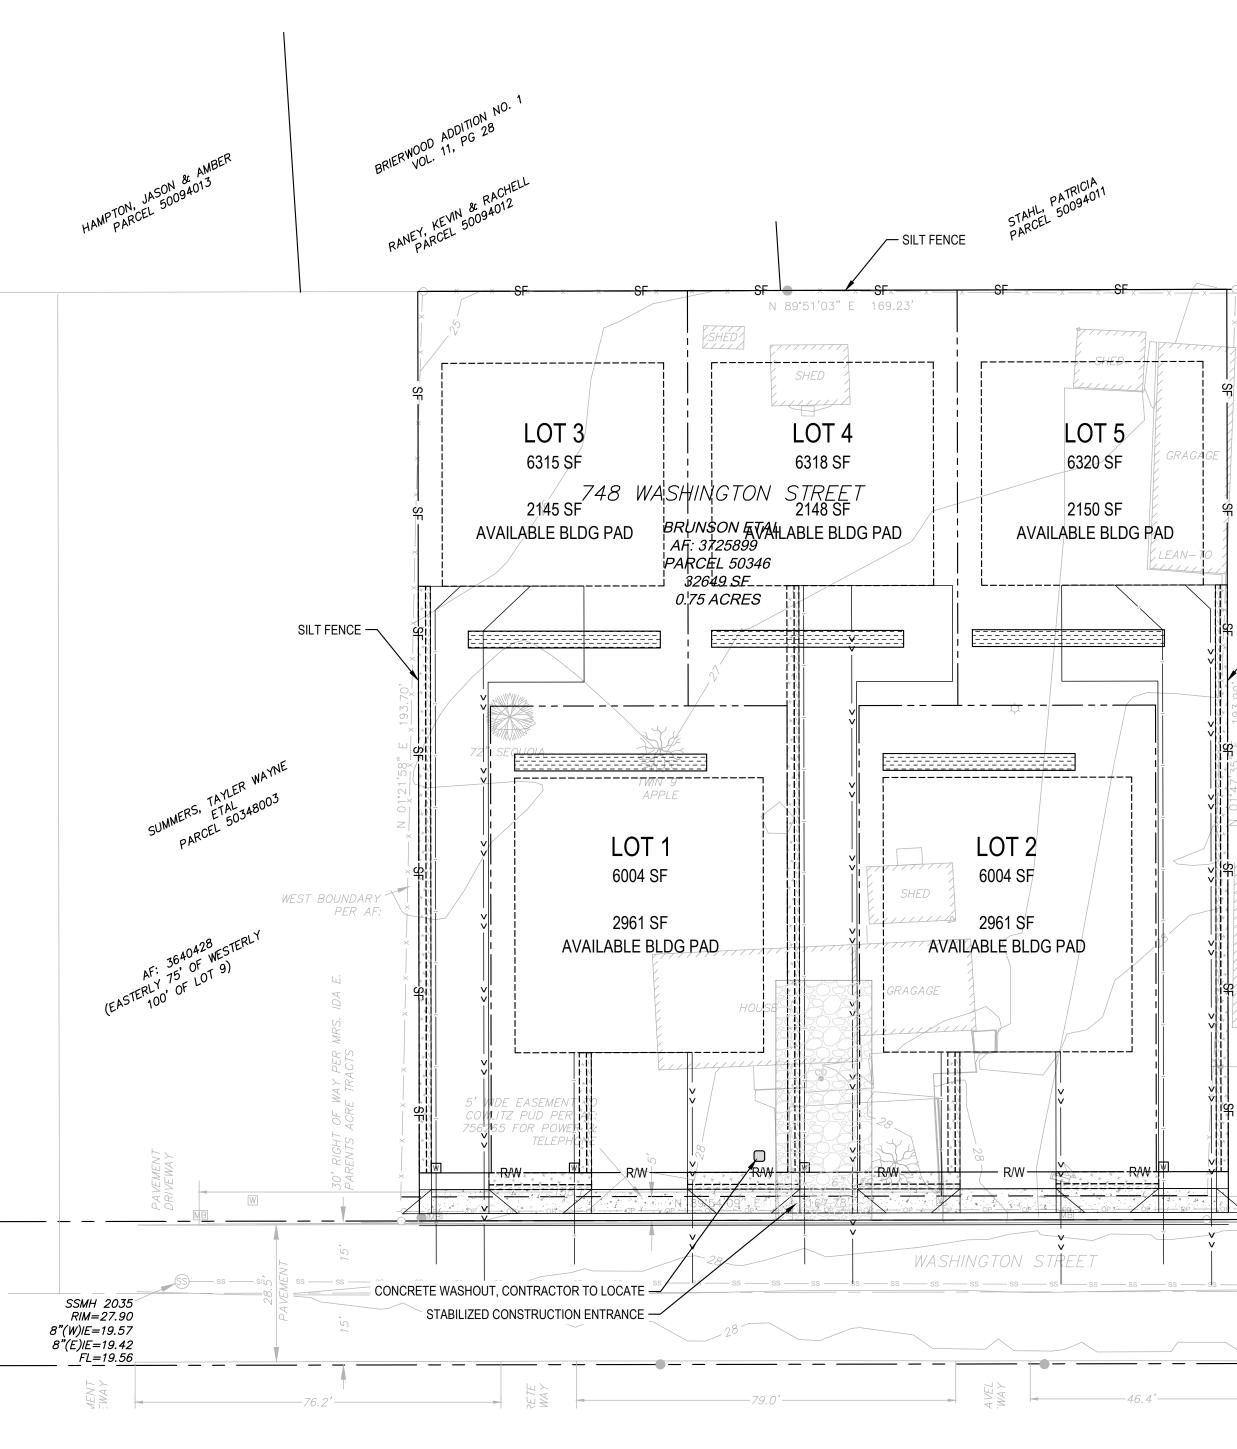SCALE: 1" = 20'

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SITE PLAN REVIEW Project No: 21035.1 Issue Date: 6/28/2023

NOTES:

- 1. SEE SHEETS #### AND ####, CIVIL NOTES, LEGENDS AND ABBREVIATIONS.
- 2. SEE SHEET C601, WOODLAND GENERAL EROSION NOTES DETAIL E-03
- 3. BMP C105 CONSTRUCTION ENTRANCE PER CITY OF WOODLAND DETAIL E-05
- 3.1. LENGTH MODIFIED FROM STANDARD DETAIL DUE TO SITE SIZE. LENGTH MODIFIED TO 50 FT.
- 3.2. A WHEEL WASH PER CITY OF WOODLAND DETAIL E-06 OR STREET SWEEPING PER STANDARD SET BY THE CITY OF WOODLAND MAY BE REQUIRED IF TRACKING OCCURS DUE TO MODIFIED CONSTRUCTION ENTRANCE.
- 4. BMP C 233 SILT FENCE PER CITY OF WOODLAND DETAIL E-20
- 5. BMP C120/121 TEMPORARY/PERMANENT SEEDING AND MULCHING, FOLLOW WASHINGTON DEPARTMENT OF ECOLOGY STANDARDS
- 6. BMP C220 STORM DRAIN INLET PROTECTION PER CITY OF WOODLAND DETAIL E-16 & E-17

SITE STABILIZATION

SANTOS, VICTON SARCEL 5009401

- SILT FENCE

AF: 1127, VOL.


AST BOUNDARY PER AF:


THE PROJECT CESCL IS SOLELY RESPONSIBLE FOR SELECTION, INSTALLATION, AND MAINTENANCE OF THE CHOSEN BMPs.

SITE STABILIZATION TO OCCUR DURING AND AFTER CONSTRUCTION. TO PREVENT EROSION, EXPOSED AND UNWORKED SOILS SHALL NOT REMAIN UNWORKED AND EXPOSED FOR MORE THAN THE TIME PERIODS DESCRIBED IN THE TABLE BELOW. SOILS MUST BE STABILIZED AT THE END OF THE SHIFT BEFORE A HOLIDAY OR WEEKEND IF NEEDED BASED ON THE WEATHER FORECAST. THIS APPLIES TO ALL SOILS WITHIN THE SITE, REGARDLESS OF FINAL GRADE OR NOT. EXPOSED AND UNWORKED SOILS SHALL BE STABILIZED THROUGHOUT THE LIFE OF THE PROJECT BY APPLICATION OF BMP C120/C121 SEEDING AND MULCHING. A TOTAL LIST OF POSSIBLE BPMS FOR STABILIZATION INCLUDE THE FOLLOWING BUT OTHER BMPs NOT INCLUDED ON THIS LIST MAY BE CHOSEN BY THE PROJECT CESCL AS APPROPRIATE.


BMP C120: TEMP. AND PERMANENT SEEDING BMP C121: MULCHING BMP C122: NETS AND BLANKETS BMP C123: PLASTIC COVERING BMP C125: TOPSOILING BMP C130: SURFACE ROUGHENING

AFTER CONSTRUCTION IS COMPLETE, THE ENTIRE SITE SHALL BE PERMANENTLY STABILIZED. PERMANENT STABILIZATION CAN BE COMPLETED BY ANY COMBINATION OF THE ABOVE OR OTHER APPROPRIATE METHODS AS CHOSEN BY THE PROJECT CESCL.

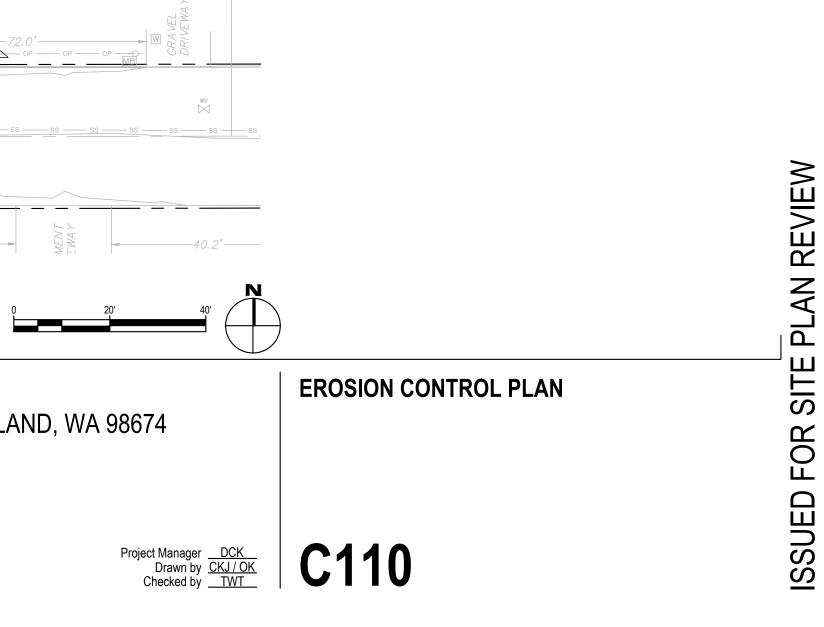


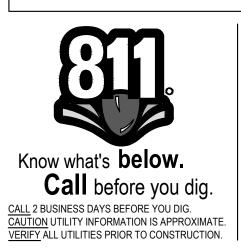

Re	visions	<u>:</u> \triangle	

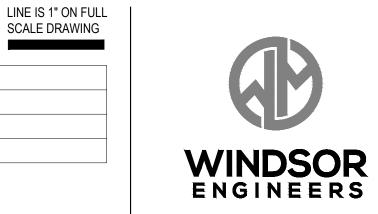

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GRADING PLAN

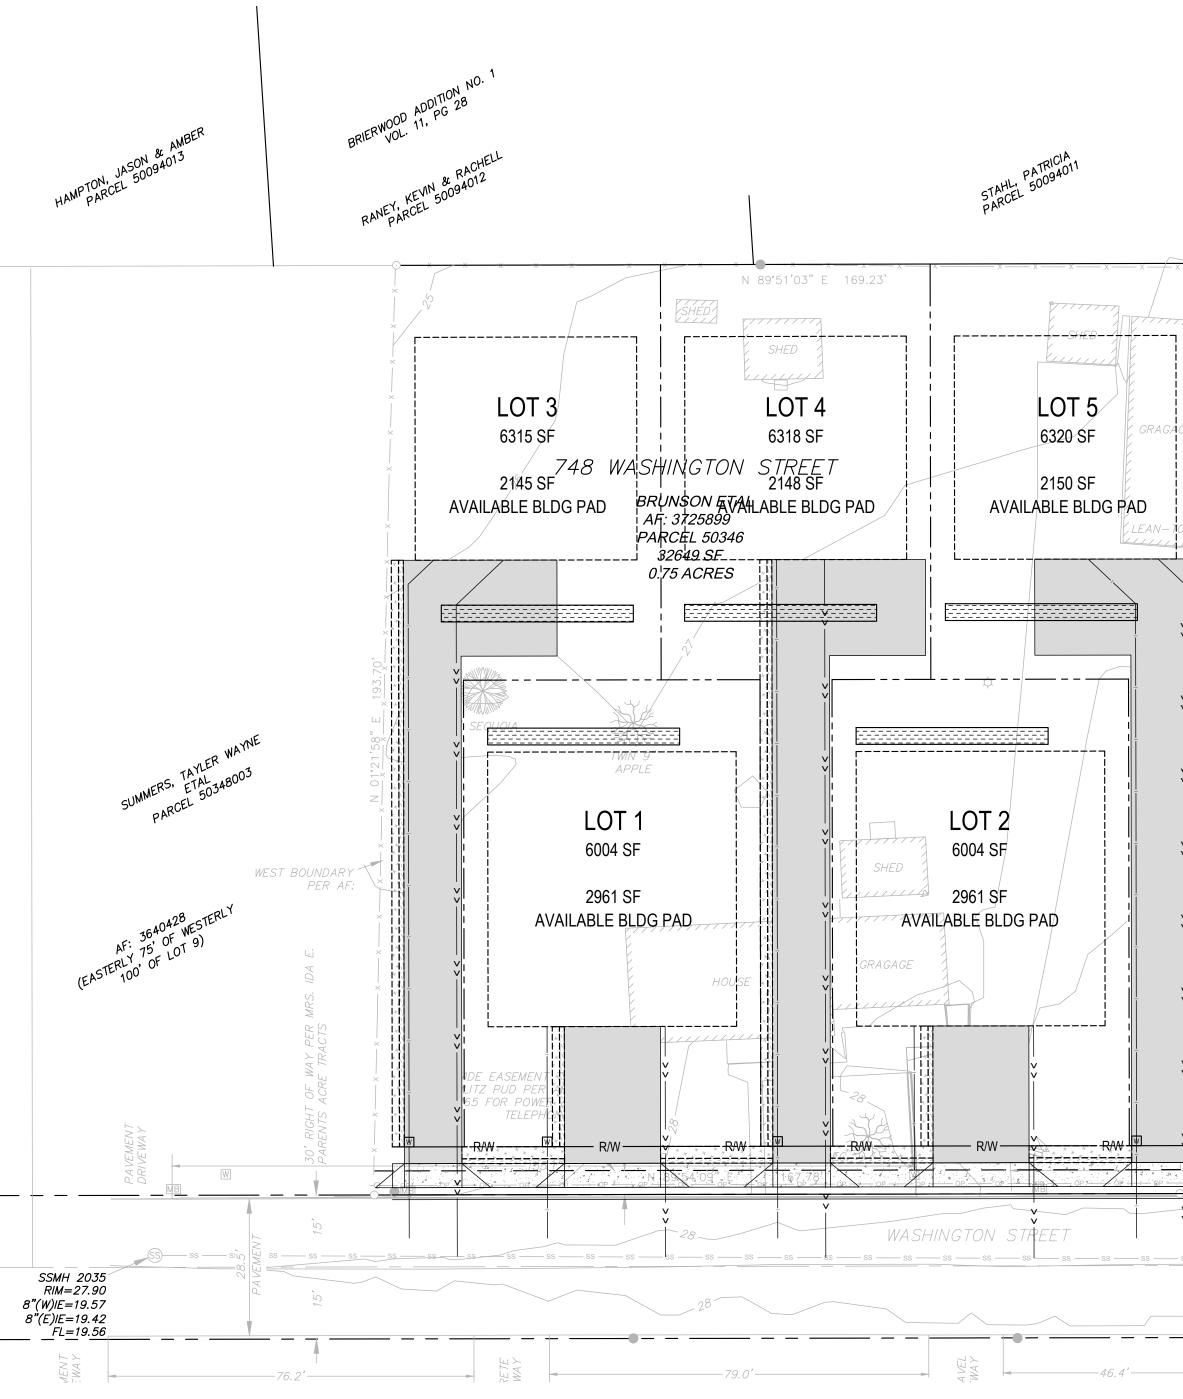SCALE: 1" = 20'

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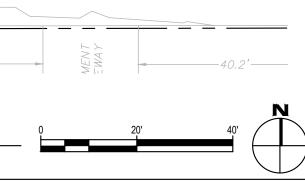
GENERAL SHEET NOTES:

- A. CITY OF WOODLAND CODE WMC
- B. "WASHINGTON STATE DEPARTMENT OF ECOLOGY STORMWATER MANAGEMENT MANUAL FOR WESTERN WASHINGTON" LATEST EDITION. AVAILABLE ON THE WASHINGTON DOE WEBSITE.
- C. ALL SOILS SHALL BE AMENDED TO MEET THE STANDARD SET BY BMP T5.13 POST CONSTRUCTION SOIL QUALITY AND DEPTH
- D. SHOULD ANY ITEM OF ARCHAEOLOGICAL INTEREST (VMC 20.710.090) BE FOUND DURING DEVELOPMENT, YOU ARE REQUIRED TO STOP WORK AND NOTIFY THE PLANNING CASE MANAGER IN DEVELOPMENT REVIEW SERVICES AT (360) 487-7800, AND THE WASHINGTON STATE OFFICE OF ARCHAEOLOGY AND HISTORIC PRESERVATION AT (360) 753-4011 IMMEDIATELY. FAILURE TO DO SO COULD RESULT IN A FELONY CONVICTION.
- E. ANY PUBLIC, OR PRIVATE, CURB, GUTTER, SIDEWALK, OR ASPHALT DAMAGED DURING CONSTRUCTION SHALL BE REPAIRED TO CITY OF WOODLAND STANDARDS.
- F. IF ANY FILL IS PROPOSED WITHIN CURRENT, OR FUTURE, RIGHT-OF-WAY THE CONTRACTOR SHALL PLACE SUCH FILL IN ACCORDANCE WITH WMC.
- G. THE PROPOSED STORMWATER FACILITY MUST REMAIN OFFLINE UNTIL THE PROJECT IS COMPLETE AND VEGETATION THROUGHOUT THE SITE HAS BEEN ESTABLISHED. IF AT ANY TIME THE FACILITY BECOMES INUNDATED WITH SEDIMENT FILLED RUNOFF, THE TOP 2" OF MATERIAL MUST BE REMOVED AND REPLACED PRIOR TO PROJECT COMPLETION.
- H. LOTS TO BE GRADED AT TIME OF HOME CONSTRUCTION AND BE SUBJECT TO INDIVIDUAL PERMITTING.

GRADING NOTES

SANTOS, 50094010

- NO GRADING WITHIN 2' OF ADJACENT PARCELS PER IBC.
- 2. STRIP ORGANICS PER GEOTECH REPORT.
- 3. STRIPPINGS TO REMAIN ON SITE AND BE REDISTRIBUTED OVER LANDSCAPE AREAS AFTER ALL GRADING ACTIVITIES ARE COMPLETED. CONTRACTOR SHALL BE RESPONSIBLE FOR HAUL-OFF EXCESS MATERIAL.
- 4. CUT AND FILL QUANTITIES ARE BASED ON GENERAL SITE GRADING ESTABLISHED FROM THE STRIPPED GRADE TO THE FINISHED PROPOSED SUBGRADE AND TRENCH SPOILS. THESE VOLUMES DO NOT TAKE INTO ACCOUNT ANY UNKNOWN SOIL DEPOSITS OR OVER-EXCAVATION OF NON-ORGANIC MATERIALS THAT ARE DISCOVERED ON SITE, NOR WET WEATHER CONDITIONS. CONTRACTOR SHALL BE RESPONSIBLE TO PRODUCE INDEPENDENT GRADING VOLUMES AS WELL AS ACCOUNT FOR OBSERVATION OF MEASURES DIRECTED WITHIN THE GEOTECHNICAL REPORT OR AS DIRECTED BY THE GEOTECHNICAL ENGINEER DURING THE COURSE OF CONSTRUCTION.
- 5. SITE SLOPES ARE 2% OR LESS
- 6. IMPORTED FILL AND COMPACTION PER GEOTECH REPORT
- 7. EXCAVATION NEAR FOUNDATION EXCAVATION NEAR FOUNDATIONS. EXCAVATION FOR ANY PURPOSE SHALL NOT REDUCE LATERAL SUPPORT FROM ANY FOUNDATION OR ADJACENT FOUNDATION WITHOUT FIRST UNDERPINNING OR PROTECTING THE FOUNDATION AGAINST DETRIMENTAL LATERAL OR VERTICAL MOVEMENT, OR BOTH.
- 8. SITE GRADING THE GROUND IMMEDIATELY ADJACENT TO THE FOUNDATION SHALL BE SLOPED AWAY FROM THE BUILDING AT A SLOPE OF NOT LESS THAN ONE UNIT VERTICAL IN 20 UNITS HORIZONTAL (5-PERCENT SLOPE) FOR A MINIMUM OF 10 FEET MEASURED PERPENDICULAR TO THE FACE OF THE WALL. IF PHYSICAL OBSTRUCTIONS OR LOT LINES PROHIBIT 10 FEET OF HORIZONTAL DISTANCE, A 5-PERCENT SLOPE SHALL BE PROVIDED TO AN APPROVED ALTERNATIVE METHOD OF DIVERTING WATER AWAY FROM THE FOUNDATION. SWALES USED FOR THIS PURPOSE SHALL BE SLOPED A MINIMUM OF 2 PERCENT WHERE LOCATED WITHIN 10 FEET OF THE BUILDING FOUNDATION. IMPERVIOUS SURFACES WITHIN 10 FEET OF THE BUILDING FOUNDATION SHALL BE SLOPED A MINIMUM OF 2 PERCENT AWAY FROM THE BUILDING.
- 9. EXCEPTION: WHERE CLIMATIC OR SOILS CONDITIONS WARRANT, THE SLOPE OF THE GROUND AWAY FROM THE BUILDING SHALL BE PERMITTED TO BE REDUCED TO NOT LESS THAN ONE VERTICAL IN 48 UNITS HORIZONTAL (2-PERCENT SLOPE).
- 10. THE PROCEDURE USED TO ESTABLISH THE FINAL GROUND LEVEL ADJACENT TO THE FOUNDATION SHALL ACCOUNT FOR ADDITIONAL SETTLEMENT OF THE BACKFILL



AF: 1121

VOL.

EAST BOUNDAR PER AF:

GRADING PLAN

Project Manager <u>DCK</u> Drawn by <u>CKJ / OK</u> Checked by <u>TWT</u>



PLAN REVIEW ISSUED FOR SITE




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Know what's **below. Call before you dig.** <u>CALL 2 BUSINESS DAYS BEFORE YOU DIG.</u> <u>CAUTION UTILITY INFORMATION IS APPROXIMATE.</u> <u>VERIFY</u> ALL UTILITIES PRIOR TO CONSTRUCTION.

Re	Revisions:		



LINE IS 1" ON FULL SCALE DRAWING

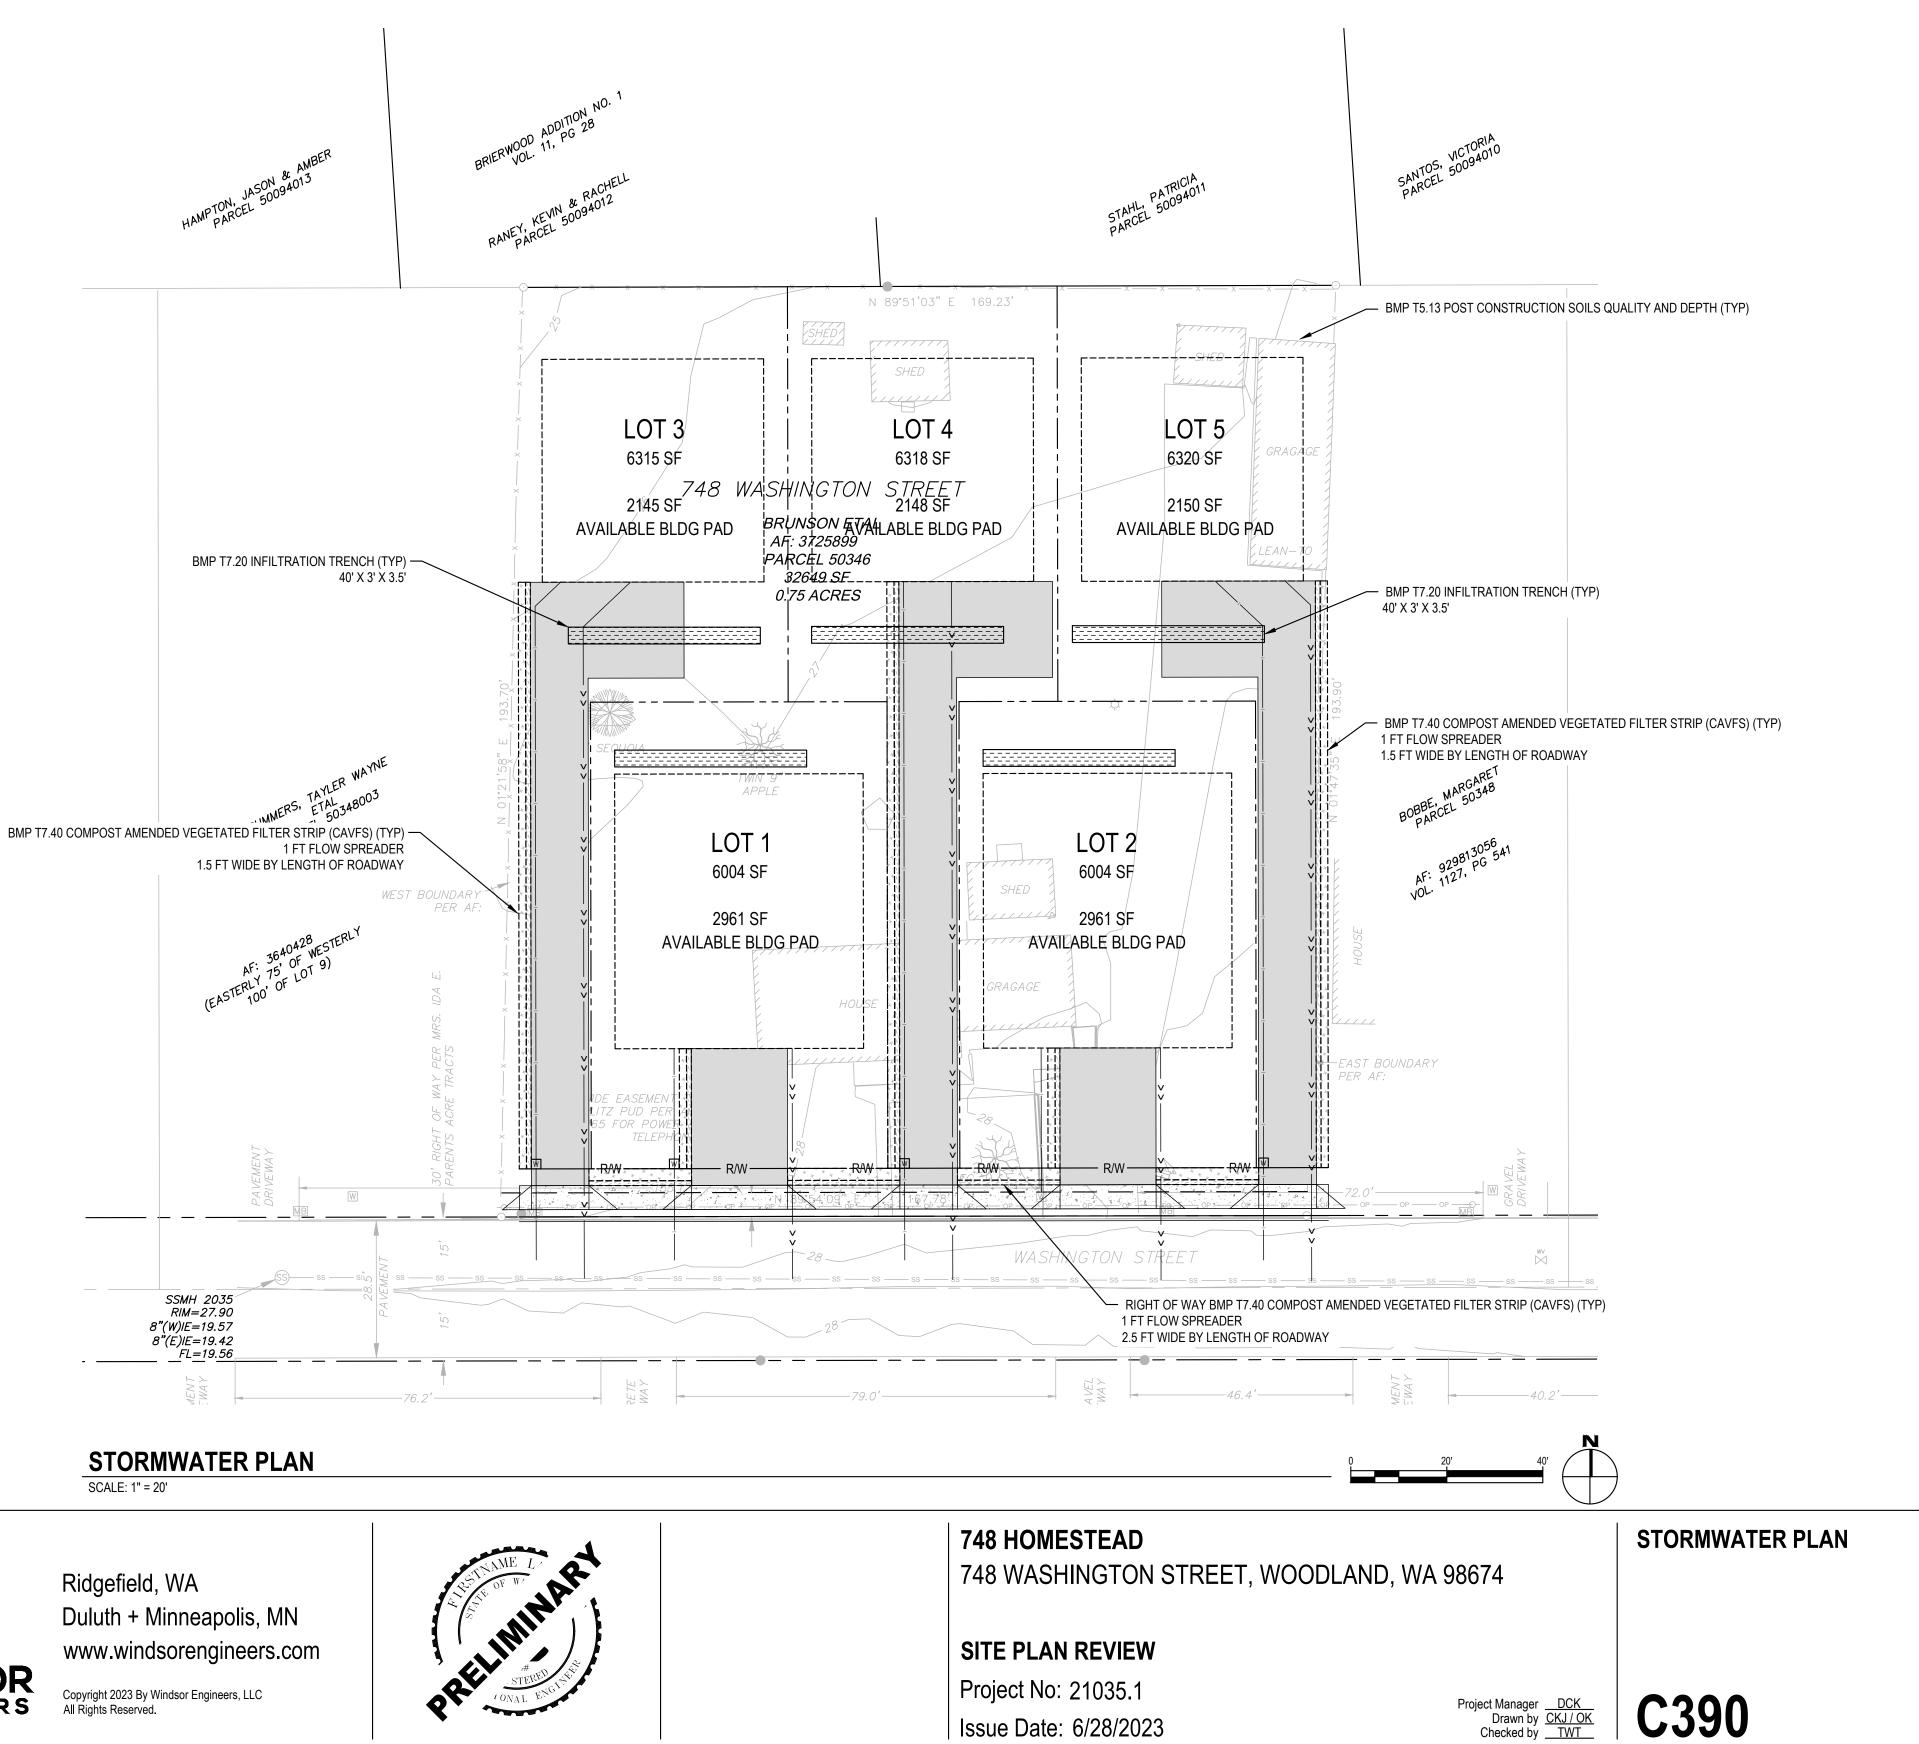

STORMWATER PLAN


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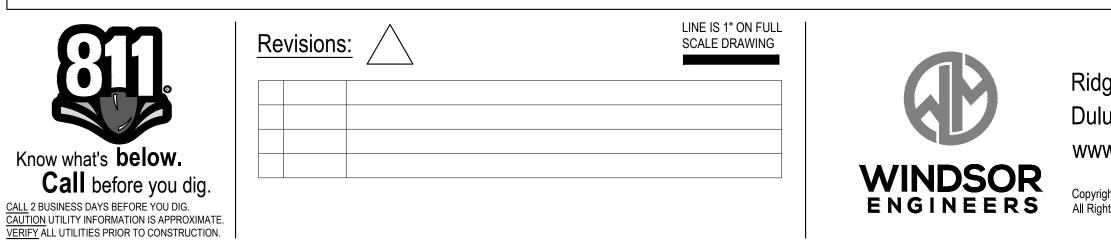


STORMWATER KEYNOTES:

- A. STORMWATER FACILITIES THAT ARE PRIVATELY OWNED SHALL BE MAINTAINED BY THE LANDOWNER
- B. ALL INFILTRATION SHALL BE AT LEAST 10 FEET FROM ANY STRUCTURE, PROPERTY LINE, OR SENSITIVE AREA (EXCEPT SLOPES OVER 40%)

ISSUED FOR SITE PLAN REVIEW



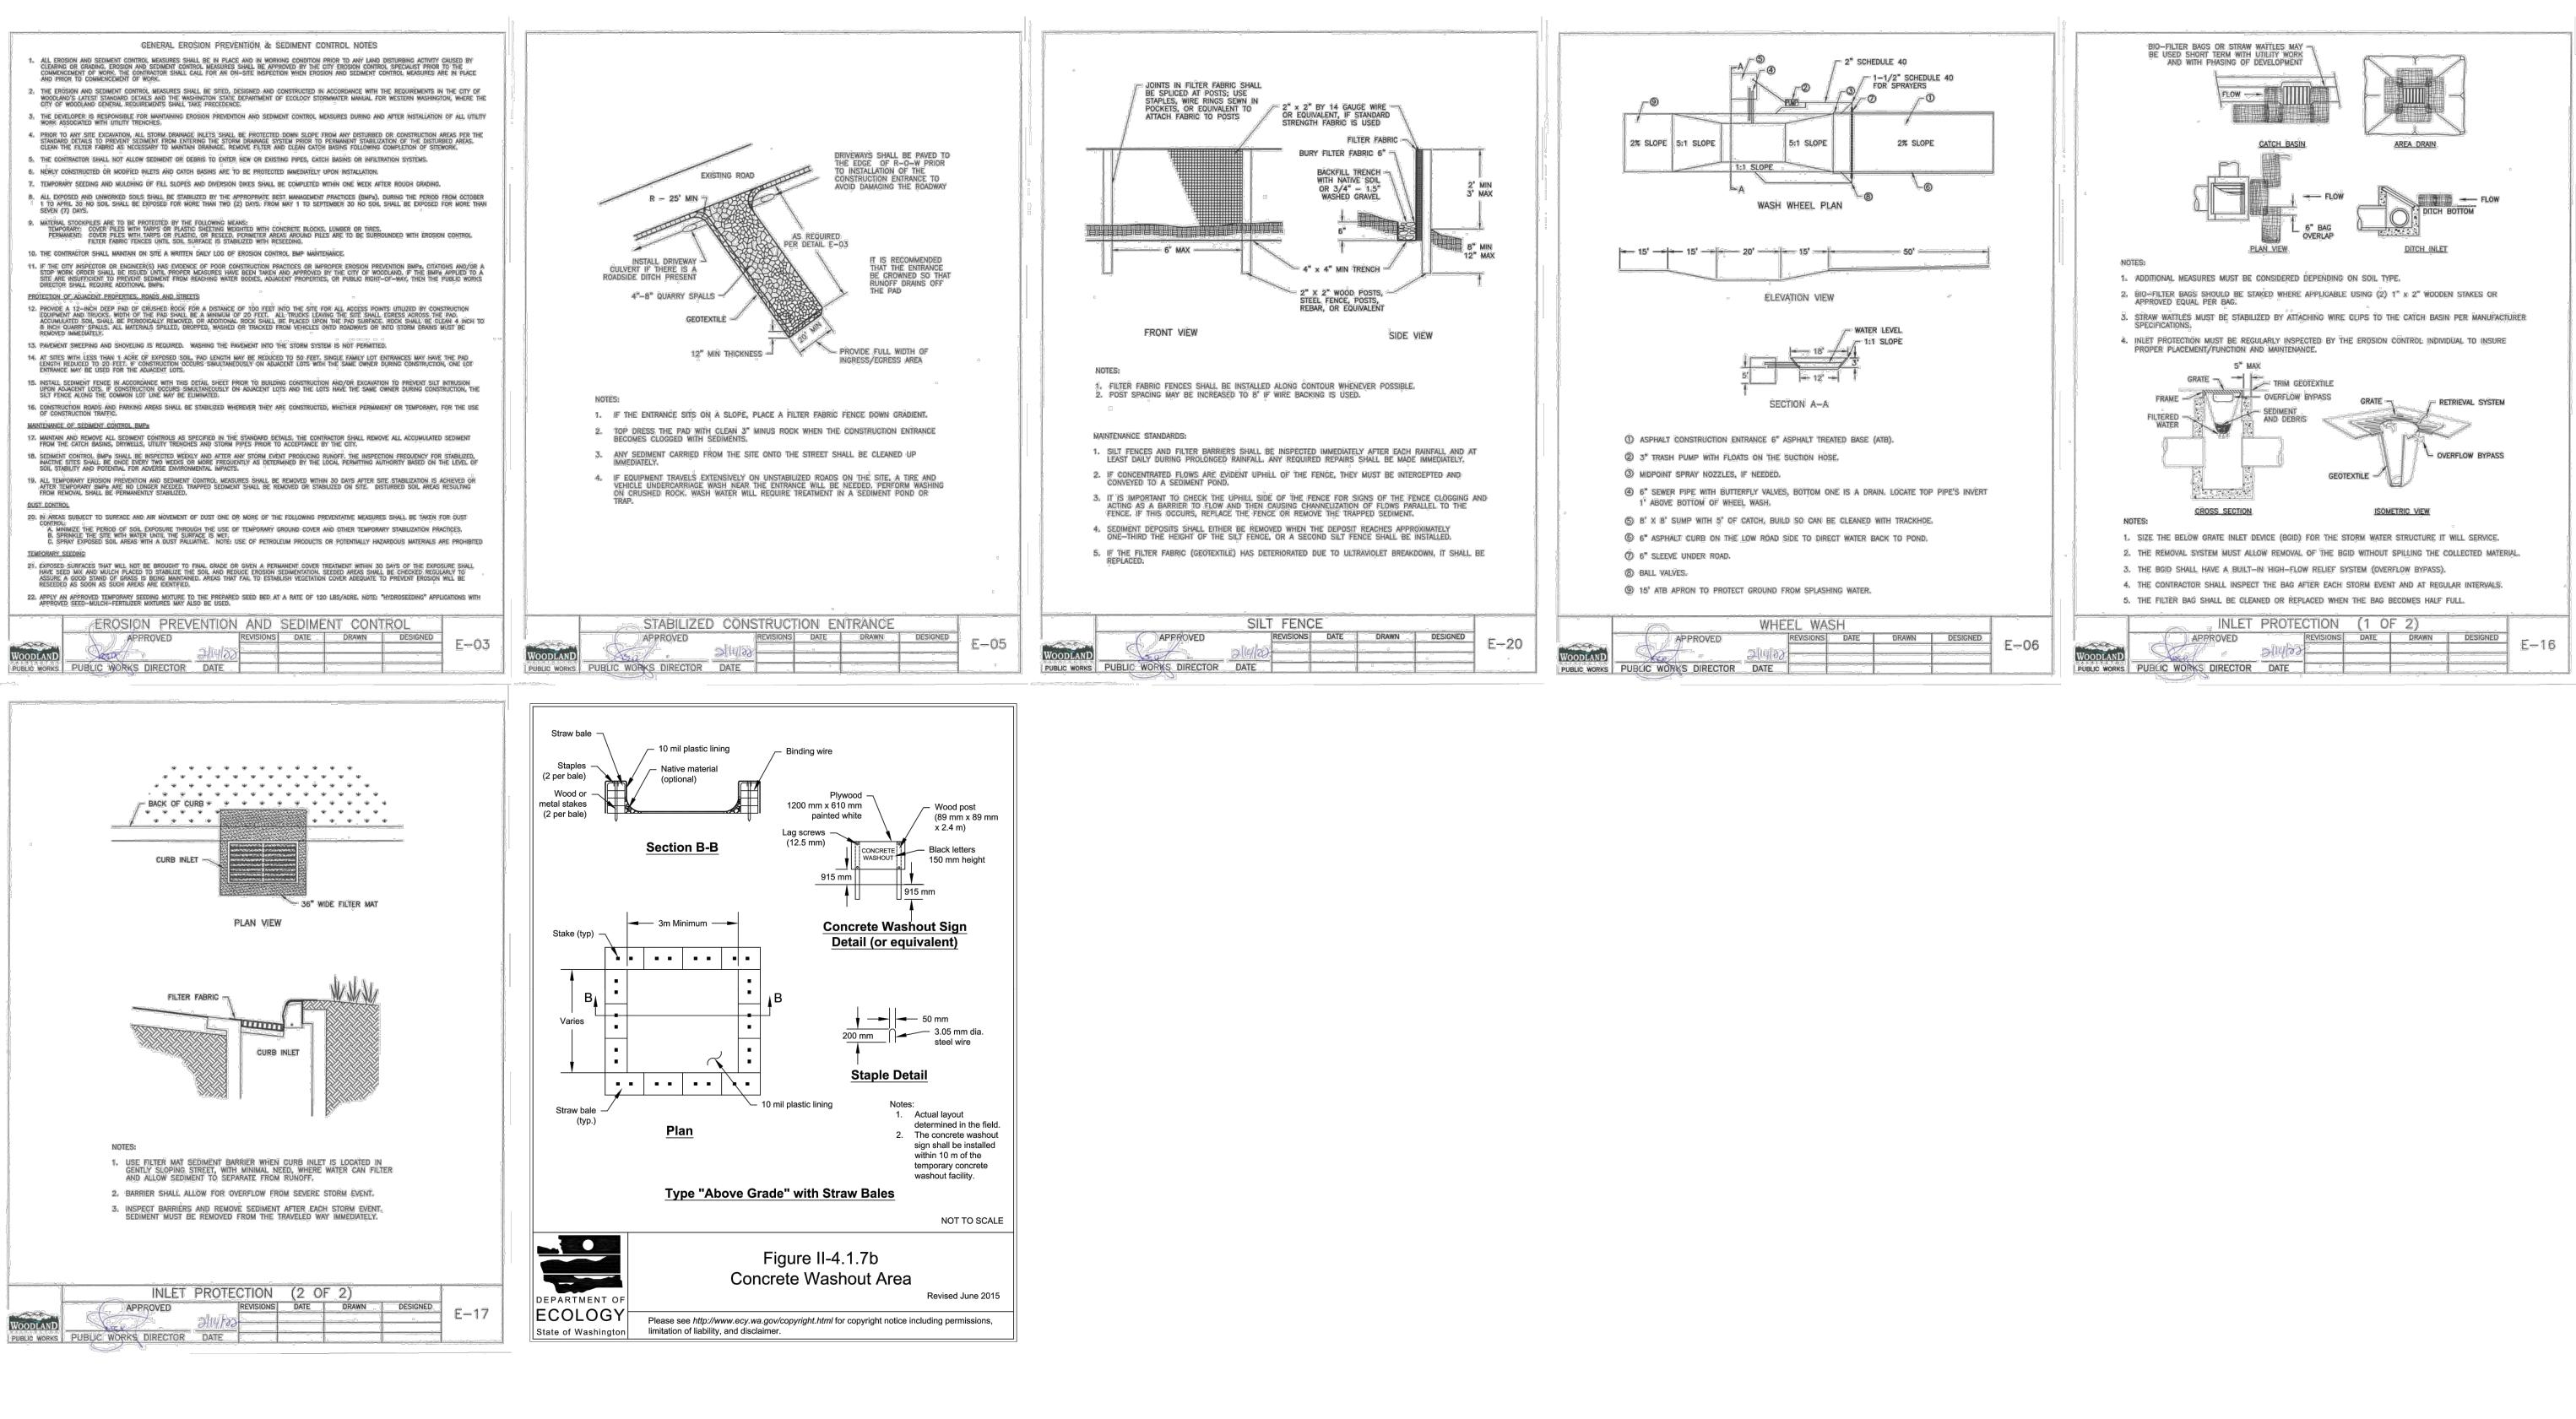

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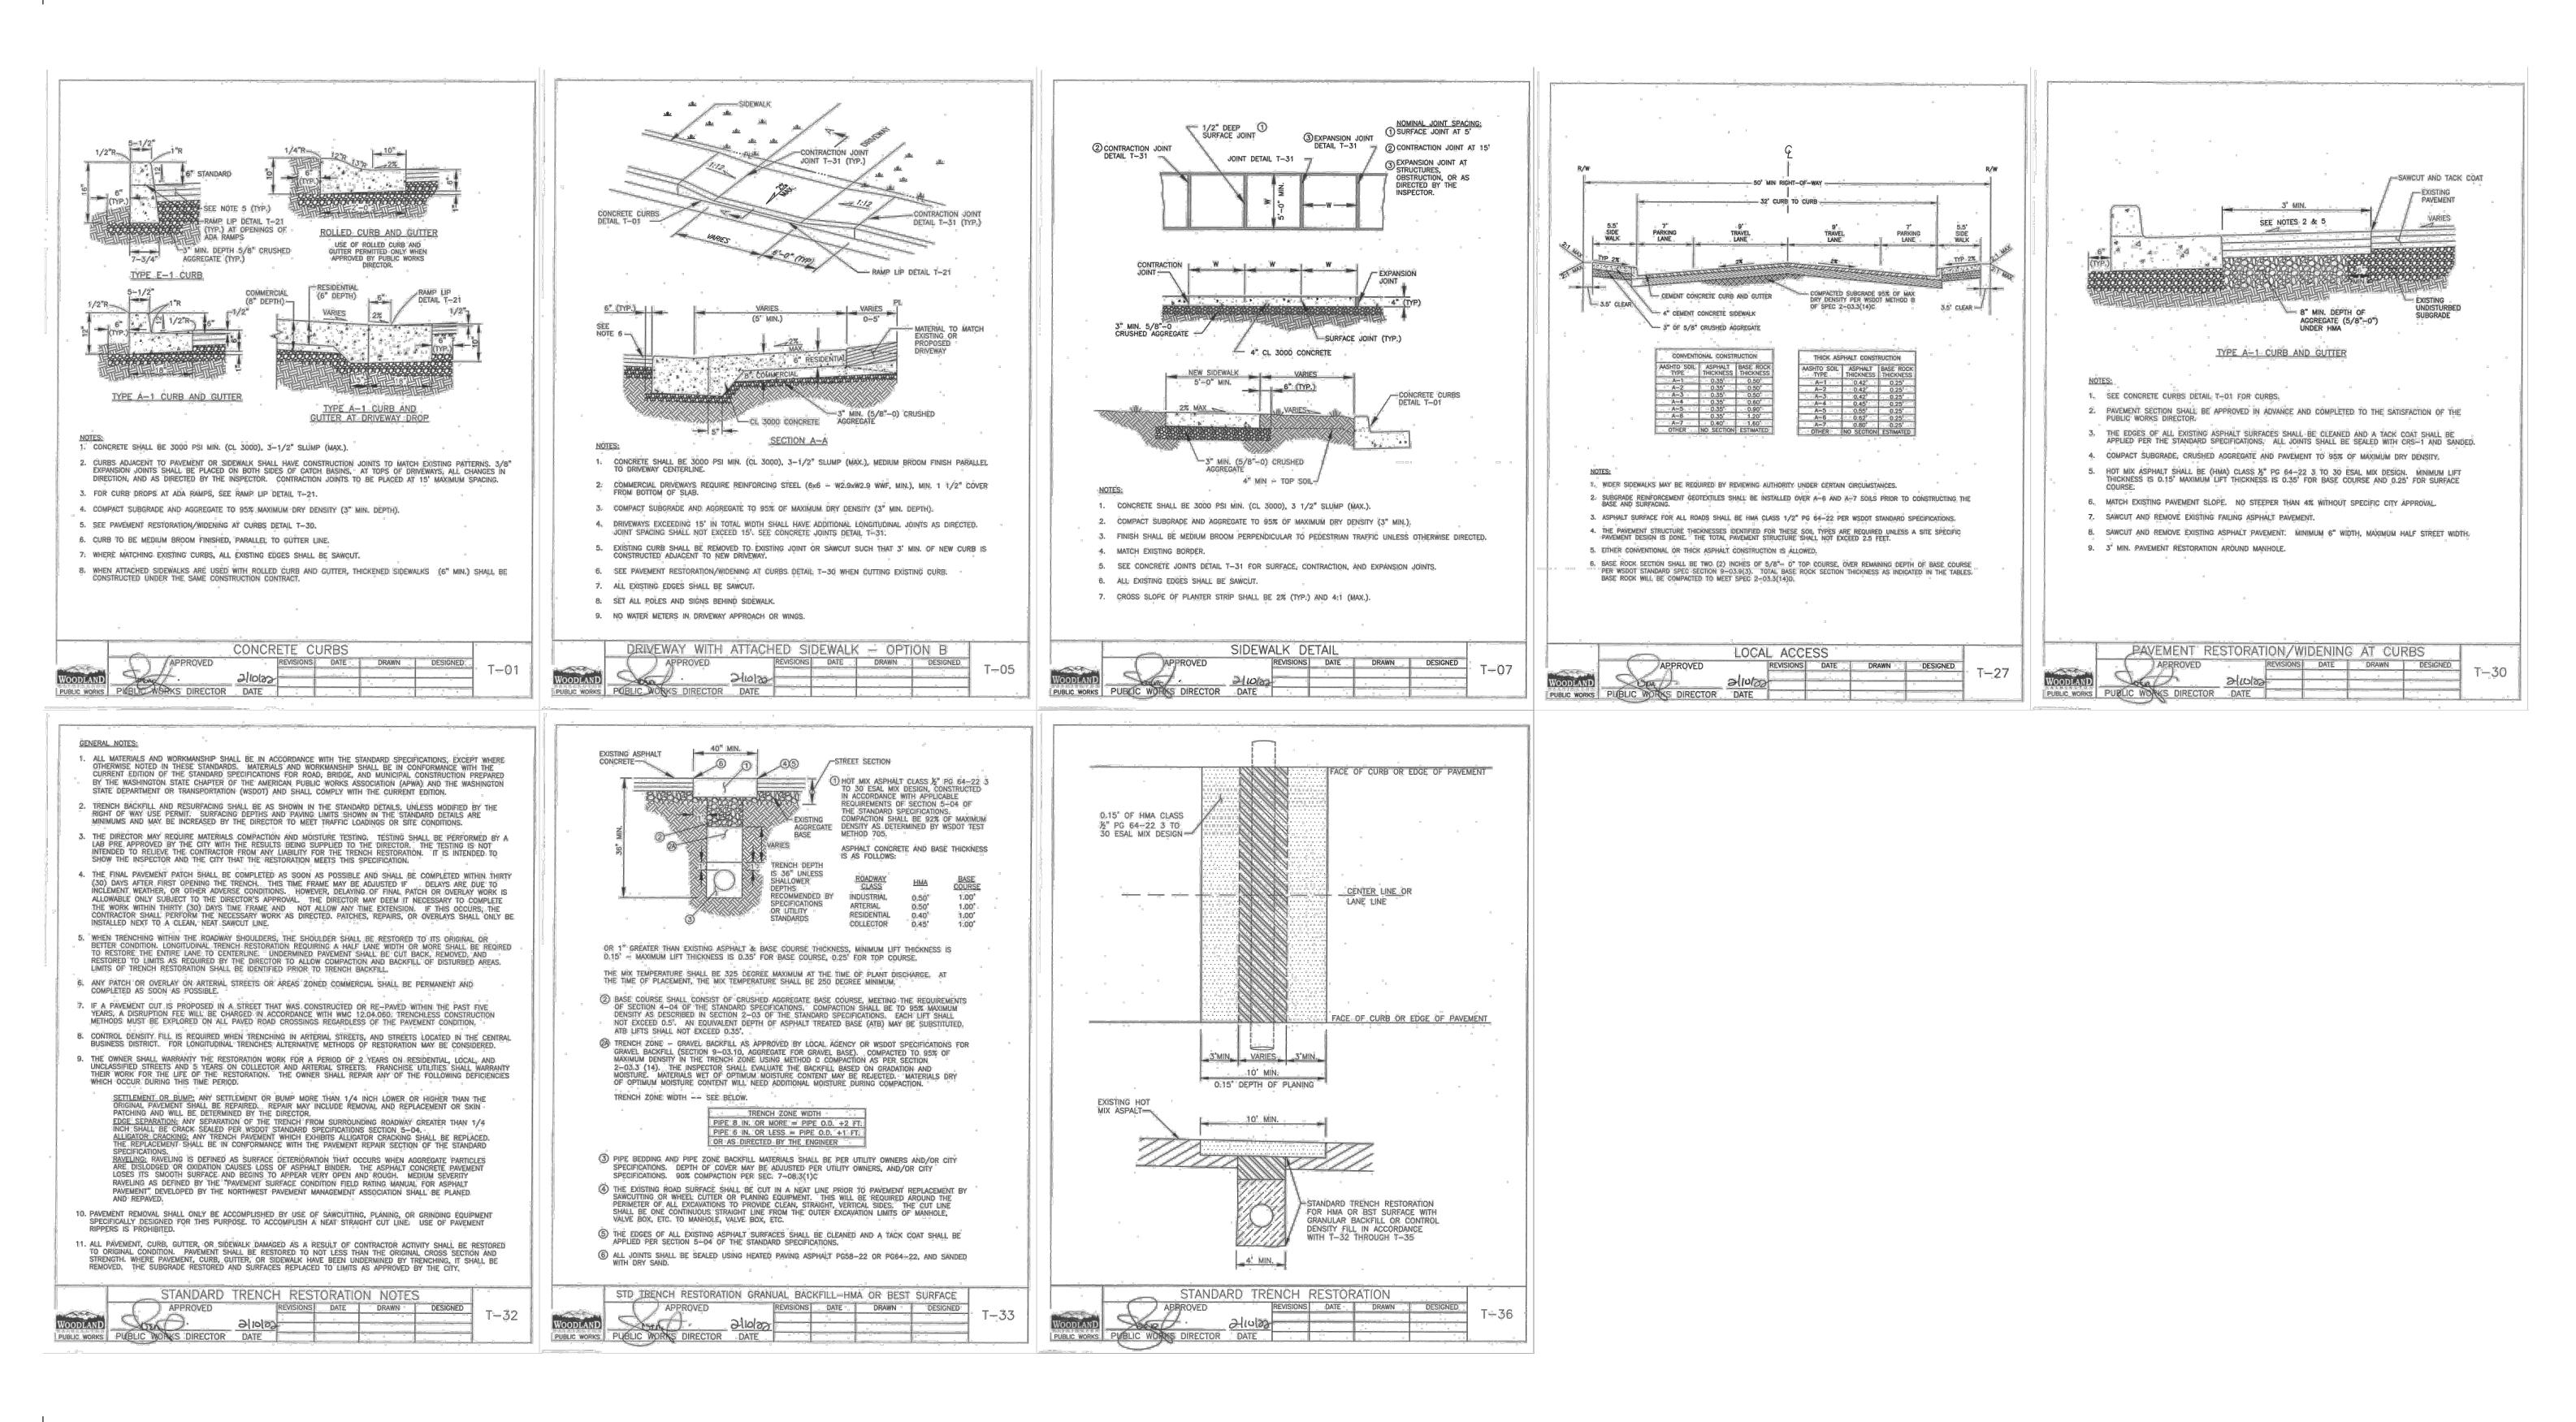
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SITE PLAN REVIEW Project No: 21035.1 Issue Date: 6/28/2023

EROSION CONTROL DETAILS

Project Manager <u>DCK</u> Drawn by <u>CKJ / OK</u> Checked by <u>TWT</u>





\mathbf{O}	Revisions:	LINE IS 1" ON FULL SCALE DRAWING		
				Ridge
				Dulut
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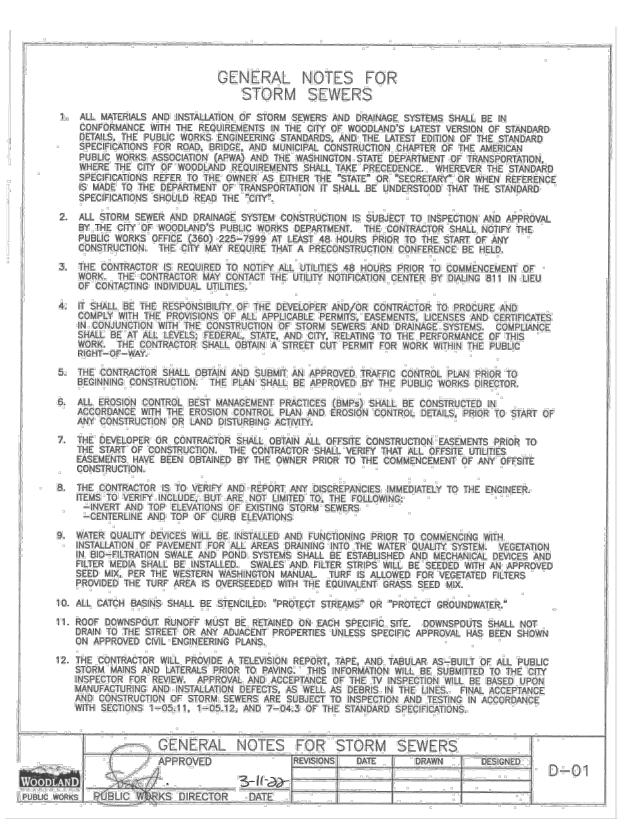
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SITE PLAN REVIEW Project No: 21035.1 Issue Date: 6/28/2023 SITE DETAILS

Project Manager <u>DCK</u> Drawn by <u>CKJ / OK</u> Checked by <u>TWT</u> **C602**





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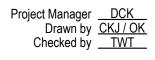
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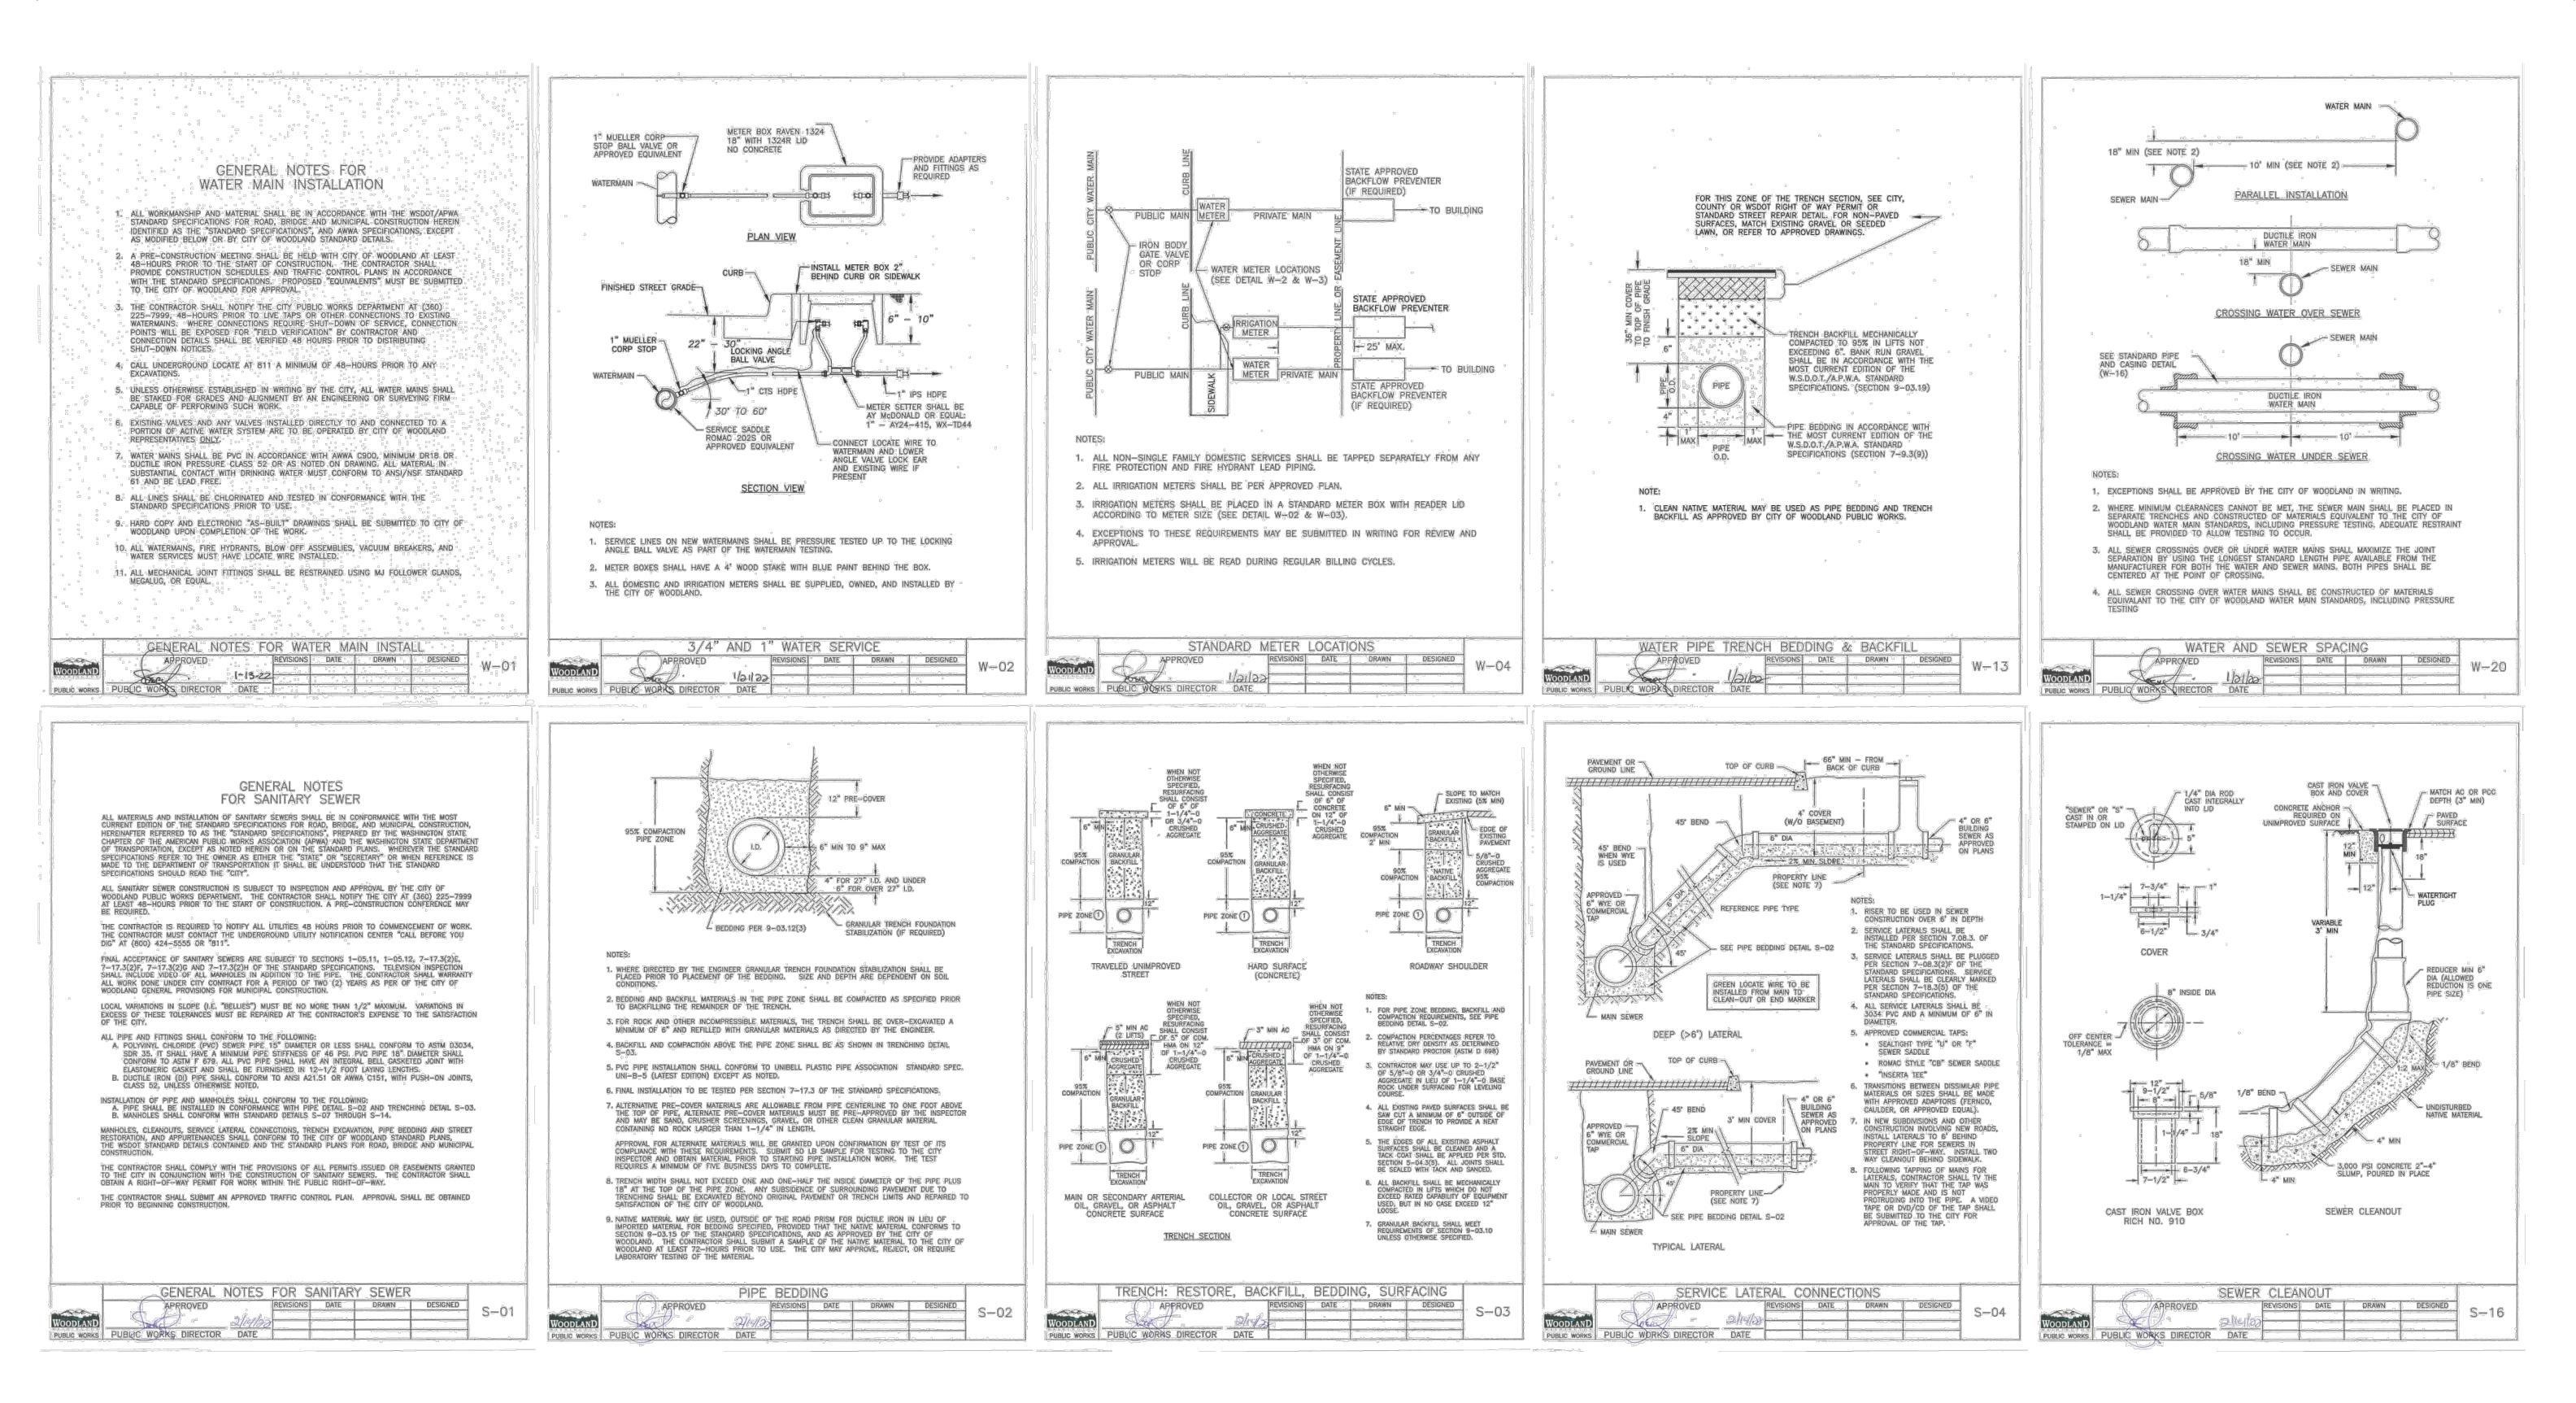
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SITE PLAN REVIEW Project No: 21035.1 Issue Date: 6/28/2023 STORMWATER DETAILS

Project Manager __



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\mathbf{m}	Revisions:	LINE IS 1" ON FULL SCALE DRAWING		
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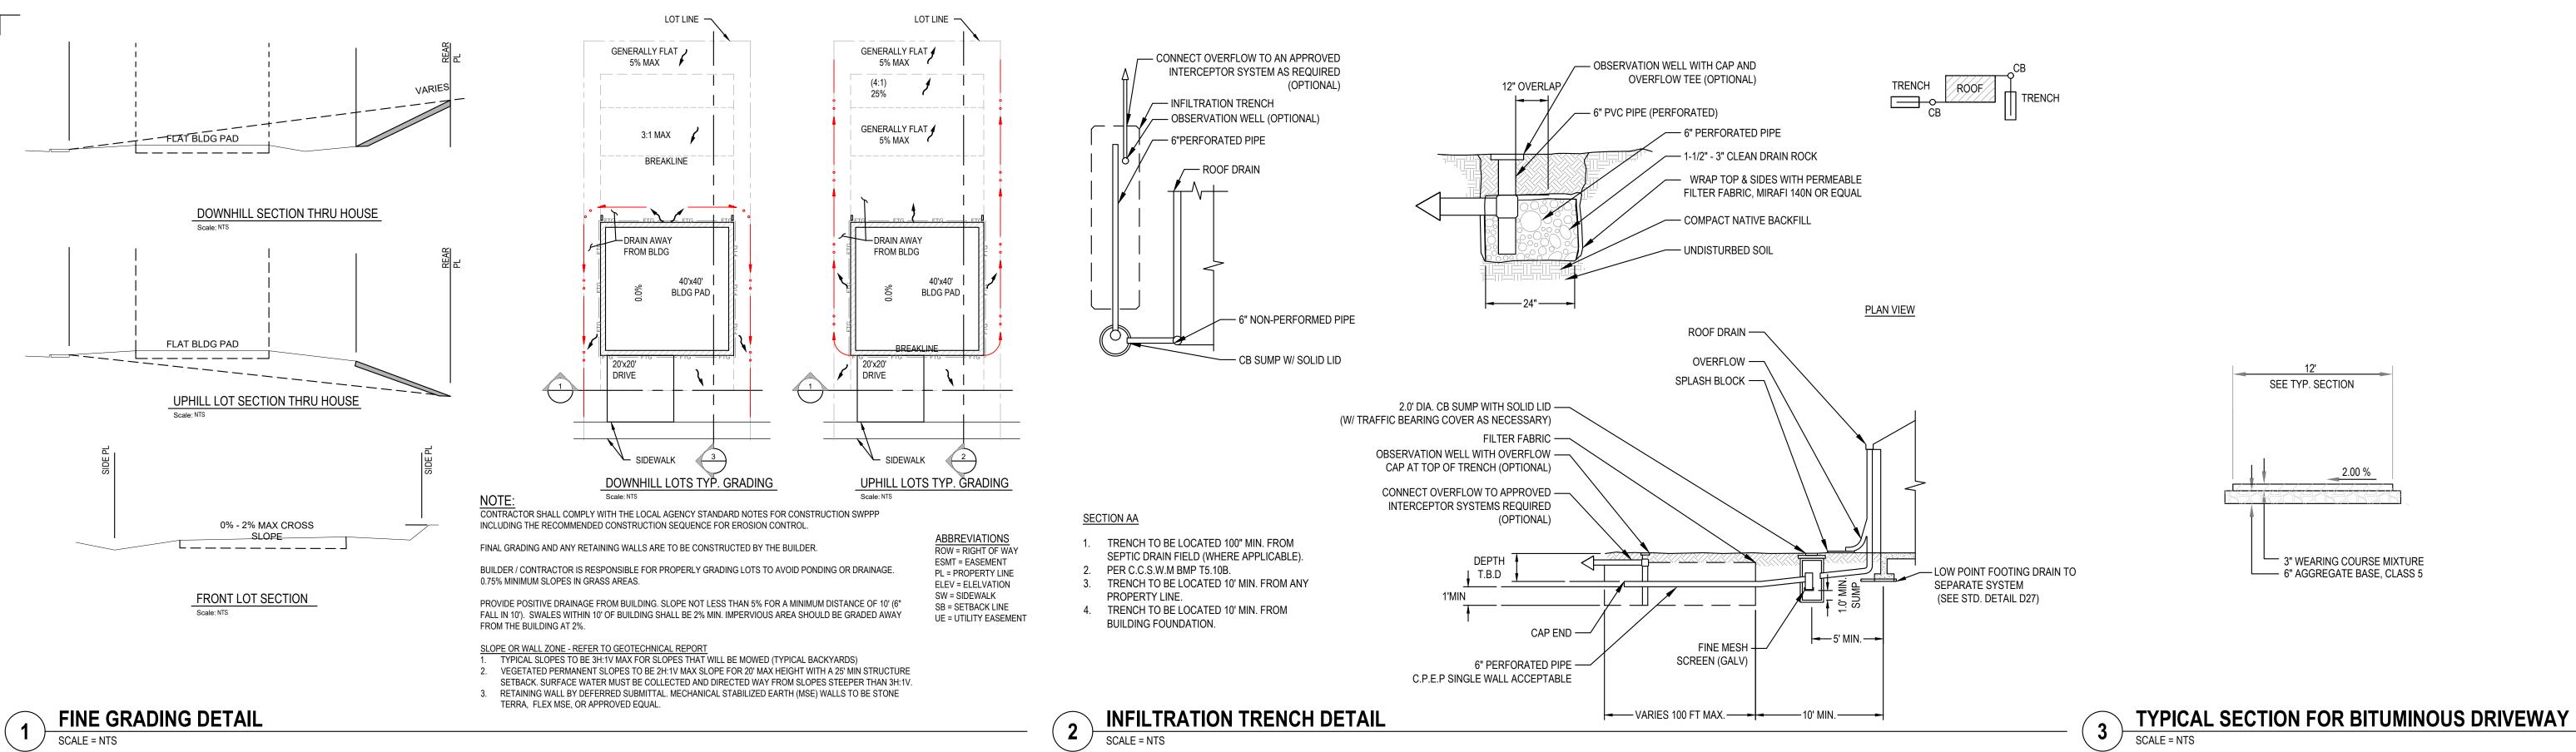
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UTILITY DETAILS

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REVIEW PLAN SITE FOR ISSUED

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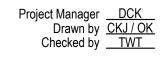
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