# SITE PLAN REVIEW

# FOR **438 HOMESTEAD** 438 WASHINGTON STREET, WOODLAND, WA 98674

# PREPARED FOR: HOMESTEAD, LLC

P.O. BOX 255 YACOLT, WA 98675 CONTACT: ROGER FOLEY PHONE: (360) 901-0056 EMAIL: ROGER.FOLEY505@GMAIL.COM

# PREPARED BY: WINDSOR ENGINEERS

CONTACT: DAN KOISTINEN PHONE: (360) 852-4971 EMAIL: DKOISTINEN@WINDSORENGINEERS.COM



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PROJECT NUMBER: 21035.1

# CONSTRUCTION SHALL CONFORM TO THE REQUIREMENTS OF THE CITY OF WOODLAND ENGINEERING STANDARDS FOR CONSTRUCTION

PARCEL INFORMATION: PARCEL NUMBERS: 50339 LOT SIZE: 0.93 AC ZONING RESIDENTIAL (LDR-6)

LEGAL DESCRIPTION: IN THE HANS KRAFT D.L.C. IN THE SW 1/4 OF TH SW 1/4 OF SECTION 24 T. 5 N., R. 1 W., W.M. CITY OF WOODLAND, COWLITZ COUNTY, WASHINGTON

BASIS OF BEARING: N 89° 58' 05" E ALONG THE SOUTH LINE OF R.O.S. 35-61

VERTICAL DATUM: NAVD 88 BASED ON WSDOT MON. 4081 EL = 30.07

# CITY OF WOODLAND


CITY OF WOODLAND PERSONNEL

230 DAVIDSON AVE PO BOX 9 WOODLAND, WA 98674

PHONE: 360-225-8281 TRAVIS GODDARD - COMMUNITY DEVELOPMENT TRACY COLEMAN - PUBLIC WORKS DIRECTOR DEBI CLER - BUILDING OFFICIAL MARK NELSON - ENGINEERING KATHRYN MYKLEBUST - ENGINEERING AIDE MIKE JACKSON - DIVISION FIRE CHIEF

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VICINITY MAP

# UTILITY

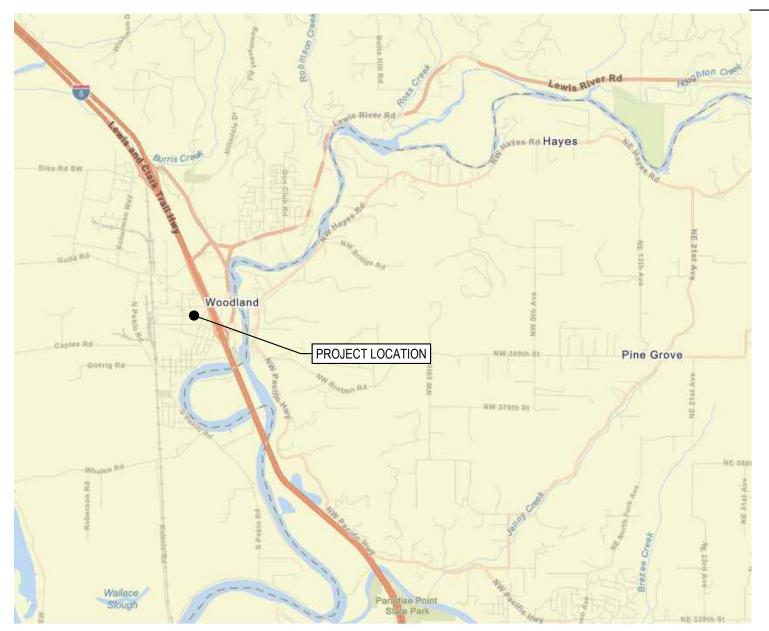WATER SEWER WASTE SERVICES POWER INTERNET

# JURISDICTION

CITY OF WOODLAND CITY OF WOODLAND CITY OF WOODLAND COWLITZ PUD COMCAST

# PHONE NUMBER

360-225-8281 360-225-8281 360-225-8281 360-423-2210 800-934-6489

| WASHINGTON                         | City of Woodland<br>Public Works Department<br>PO Box 9<br>236 Ste B Davidson<br>Woodland, WA 98674<br>www.ci.woodland.wa.us |        | (360) 225<br>0) 225-74 |      |
|------------------------------------|--|--------|------------------------|------|
| Pla                                | ans reviewed for compliance  | e with |                        |      |
|                                    | City Standards and Policie   |        |                        |      |
| Permit Number:                     | SPR-23-XXX   |        |                        |      |
| Recommended for Approval:          |  |        |                        |      |
|                                    |  |        |                        |      |
| PUBLIC WORKS DIR                   | ECTOR  | DATE   |                        |      |
|                                    |  |        |                        |      |
| Improvement Sum                    | mary:  |        |                        |      |
| STREET IMPROVEMENTS                | 5  |        | 207                    | LF   |
| WATER MAIN FOOTAGE                 |  | _      | N/A                    | LF   |
| SEWER MAIN FOOTAGE                 |  |        | N/A                    | _ LF |
| SEPTIC SYSTEM DECOMMISSIONED       |  |        | 1                      | EA   |
| TRENCHING WITHIN CITY RIGHT-OF-WAY |  |        | 237                    | _ LF |
| TOTAL IMPRERVIOUS SURFACE          |  |        | 20,694                 | _ SF |
| PRIVATE IMPERVIOUS SURFACE         |  | 0.438  | _ AC                   |      |
| GRADING:                           | CUT <u>~ 50</u> CY   | FILL _ | ~50                    | _ CY |

REVISIONS:

SUED FOR SITE PLAN REVIEW

# **PROJECT NOTES**

PROJECT INCLUDES A 6 LOT SUBDIVISION AND INFRASTRUCTURE INCLUDING FRONTAGE IMPROVEMENTS, STORMWATER FACILITIES, AND UTILITIES

# PARCEL NO.(S): 50339

SITE ADDRESS: 438 WASHINGTON STREET, WOODLAND, WA

QUARTER SECTION: SECTION 24, T5N, R1W, W.M.

COUNTY: COWLITZ

# CRITICAL AREAS:

- 1. ON THE SUBJECT PARCEL, THERE ARE NO KNOWN: EXISTING / PROPOSED WELLS
- GAS PIPELINES / EASMENTS.
- 2. A GEOTECHNICAL REPORT PREPARED BY (STRATA DESIGN) PROVIDES RECOMMENDATIONS FOR THIS SITE.

# CONTACT INFORMATION

APPLICANT / PROPERTY OWNER HOMESTEAD, LLC(DEVELOPER) CONTACT: ROGER FOLEY ROGER.FOLEY505@GMAIL.COM

## REPRESENTATIVE / CONTACT WINDSOR ENGINEERS, LLC

27300 NE 10TH AVE. RIDGEFIELD, WA 68642 CONTACT: EMILY STEPHENS (612) 351-2331 ESTEPHENS@WINDSORENGINEERS.COM

# GENERAL ABBREVIATIONS

| GENERAL ABBREVIATIONS |                                |  |
|-----------------------|--------------------------------|--|
| (E)                   | EXISTING                       |  |
| С                     | CONCRETE                       |  |
| СВ                    | CATCH BASIN                    |  |
| CL                    | CENTERLINE                     |  |
| CNS                   | COMPACTED NATIVE SOIL          |  |
| CO                    | CLEAN OUT                      |  |
| CR                    | CURB RETURN                    |  |
| D                     | DIRT / DRAINAGE                |  |
| DCDA                  | DOUBLE CHECK DETECTOR ASSEMBLY |  |
| FG                    | FINISHED GRADE                 |  |
| FH                    | FIRE HYDRANT                   |  |
| FL                    | FLOW LINE                      |  |
|                       |                                |  |

- FM FORCE MAIN
- NATURAL GAS (LOW PRESSURE)
- GB GRADE BREAK
- HP HIGH POINT
- LF LINEAR FOOT
- LP LOW POINT
- MG NATURAL GAS (MEDIUM PRESSURE)
- MG MATCH EXISTING GRADE
- MH MANHOLE
- NS NATIVE SOIL
- NTS NOT TO SCALE P PAVEMENT
- PC POINT OF CURVATURE
- POC POINT OF CONNECTION
- POS POINT OF SERVICE
- PP POWER POLE
- PT POINT OF TANGENCY
- R RADIUS
- ROW RIGHT OF WAY
- S SLOPE / SANITARY SAN SEWER SEWER
- SSMH SANITARY MANHOLE
- STA STATION
- STM STORM DRAIN
- STMH STORM MANHOLE
- TBD TO BE DETERMINED
- TBL TO BE RELOCATED BY RESPECTIVE UTILITY
- TBR TO BE REMOVED BY CONTRACTOR TC TOP OF CURB
- TOE TOE OF BANK TOP TOP OF BANK
- TP TELEPHONE POLE
- U UNDERGROUND
- VIP VERIFY IN FIELD PRIOR TO CONSTRUCTION
- W WATER MAIN
- XFMR TRANSFORMER



SURVEYOR NORTHERN LAND SURVEYING, LLC BATTLE GROUND, WA 98604 EVAN MARTTILA PHONE: (360) 553-5992 EMAIL: EVAN@NORTHERN-LS.COM

GEOTECHNICAL ENGINEER STRATA DESIGN, LLC PORTLAND, OR 97232 CONTACT: RANDY GOODE PHONE: (360) 450-7574 EMAIL: RANDY@STRATA-DESIGN.COM

# GENERAL PLAN NOTES (PRIVATE)

1. CONTRACTOR TO VERIFY ALL UTILITY LOCATIONS AND DEPTHS PRIOR TO CONSTRUC TWO FULL BUSINESS DAYS PRIOR TO BEGINNING CONSTRUCTION, THE CONTRACTOR S NOTIFICATION CENTER) FOR LOCATION MARK-UP OF EXISTING UTILITIES

2. ALL CONSTRUCTION, MATERIALS, AND WORKMANSHIP SHALL CONFORM TO THE LATE PRACTICES OF THE COWLITZ COUNTY AND THE LATEST EDITION OF THE "STANDARD SP ROAD, BRIDGE, AND MUNICIPAL CONSTRUCTION" PREPARED BY WSDOT/APWA

3. IN CASE OF A CONFLICT BETWEEN THE REGULATORY STANDARDS OR SPECIFICATION STRINGENT REQUIREMENT WILL PREVAIL.

4. ANY CHANGES TO THE DESIGN AND/OR CONSTRUCTION SHALL BE APPROVED BY THE

5. APPROVAL OF THESE PLANS DOES NOT CONSTITUTE AN APPROVAL OF ANY OTHER C SPECIFICALLY SHOWN ON THE PLANS. PLANS FOR STRUCTURES SUCH AS BRIDGES, BU VAULTS, ROCKERIES, AND RETAINING WALLS MAY REQUIRE A SEPARATE REVIEW AND A BUILDING DEPARTMENT PRIOR TO CONSTRUCTION.

6. A COPY OF THESE APPROVED PLANS SHALL BE ON THE JOB SITE WHENEVER CONSTR PROGRESS.

7. IT SHALL BE THE CONTRACTOR'S RESPONSIBILITY TO OBTAIN ALL CONSTRUCTION EA PERMITS NECESSARY TO PERFORM THE WORK.

8. THE CONTRACTOR IS RESPONSIBLE FOR ALL CONSTRUCTION STAKING.

9. PUBLIC AND PRIVATE DRAINAGE WAYS SHALL BE PROTECTED FROM POLLUTION. NO I DISCHARGED TO OR DEPOSITED IN STORMWATER SYSTEMS THAT MAY RESULT IN VIOL FEDERAL WATER QUALITY STANDARDS.

10. ALL CONSTRUCTION WITHIN THE PUBLIC RIGHT-OF-WAY SHALL HAVE AN APPROVED WORK PERMIT PRIOR TO ANY CONSTRUCTION ACTIVITY WITHIN THE RIGHT-OF- WAY.

11. THE CONTRACTOR SHALL BE RESPONSIBLE FOR PROVIDING ADEQUATE SAFEGUARE PROTECTIVE EQUIPMENT, FLAGGERS, AND ANY OTHER NEEDED ACTIONS TO PROTECT SAFETY OF THE PUBLIC. AND TO PROTECT PROPERTY IN CONNECTION WITH THE PERFO COVERED BY THE CONTRACTOR, ALL TRAFFIC CONTROL DEVICES SHALL CONFORM TO EDITION OF THE "MANUAL ON UNIFORM TRAFFIC CONTROL DEVICES" (MUTCD) PUBLISHE DEPARTMENT OF TRANSPORTATION. TWO-WAY TRAFFIC MUST BE MAINTAINED AT ALL T ADJACENT PUBLIC STREETS.

12. ANY PUBLIC OR PRIVATE CURB, GUTTER, SIDEWALK, OR ASPHALT DAMAGED DURING SHALL BE REPAIRED TO CITY/COUNTY STANDARDS AND PRACTICES.

13. THE CONTRACTOR SHALL BE RESPONSIBLE FOR MAINTAINING THE INTEGRITY OF AD WHICH MAY INCLUDE, BUT ARE NOT LIMITED TO, WATER, SANITARY SEWER, STORMWAT TELEPHONE, CABLE TV, GAS, IRRIGATION, AND STREET LIGHTING. THE CONTRACTOR SH RESIDENTS AND BUSINESSES 48 HOURS IN ADVANCE OF ANY WORK AFFECTING ACCESS SHALL MINIMIZE INTERRUPTIONS TO DRIVEWAYS FOR RESIDENTS AND BUSINESSES AD. PROJECT.

14. ALL LAWN AND VEGETATED AREAS DISTURBED WILL BE RESTORED TO ORIGINAL CO DISTURBANCE OR DAMAGE TO OTHER PROPERTY ON ADJACENT PARCELS OR IN THE PL SHALL ALSO BE REPAIRED OR RESTORED TO ORIGINAL CONDITION.

15. ALL MATERIALS AND METHODS OF CONSTRUCTION AND INSTALLATION FOR WATER, STORM FACILITIES SHALL CONFORM TO THE CITY OF WOODLAND DESIGN GUIDELINES. BE AS PER THE MOST CURRENT STANDARD DETAIL CONTAINED THEREIN.

16. THE TYPES, LOCATIONS, SIZES AND/OR DEPTHS OF EXISTING UNDERGROUND UTILIT AS SHOWN ON THE DRAWINGS ARE APPROXIMATE AND WERE OBTAINED FROM SOURCE RELIABILITY. THE CONTRACTOR IS CAUTIONED THAT ONLY ACTUAL EXCAVATION WILL R EXTENT, SIZES, LOCATIONS, AND DEPTHS OF UTILITIES. A REASONABLE EFFORT HAS BE AND DELINEATE ALL KNOWN UNDERGROUND UTILITIES. THE CONTRACTOR SHALL VERIF AND PROVIDE PROTECTION FOR ALL UTILITIES AND STRUCTURES. OVERHEAD UTILITIES

17. EXISTING UTILITIES DAMAGED BY THE CONTRACTOR SHALL BE REPAIRED BY THE CO UTILITY.

18. WHERE THE CONTRACTOR MUST RELOCATE WATER AND GAS UTILITIES, SHUTDOWN ACCOMPLISHED BY THE CITY OR UTILITY PURVEYOR.

19. ALL OPEN TRENCHES THAT IMPACT PUBLIC ACCESS OR OTHER PROJECT WORK ACC PROJECTS SITE, MUST BE STEEL PLATED OR BACKFILLED AND PAVED WITH AT LEAST 2" ADJACENT EXISTING GRADE AT THE END OF EACH WORKDAY.

20. NOTIFY ADJACENT RESIDENCES AT LEAST ONE DAY PRIOR TO COMMENCING WORK. RESIDENCES.

21. SAWCUT ALL PAVEMENT JOINT LINES. WHERE THERE IS A PREVIOUS PAVING EDGE C THE SAWCUT EDGE, REMOVE THE PAVEMENT TO THE PREVIOUS PAVING EDGE.

22. THE CONTRACTOR SHALL COMPLY WITH WASHINGTON REQUIREMENTS FOR TRENCH

23. THE CONTRACTOR SHALL REPLACE ALL SURVEY MONUMENTS THAT ARE DESTROYE CONSTRUCTION.

24. ALL WATER PIPING SHALL BE CONSTRUCTED WITH 3' MINIMUM COVER, 1' VERTICAL S UTILITIES, AND A MINIMUM OF 10' HORIZONTAL SEPARATION AND 18" ABOVE SEWER LINE OTHERWISE NOTED.

25. THE CONTRACTOR SHALL RESTORE PAVEMENT AND LANDSCAPING DISTURBED BY T THE PREVIOUSLY UNDISTURBED CONDITION.

26. CONTRACTOR TO DISPOSE OF TREES, SHRUBS, SOD AND OTHER DEBRIS IN A PROPER MANNER OF THE CONTRACTOR'S CHOOSING.

| <b>ר</b>                             | Revisions: | LINE IS 1" ON FULL<br>SCALE DRAWING |                             |                                |
|--------------------------------------|------------|-------------------------------------|-----------------------------|--------------------------------|
| o                                    |            |                                     |                             | Ridgefi                        |
|                                      |            |                                     |                             | Duluth                         |
| low.                                 |            |                                     |                             | WWW.W                          |
| <b>E YOU DIG.</b><br>NIS ADDROXIMATE |            |                                     | <b>NINDSOR</b><br>ENGINEERS | Copyright 202<br>All Rights Re |

ALL 2 BUSINESS DAYS BEFOR AUTION UTILITY INFORMATION IS AF ERIFY ALL UTILITIES PRIOR TO CONSTRUCTION.

# CENERAL CIVIL NOTES

|  | GENERAL CIVIL NOTES  | DOE STAN   |
|--|--|--|
| ICTION. A MINIMUM OF<br>SHALL CALL 811 (UTILITY                                  | SURVEY<br>TOPOGRAPHIC SURVEY BY: NORTHERN LAND SURVEYING LLC<br>HORIZONTAL DATUM: LOCAL COORDINATE SYSTEM  | 1. APPROVAL O<br>OF PERMANEN <sup>T</sup><br>CHANNELS, RE <sup>T</sup> |
| TEST STANDARDS AND<br>SPECIFICATIONS FOR   | ELEVATION DATUM: NAVD 88<br>STORM DRAINAGE:<br>ON-SITE STORM SEWER IMPROVEMENTS SHALL CONFORM TO THE LATEST VERSION OF THE UPC, AND<br>CONFORM TO WSDOT SPECIFICATIONS WHERE NOTED.  | 2. The impleme<br>and upgradin<br>all construc                         |
| DNS, THE MORE  | THE CONTRACTOR SHALL MAINTAIN 6" MINIMUM VERTICAL AND 3' MINIMUM HORIZONTAL CLEARANCE (OUTSIDE SURFACES) BETWEEN STORM DRAIN PIPES AND OTHER UTILITY PIPES AND CONDUITS. FOR CROSSINGS OF  | 3. THE BOUNDA<br>FIELD PRIOR TO<br>FLAGGED CLEA                        |
| HE OWNER OR ENGINEER.<br>CONSTRUCTION NOT<br>UILDINGS, TANKS,<br>APPROVAL BY THE | SANITARY SEWER LINES, THE WASHINGTON DEPARTMENT OF ECOLOGY CRITERIA APPLY.<br>ALL CATCH BASINS SHALL BE LABELED WITH "NO DUMPING*PROTECT WATER*ONLY RAIN IN DRAIN"<br>MEDALLIONS. MEDALLIONS SHALL BE AFFIXED TO DRY SURFACE WITH HIGH QUALITY POLYURETHANE<br>SEALANT AND RIVETS.   | 4. THE ESC FAC<br>AND GRADING  |
| TRUCTION IS IN   | SEALANT AND RIVETS.<br>STORM DRAIN PIPE, BENDS, AND FITTINGS SHALL BE PVC, ASTM D 3034, SDR 35, OR SMOOTH INTERIOR, HIGH<br>DENSITY POLYETHYLENE CORRUGATED PIPE AASHTO M252 OR M294, TYPE S AS PRODUCED AND SPECIFIED BY<br>ADS, PRODUCT NAME N12, OR APPROVED EQUAL. ALL STORM SEWER FITTINGS AND PIPE JOINTS SHALL BE<br>GASKETED.  | 5. THE ESC FAC<br>CONDITIONS, D<br>FOR UNEXPECT<br>LEAVE THE SITE      |
| EASEMENTS AND  | 2' SUMP INCLUDED ON ALL CATCH BASIN MANHOLES. 1.5' MIN SUMP INCLUDED ON CATCH BASINS.  | 6. THE ESC FAC   |
|  | PERFORATED PIPE SHALL BE ADS SINGLE WALL PERFORATED PIPE WITH SOCK OR APPROVED EQUAL.  | NECESSARY TO   |
| D MATERIAL IS TO BE  | ALL STORM SEWER PIPE SHALL HAVE A MINIMUM 12" DIAMETER WITHIN ROADWAY  | 7. THE ESC FAC<br>MONTH OR WIT   |
| LATION OF STATE OR   | ALL ON-SITE STORMWATER FACILITIES SHALL BE PRIVATELY MAINTAINED BY THE CURRENT OR FUTURE   | 8. AT NO TIME S  |
| D PUBLIC RIGHT-OF-WAY  | PROPERTY OWNER(S).   | CATCH BASIN. A<br>CLEANING OPE   |
| RDS, SAFETY DEVICES,<br>T THE LIFE, HEALTH, AND                                  | ALL VAULT, UTILITY BOX, INLET, MANHOLE AND CLEANOUT RIMS SHALL BE ADJUSTED TO FINISH GRADE<br>UNLESS OTHERWISE NOTED.<br>IT SHALL BE THE CONTRACTOR'S RESPONSIBILITY TO PROTECT AND MAINTAIN ANY STORM SYSTEM PIPING TO  | 9. STABILIZED C<br>MAINTAINED FC<br>PAVED AREAS A                      |
| FORMANCE OF WORK   | EXISTING DRAINAGE APPURTENANCES TO REMAIN.   | 10. THE PROPO  |
| HED BY THE U.S.<br>TIMES ON THE  | SANITARY SEWER:<br>ON-SITE (PRIVATE) SANITARY SEWER IMPROVEMENTS SHALL CONFORM TO THE LATEST VERSION OF THE IBC,<br>THE UPC, AND WSDOT SPECIFICATIONS WHERE NOTED AND THE CITY OF WOODLAND GENERAL<br>REQUIREMENTS.  | VEGETATION TI<br>INUNDATED WIT<br>PRIOR TO PROJ                        |
| IG CONSTRUCTION  | SANITARY SEWER PIPE SHALL BE POLYVINYL CHLORIDE (PVC) AND CONFORM TO ASTM D3034, SDR35.  | RECOMME  |
| ADJACENT UTILITIES   | CONTRACTOR SHALL COORDINATE ALL BUILDING SANITARY CONNECTIONS WITH PLUMBING PLAN PRIOR TO  | 1. PRE-CONSTR  |
| ATER, POWER,<br>SHALL NOTIFY   | CONSTRUCTION.  | 2. FLAG OR FEN   |
| SS OR SERVICE AND<br>DJACENT TO THE  | CONTRACTOR IS RESPONSIBLE FOR ALL PERMITS AND INSPECTIONS.   | 3. POST NOTICE<br>SEDIMENT CON   |
|  | WATER:<br>ALL WATERMAIN INSTALLATION, DISINFECTION AND TESTING SHALL COMPLY WITH WSDOT STANDARD  | 4. INSTALL CAT   |
| ONDITION. ANY<br>PUBLIC RIGHT OF WAY   | SPECIFICATIONS. UNIFORM PLUMBING CODE, AND CITY OF WOODLAND WATER DESIGN AND CONSTRUCTION STANDARDS.   | 5. INSTALL PER   |
|  | FIRE SPRINKLER:<br>UNDERGROUND FIRE SPRINKLER SUPPLY MAINS SHALL BE INSTALLED ONLY BY CONTRACTORS IN   | 6. INSTALL TRE   |
| R, SANITARY SEWER, AND<br>S. CONSTRUCTION SHALL                                  | COMPLIANCE WITH WAC 212-80   | 7. GRADE AND I   |
| ITIES AND STRUCTURES   | ARCHAEOLOGY<br>IF ANY CULTURAL RESOURCES AND/OR HUMAN REMAINS ARE DISCOVERED IN THE COURSE OF UNDERTAKING  | 8. CONSTRUCT   |
| CES OF VARYING<br>REVEAL THE TYPES,  | THE DEVELOPMENT ACTIVITY, THE DEPARTMENT OF ARCHAEOLOGY AND HISTORIC PRESERVATION IN<br>OLYMPIA AND COWLITZ COUNTY SHALL BE NOTIFIED. FAILURE TO COMPLY WITH THESE STATE REQUIREMENTS  | 9. GRADE AND   |
| BEEN MADE TO LOCATE<br>RIFY THE LOCATION OF                                      | MAY CONSTITUTE A CLASS C FELONY, SUBJECT TO IMPRISONMENT AND/OR FINES.   | 10. CONSTRUCT  |
| ES ARE NOT SHOWN.<br>CONTRACTOR OR BY THE  | STANDARD DETAIL STATEMENT<br>ALL MATERIALS AND METHODS OF CONSTRUCTION AND INSTALLATION FOR WATER, SEWER, STORM WATER<br>FACILITIES, AND EROSION CONTROL MEASURES, SHALL CONFORM TO CITY OF WOODLAND ENGINEERING<br>SERVICES "WOODLAND DEVELOPMENT GUIDELINES." CONSTRUCTION SHALL BE AS PER THE MOST CURRENT  | 11. MAINTAIN EI<br>FOR WESTERN   |
| /N SHALL ONLY BE   | STANDARD DETAIL CONTAINED THEREIN.   | 12. RELOCATE S   |
|  | GRADING & EROSION CONTROL NOTES  | SO THAT AS SIT<br>WITH THE COW   |
| CESS OUTSIDE OF THIS<br>2" OF COLD MIX TO  | NO GRADING WITHIN 2' OF ADJACENT PARCELS PER IBC.  | 13. COVER ALL<br>TWO DAYS DUF  |
| K ADJACENT TO THEIR  | STRIP ORGANICS PER GEOTECH REPORT. RE-DEPOSIT ABOVE COMPACTED FILL TO A MAX DEPTH OF 6" (12" IN LANDSCAPE AREAS).  | EQUIVALENT.  |
|  | FINISH GRADE CONTOURS ARE TO TOP OF FINISHED SURFACE IN IMPERVIOUS AREAS AND TOP OF REPLACED STRIPPINGS IN PERVIOUS AREAS.   | 14. STABILIZE A<br>15. SEED OR SC                                      |
| OR CRACK WITHIN 5' OF  | STRIPPINGS TO REMAIN ON SITE AND BE RE-DISTRIBUTED OVER LANDSCAPE AREAS AFTER ALL GRADING<br>ACTIVITIES ARE COMPLETED. CONTRACTOR SHALL BE RESPONSIBLE FOR HAUL-OFF OF EXCESS MATERIAL.  | 16. ALL DISTURI<br>NEED TO BE AM                                       |
| CH SAFETT.<br>(ED BY THE   | CUT AND FILL QUANTITIES ARE BASED ON GENERAL SITE GRADING ESTABLISHED FROM THE STRIPPED GRADE  |  |
| SEPARATION BETWEEN   | TO THE FINISHED PROPOSED SUBGRADE AND TRENCH SPOILS. THESE VOLUMES DO NOT TAKE INTO ACCOUNT<br>ANY UNKNOWN SOIL DEPOSITS OR OVER-EXCAVATION OF NON-ORGANIC MATERIALS THAT ARE DISCOVERED<br>ON SITE, NOR WET WEATHER CONDITIONS. CONTRACTOR SHALL BE RESPONSIBLE TO PRODUCE INDEPENDENT<br>GRADING VOLUMES AS WELL AS ACCOUNT FOR OBSERVATION OF MEASURES DIRECTED WITHIN THE<br>GEOTECHNICAL REPORT OR AS DIRECTED BY THE GEOTECHNICAL ENGINEER DURING THE COURSE OF<br>CONSTRUCTION. | 17. UPON COMF<br>MANAGEMENT  |
| THE CONSTRUCTION TO  | PRIOR TO ACCEPTANCE OF THE COMPACTED SUB-GRADE, THE CONTRACTOR SHALL PROVIDE A TEST ROLL IN<br>THE PRESENCE OF OWNER / CITY REPRESENTATIVE UNLESS OTHERWISE APPROVED BY THE GEOTECHNICAL   |  |

# DOE STANDARD NOTES FOR EROSION CONTROL PLAN

OF THIS EROSION/SEDIMENTATION CONTROL (ESC) PLAN DOES ENT ROAD OR DRAINAGE DESIGN (E.G. SIZE AND LOCATION OF R RETENTION FACILITIES, UTILITIES, ETC.)

MENTATIONS OF THESE ESC PLANS AND THE CONSTRUCTIONS. ING OF THESE ESC FACILITIES IS THE RESPONSIBILITY OF THE JCTION IS COMPLETED AND APPROVED AND VEGETATION/LAND

ARIES OF THE CLEARING LIMITS SHOWN ON THIS PLAN SHALL TO CONSTRUCTION. DURING THE CONSTRUCTION PERIOD, NO I ARING LIMITS SHALL BE PERMITTED. THE FLAGGING SHALL BE ONTRACTOR FOR THE DURATION OF CONSTRUCTION.

ACILITIES SHOWN ON THIS PLAN MUST BE CONSTRUCTED IN CC G ACTIVITIES, AND IN SUCH A MANNER AS TO INSURE THAT SED OT ENTER THE DRAINAGE SYSTEMS, ROADWAYS, OR VIOLATE A

ACILITIES SHOWN ON THIS PLAN ARE THE MINIMUM REQUIREME DURING THE CONSTRUCTION PERIOD, THESE ESC FACILITIES S CTED STORM EVENTS AND TO ENSURE THAT SEDIMENT AND SE

ACILITIES SHALL BE INSPECTED DAILY BY THE APPLICANT/CONT TO ENSURE THEIR CONTINUED FUNCTIONING.

ACILITIES ON INACTIVE SITES SHALL BE INSPECTED AND MAINT/ THIN THE 48 HOURS FOLLOWING A STORM EVENT.

SHALL MORE THAN ONE FOOT OF SEDIMENT BE ALLOWED TO . . ALL CATCH BASINS AND CONVEYANCE LINES SHALL BE CLEAN PERATIONS SHALL NOT FLUSH SEDIMENT LADEN WATER INTO TI

CONSTRUCTION ENTRANCES SHALL BE INSTALLED AT THE BE FOR THE DURATION OF THE PROJECT, ADDITIONAL MEASURES SARE KEPT CLEAN FOR THE DURATION OF THE PROJECT.

OSED STORMWATER FACILITY MUST REMAIN OFFLINE UNTIL TH THROUGHOUT THE SITE HAS BEEN ESTABLISHED. IF AT ANY TIM NITH SEDIMENT FILLED RUNOFF, THE TOP 2" OF MATERIAL MUST OJECT COMPLETION.

# IENDED CONSTRUCTION SEQUENCE FOR E

**FRUCTION MEETING.** 

ENCE CLEARING LIMITS

ICE OF CONSTRUCTION ACTIVITY SIGN WITH THE NAME AND PHO ONTROL SUPERVISOR.

ATCH BASIN PROTECTION, IF REQUIRED.

RIMETER PROTECTION (SILT FENCE, BRUSH BARRIER, ETC.).

REE PROTECTION FENCING.

D INSTALL CONSTRUCTION ENTRANCE(S).

CT SEDIMENT POND(S) AND TRAP(S).

ID STABILIZE CONSTRUCTION ROADS.

ICT SURFACE WATER CONTROLS (INTERCEPT DIKES, PIPE SLOP NG AND GRADING FOR PROJECT DEVELOPMENT.

EROSION CONTROL MEASURES IN ACCORDANCE WITH STORM RN WASHINGTON AND MANUFACTURER'S RECOMMENDATIONS

SURFACE WATER CONTROLS AND EROSION CONTROL MEASU SITE CONDITIONS CHANGE THE EROSION AND SEDIMENT CONT WLITZ COUNTY EROSION AND SEDIMENT CONTROL STANDARDS

L AREAS THAT WILL BE UNWORKED FOR MORE THAN SEVEN DA JRING THE WET SEASON WITH STRAW, WOOD FIBER MULCH, C

ALL AREAS THAT REACH FINAL GRADE WITHIN SEVEN DAYS.

SOD ANY AREAS TO REMAIN UNWORKED FOR MORE THAN 30 DA RBED PERVIOUS AREAS MUST MEET BMP T5.13 IN THE 2019 MA AMENDED TO REACH APPROVED RATES, OR IMPORT TOPSOIL W ID WIDTH.

IPLETION OF THE PROJECT, ALL DISTURBED AREAS MUST BE S F PRACTICES REMOVED IF APPROPRIATE.

field, WA ı + Minneapolis, MN windsorengineers.com

ENGINEER.



THE PRESENCE OF OWNER / CITY REPRESENTATIVE UNLESS OTHERWISE APPROVED BY THE GEOTECHNICAL

# **438 HOMESTEAD** 438 WASHINGTON STREET, WOODLAND, WA 98674

# SITE PLAN REVIEW

Project No: 21035.1 Issue Date: 6/21/2023

| PLAN   | AMERICANS WITH DISABILITIES ACT (ADA) NOTES   |
|--|---|
| ES NOT CONSTITUTE AN APPROVAL<br>ROADS, PIPES, RESTRICTIONS,                                 | 1. CONTRACTORS SHALL EXERCISE APPROPRIATE CARE AND PRECISION IN CONSTRUCTION OF ADA ACCESSIBLE COMPONENTS ON THE PROJECT, THE ADA COMPONENTS MUST COMPLY WITH ALL LOCAL, STAT AND FEDERAL ACCESSIBILITY RULES, CODES, AND REGULATIONS.  |
| IS, MAINTENANCE, REPLACEMENT,<br>E APPLICANT/CONTRACTOR, UNTIL<br>NDSCAPING IS ESTABLISHED.  | 2. FINISHED SURFACES ALONG THE ACCESSIBLE PATH OF TRAVEL FROM PARKING STALLS, PUBLIC<br>TRANSPORTATION, AND PEDESTRIAN ACCESS WAYS TO THE POINT(S) OF ACCESSIBLE BUILDING INGRESS AN<br>EGRESS SHALL COMPLY WITH ADA CODE REQUIREMENTS.   |
| L BE CLEARLY FLAGGED IN THE<br>D DISTURBANCE BEYOND THE                                      | 3. PARKING SPACE AND AISLE SLOPE SHALL NOT EXCEED 1:48 (1/4" PER FOOT OR NOMINALLY 2.0%) IN ANY DIRECTION.  |
| E MAINTAINED BY THE  | 4. CURB RAMP SLOPE SHALL NOT EXCEED 1:12 (8.3%) AND RAMP LENGTH IS LIMITED TO 15 FEET.  |
| CONJUNCTION WITH ALL CLEARING<br>EDIMENT AND SEDIMENT LADEN<br>E APPLICABLE WATER STANDARDS. | 5. LANDINGS SHALL BE PROVIDED AT EACH END OF RAMPS, SHALL HAVE POSITIVE DRAINAGE, AND SHALL NC EXCEED 1:48 (1/4"PER FOOT OR NOMINALLY 2.0%) IN ANY DIRECTION.   |
| MENTS FOR ANTICIPATED SITE<br>S SHALL BE UPGRADED AS NEEDED<br>SEDIMENT LADEN WATER DO NOT   | 6. PATH OF TRAVEL ALONG ACCESSIBLE ROUTE SHALL PROVIDE A MINIMUM OF 36 INCH UNOBSTRUCTED WIDTH OF TRAVEL. SLOPE SHALL BE NO GREATER THAN 1:20 (5.0% OR 5/8" PER FOOT) IN THE DIRECTION OF TRAVEL, AND SHALL NOT EXCEED 1:48 (1/4" PER FOOT OR NOMINALLY 2.0%) IN CROSS SLOPE. WHERE PATH OF TRAVEL BE GREATER THAN 1:20 (5.0%), AN ACCESSIBLE RAMP WITH A MAXIMUM SLOPE OF 1:12 (8.3%) FOR A MAXIMUM DISTANCE OF 30 FEET SHALL BE PROVIDED INCLUDING HANDRAILS. THE RAMP SHALL HAVE ACCESSIBLE HAND RAILS AND LANDINGS ON EACH END WITH A SLOPE IN ANY DIRECTION NOT EXCEEDING 1: |
| NTRACTOR AND MAINTAINED AS   | (1/4" PER FOOT OR NOMINALLY 2.0%).  |
| ITAINED A MINIMUM OF ONCE A  | 7. DOORWAYS SHALL HAVE A LANDING AREA ON THE EXTERIOR SIDE OF THE DOOR THAT IS SLOPED NO MOR<br>THAN 1:48 (1/4" PER FOOT OR NOMINALLY 2.0%) FOR POSITIVE DRAINAGE. THIS LANDING AREA SHALL BE NO<br>LESS THAN 60 INCHES (5 FEET) LONG, EXCEPT HERE OTHERWSE PERMITTED BY ACCESSIBILITY STANDARDS<br>FOR ALTERNATIVE DOORWAY OPENING CONDITIONS AND APPROVED BY THE OWNER'S REPRESENTATIVE.  |
| O ACCUMULATE WITHIN A TRAPPED<br>ANED PRIOR TO PAVING. THE<br>THE DOWNSTREAM SYSTEM.         | 8. WHERE PEDESTRIAN ACCESS ROUTES ARE CONTAINED WITHIN A STREET OR HIGHWAY RIGHT-OF-WAY, TH<br>GRADE OF THE PEDESTRIAN ACCESS ROUTE IS PERMITTED TO EQUAL THE GENERAL GRADE ESTABLISHED<br>FOR THE ADJACENT STREET OR HIGHWAY, EXCEPT THAT WHERE PEDESTRIAN ACCESS ROUTES ARE   |
| EGINNING OF CONSTRUCTION AND<br>S MAY BE REQUIRED TO ENSURE ALL                              | CONTAINED WITHIN PEDESTRIAN STREET CROSSINGS A MAXIMUM GRADE OF 5 PERCENT IS REQUIRED.<br>(EXCERPT FROM PROWAG)   |
| THE PROJECT IS COMPLETE AND  | GENERAL FIRE NOTES  |
| TIME THE FACILITY BECOMES<br>ST BE REMOVED AND REPLACED                                      | 1. GENERAL FIRE SAFETY PRECAUTIONS SHALL BE MAINTAINED, IN ACCORDANCE WITH CHAPTER 33 OF THE INTERNATIONAL FIRE CODE; FIRE SAFETY DURING CONSTRUCTION   |
| EROSION CONTROL  | 2. ALL WORK SUBJECT TO FIELD INSPECTION AND CORRECTION(S) AS IDENTIFIED AT THE TIME OF THE ON-SI<br>INSPECTION; ALL WORK SHALL BE COMPLIANT WITH THE APPLICABLE STANDARDS AND CODES; TO INCLUDE<br>THE ADOPTED EDITION OF THE INTERNATIONAL FIRE CODE AND THE CITY'S MUNICIPAL CODE.  |
|  | 3. ALL FIRE ALARM AND FIRE SPRINKLERS SHALL BE SUBMITTED SEPARATELY AND DIRECTLY TO THE FIRE MARSHAL.   |
| HONE NUMBER OF EROSION   | 4. MODIFICATIONS FOR FUTURE TENANT IMPROVEMENT(S) MAY REQUIRE AN ALTERNATE PLANS RE-SUBMITTAL.  |
|  | 5. APPENDIX D FOR FIRE APPARATUS ACCESS ROADSALL ON-SITE PRIVATE UNDERGROUND FIRE<br>SUPPRESSION WATER SUPPLY SHALL BE SUBMITTED TO THE FIRE MARSHAL (THIS INLCUDES PRIVATE<br>HYDRANTS, UNDERGROUND FOR FDC'S AND FIRE SPRINKLER UNDERGROUND CONNECTIONS).   |
|  | 6. IFC APPENDIX D FIRE APPARATUS ACCESS ROADS. WHERE HYDRANTS ARE ON A FIRE APPARATUS ACCESS ROAD, THE MINIMUM WITH OF THE ROAD SHALL BE 26 FEET FOR A DISTANCE OF 20 FEET; 10 FEET IN EITHER DIRECTION.  |
| OPE DRAINS, ETC) SIMULTANEOUSLY  | 7. IFC 503.3 MARKING WHERE REQUIRED BY THE FIRE CODE OFFICIAL, APPROVED SIGNS OR OTHER APPROVE<br>NOTICES OR MARKINGS THAT INCLUDE THE WORDS NO PARKING FIRE LANE SHALL BE PROVIDED FOR FIRE<br>APPARATUS ACCESS ROADS TO IDENTIFY SUCH ROADS OR PROHIBIT THE OBSTRUCTION THEREOF. THE<br>MEANS BY WHICH FIRE LANES ARE DESIGNATED SHALL BE MAINTAINED IN A CLEAN AND LEGIBLE CONDITION<br>AT ALL TIMES AND BE REPLACED OR REPAIRED WHEN NECESSARY TO PROVIDE ADEQUATE VISIBILITY.  |
|  | <ul> <li>8. IFC D103.6 FIRE APPARATUS ACCESS PARKING RESTRICTIONSSIGNS: REQUIRED ROADWAYS MUST HAVE</li> </ul>  |
| MWATER MANAGEMENT MANUAL   | SIGNAGE FOR PARKING RESTRICTIONS AS FOLLOWS: SIGNS FOR NO-PARKINGFIRE LANE SHALL COMPLY WI<br>A MINIMUM DIMENSION OF 12 INCHES WIDE BY 18 INCHES HIGH AND HAVE RED LETTERS ON A WHITE   |
| SURE OR INSTALL NEW MEASURES<br>TROL IS ALWAYS IN ACCORDANCE<br>DS.                          | REFLECTIVE BACKGROUND. SIGN'S SHALL BE PROVIDED ON BOTH SIDES OF ALL STREETS THAT ARE LESS<br>THAN 26 IN WIDTH IN ACCORDANCE WITH LOCAL STANDARDS FOR ACCESS AND FUTURE ENFORCEMENT;<br>SIGNS FOR NO-PARKING MUST BE PROVIDED ON ONE SIDE OF ALL STREETS THAT ARE BETWEEN 26 AND 32 II<br>WIDTH ACCORDANCE WITH LOCAL STANDARDS FOR ACCESS AND FUTURE ENFORCEMENT.  |
| DAYS DURING THE DRY SEASON OR<br>COMPOST, PLASTIC SHEETING OR                                | 9. IFC 506 WHERE REQUIRED ACCESS IS RESTRICTED WITH A GATE, AN APPROVED PADLOCK OR KEY SWITCH<br>(FOR ELECTRONIC/AUTOMATED GATES) SHALL BE PROVIDED TO ALLOW FIRE DEPARTMENT ACCESS.  |
| DAYS.  | 10. IFC 503.1.1 / D102 / D103 ROADWAYS TO ACCESS STRUCTURES: THE PERIMETER OF ALL STRUCTURES MUS<br>BE WITHIN 150 FEET OF AN APPROVED ACCESS ROAD WITH A MINIMUM CLEAR WIDTH OF 20 FEET (26 FEET<br>WHERE A HYDRANT IS LOCATED). BUILDING SHALL BE INSTALLED WITH AUTOMATIC FIRE SPRINKLERS AS AN<br>ALTERNATIVE TO DISTANCE FROM A FIRE ACCESS ROAD.   |
| IANUAL. EXISTING TOPSOIL MAY<br>WITH SUFFICIENT ORGANIC                                      | 11. IFC 507.5.4 FIRE PROTECTION WATER SUPPLY: UNOBSTRUCTED ACCESS TO FIRE HYDRANTS SHALL BE<br>MAINTAINED AT ALL TIMES. THE FIRE DEPARTMENT SHALL NOT BE DETERRED OR HINDERED FROM GAINING<br>IMMEDIATE ACCESS TO FIRE PROTECTION EQUIPMENT OR FIRE HYDRANTS REQUIRED ACCESS ROADWAYS<br>AND HYDRANTS SHALL BE SERVICEABLE AND UNOBSTRUCTED PRIOR TO COMBUSTIBLE CONSTRUCTION.  |
| STABILIZED AND BEST  | GENERAL UTILITY SHEET NOTES:  |

## 1. MARK CURB AND GUTTER WITH A "W" OR "S" TO SHOW LOCATION OF UTILITY SERVICE LINE CROSSINGS.

2. SEE DETAIL SHEETS FOR CONSTRUCTION DETAILS SANITARY SEWER DETAILS - SHEET C604.

# **CIVIL NOTES AND ABBREVIATIONS**

Checked by


# AMEDICANIC WITH DIGABILITIES ACT (ADA) NOTES

# GENERAL UTILITY SHEET NUTES.

WATER DETAILS - SHEET C604.

Project Manager <u>DCK</u> Drawn by <u>CKJ/OK</u>

G002

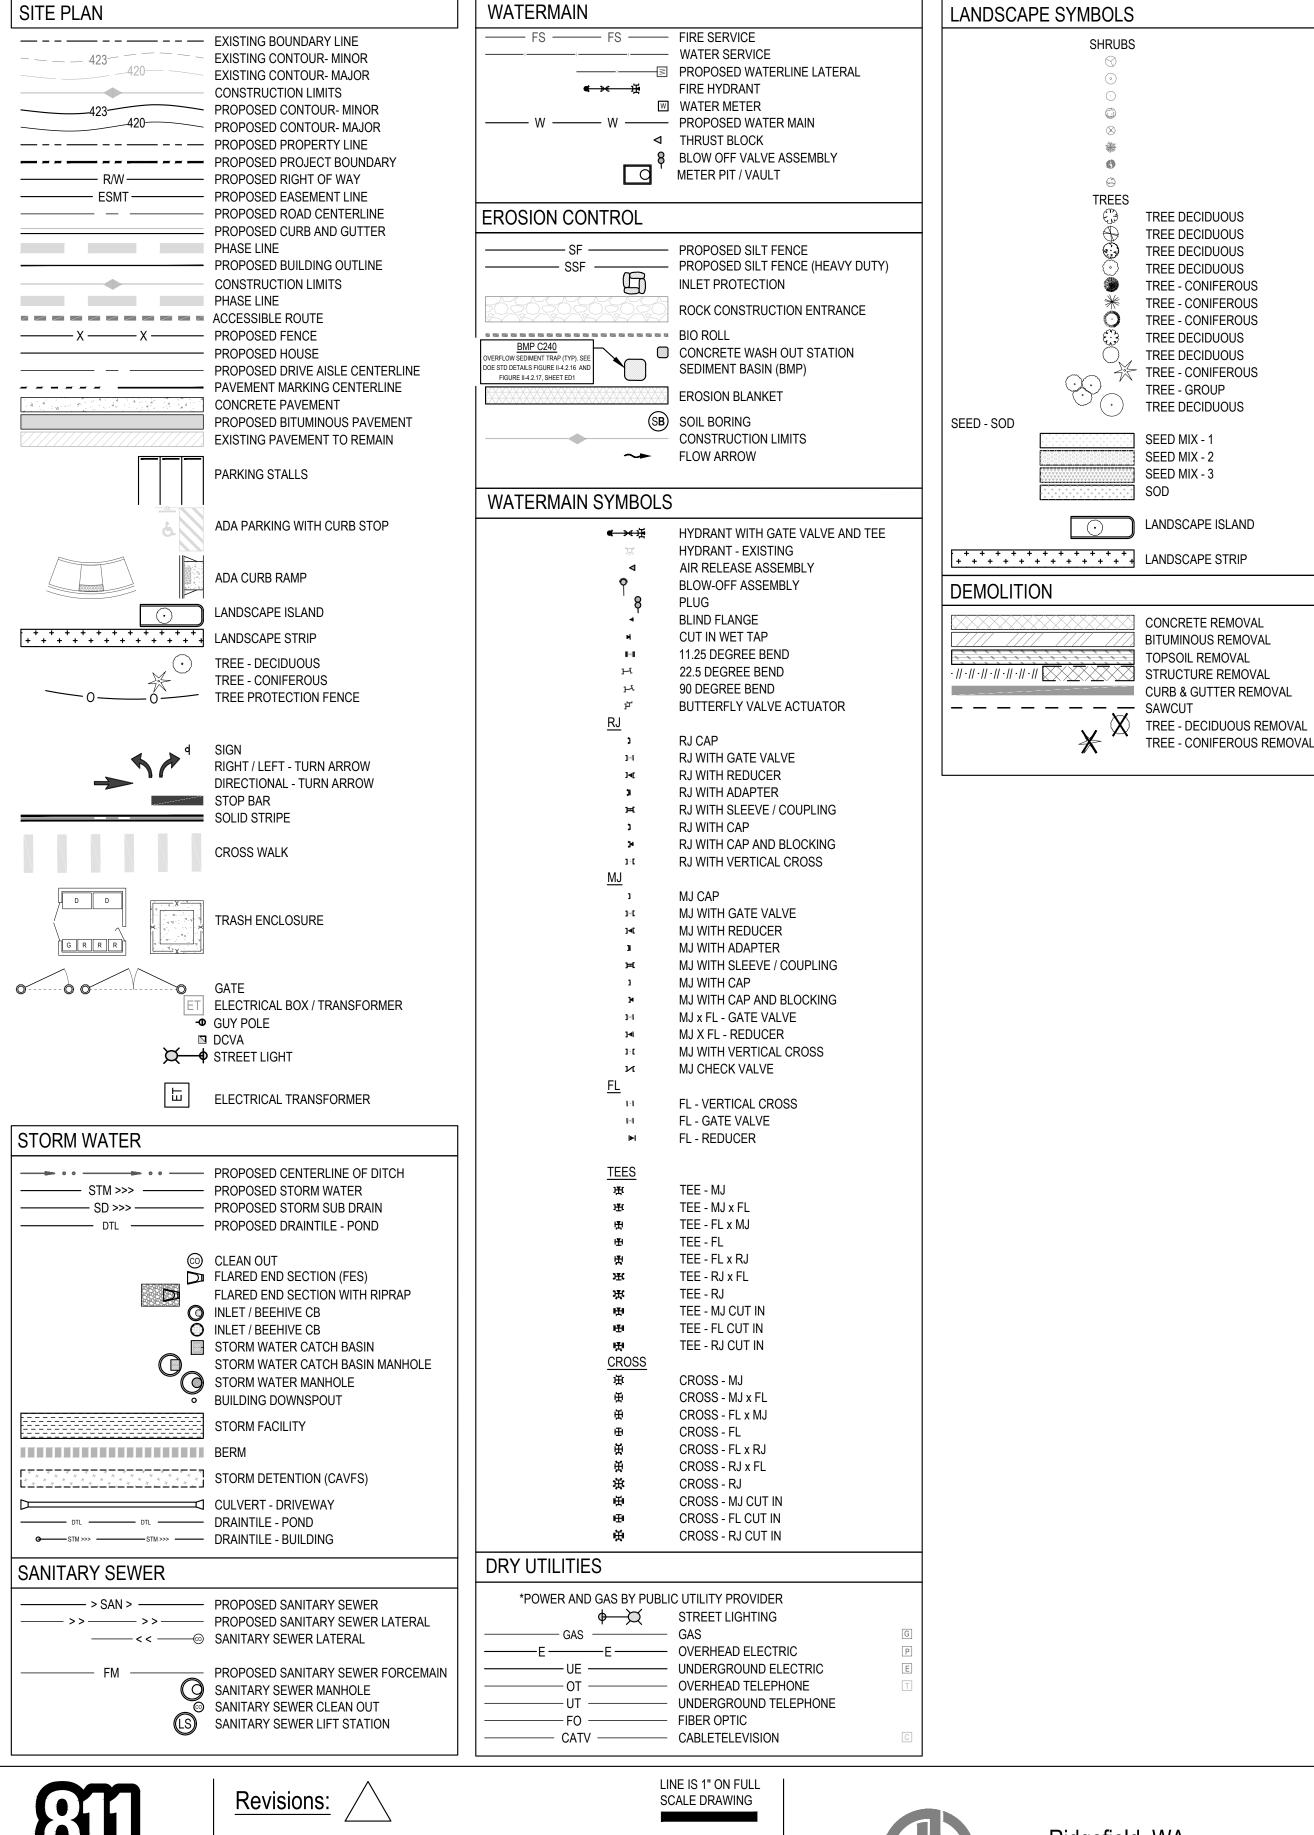



WINDSOR

ENGINEERS

| IBOLS   |                        |   | GENERAL ABBREVIATIONS  |  |  |
|---|------------------------|---|--|--|--|
| IBOLS<br>SHRUBS<br>©<br>©<br>©<br>©<br>©<br>©<br>©  | EXISTING SURVEY        | (E)<br>(E)<br>C<br>TED POSITION<br>CB<br>(WITH BOOK AND PAGE)<br>CL | EXISTING<br>CONCRETE<br>CATCH BASIN<br>CENTERLINE<br>S COMPACTED NATIVE SOIL<br>CLEAN OUT                            |  |  |
| ©<br>TREES<br>⊕ TREE DECIDUOUS<br>⊕ TREE DECIDUOUS  | CLEAN OUT (SANITAI     | RY) D<br>FG   | DIRT / DRAINAGE<br>FINISHED GRADE  |  |  |
| <ul> <li>TREE DECIDUOUS</li> <li>TREE DECIDUOUS</li> <li>TREE - CONIFEROUS</li> <li>TREE - CONIFEROUS</li> <li>TREE DECIDUOUS</li> <li>TREE DECIDUOUS</li> <li>TREE DECIDUOUS</li> <li>TREE - CONIFEROUS</li> <li>TREE - GROUP</li> <li>TREE DECIDUOUS</li> <li>SEED MIX - 1</li> </ul> | SANITARY SEWER LIN<br> | VE FH<br>FL<br>FM<br>G<br>GB<br>HP<br>LF<br>LP<br>MG<br>MG          | NATURAL GAS (LOW PRESSURE)<br>GRADE BREAK<br>HIGH POINT<br>LINEAR FOOT<br>LOW POINT<br>NATURAL GAS (MEDIUM PRESSURE) |  |  |
| SEED MIX - 2<br>SEED MIX - 3<br>SOD<br>LANDSCAPE ISLAND   | GRAVEL AREA            | MH<br>NS<br>NTS   | NATIVE SOIL<br>S NOT TO SCALE  |  |  |
| LANDSCAPE ISLAND  | ASPHALT AREA           | P<br>PC<br>PO(  |  |  |  |
| CONCRETE REMOVAL  |                        | POS<br>PP<br>PT   | S POINT OF SERVICE<br>POWER POLE<br>POINT OF TANGENCY  |  |  |

# XISTING ONCRETE

- ATCH BASIN
- ENTERLINE
- OMPACTED NATIVE SOIL
- LEAN OUT
- URB RETURN
- )IRT / DRAINAGE
- INISHED GRADE
- IRE HYDRANT LOW LINE
- ORCE MAIN
- ATURAL GAS (LOW PRESSURE)
- GRADE BREAK
- IGH POINT INEAR FOOT
- OW POINT
- ATURAL GAS (MEDIUM PRESSURE)
- ATCH EXISTING GRADE
- ANHOLE ATIVE SOIL
- OT TO SCALE
- AVEMENT
- OINT OF CURVATURE
- OINT OF CONNECTION
- OINT OF SERVICE
- OWER POLE OINT OF TANGENCY
- R RADIUS
- ROW RIGHT OF WAY
- S SLOPE / SANITARY
- SAN SEWER SEWER
- SSMH SANITARY MANHOLE
- STA STATION
- STM STORM DRAIN
- STMH STORM MANHOLE TBD TO BE DETERMINED
- TBL TO BE RELOCATED BY RESPECTIVE UTILITY
- TBR TO BE REMOVED BY CONTRACTOR
- TC TOP OF CURB
- TOE TOE OF BANK
- TOP TOP OF BANK
- TP TELEPHONE POLE
- U UNDERGROUND
- VIP VERIFY IN FIELD PRIOR TO CONSTRUCTION
- W WATER MAIN

# SITE - ABBREVIATIONS

FFE - FIRST FLOOR FINISH ELEVATION LLE - LOWER LEVEL FINISH ELEVATION WO - WALKOUT LO - LOOKOUT

**GRADING LEGEND / ABBREVIATIONS** 

TC: 391.49 FL: 390.99

TW: 391.49 BW: 380.99

GB: GRADE BREAK LP: LOW POINT HP: HIGH POINT FC: FLUSH CURB MG: MATCH GRADE FL: FLOWLINE SW: SIDEWALK TC: TOP OF CURB FG: FINISH GRADE (DEFAULT- IF NOT LABELED)

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TREE - CONIFEROUS REMOVAL




**438 HOMESTEAD** 438 WASHINGTON STREET, WOODLAND, WA 98674

# SITE PLAN REVIEW


Project No: 21035.1 Issue Date: 6/21/2023

# Project Manager <u>DCK</u> Drawn by <u>CKJ/OK</u> Checked by <u>TWT</u> G003

LEGENDS

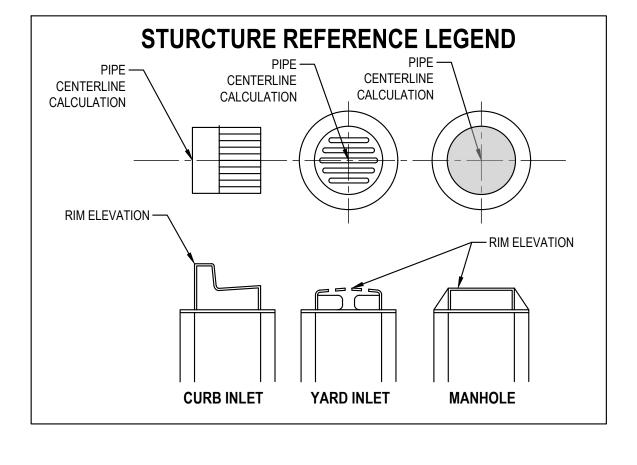


REVIEW PLAN SITE FOR ISSUED

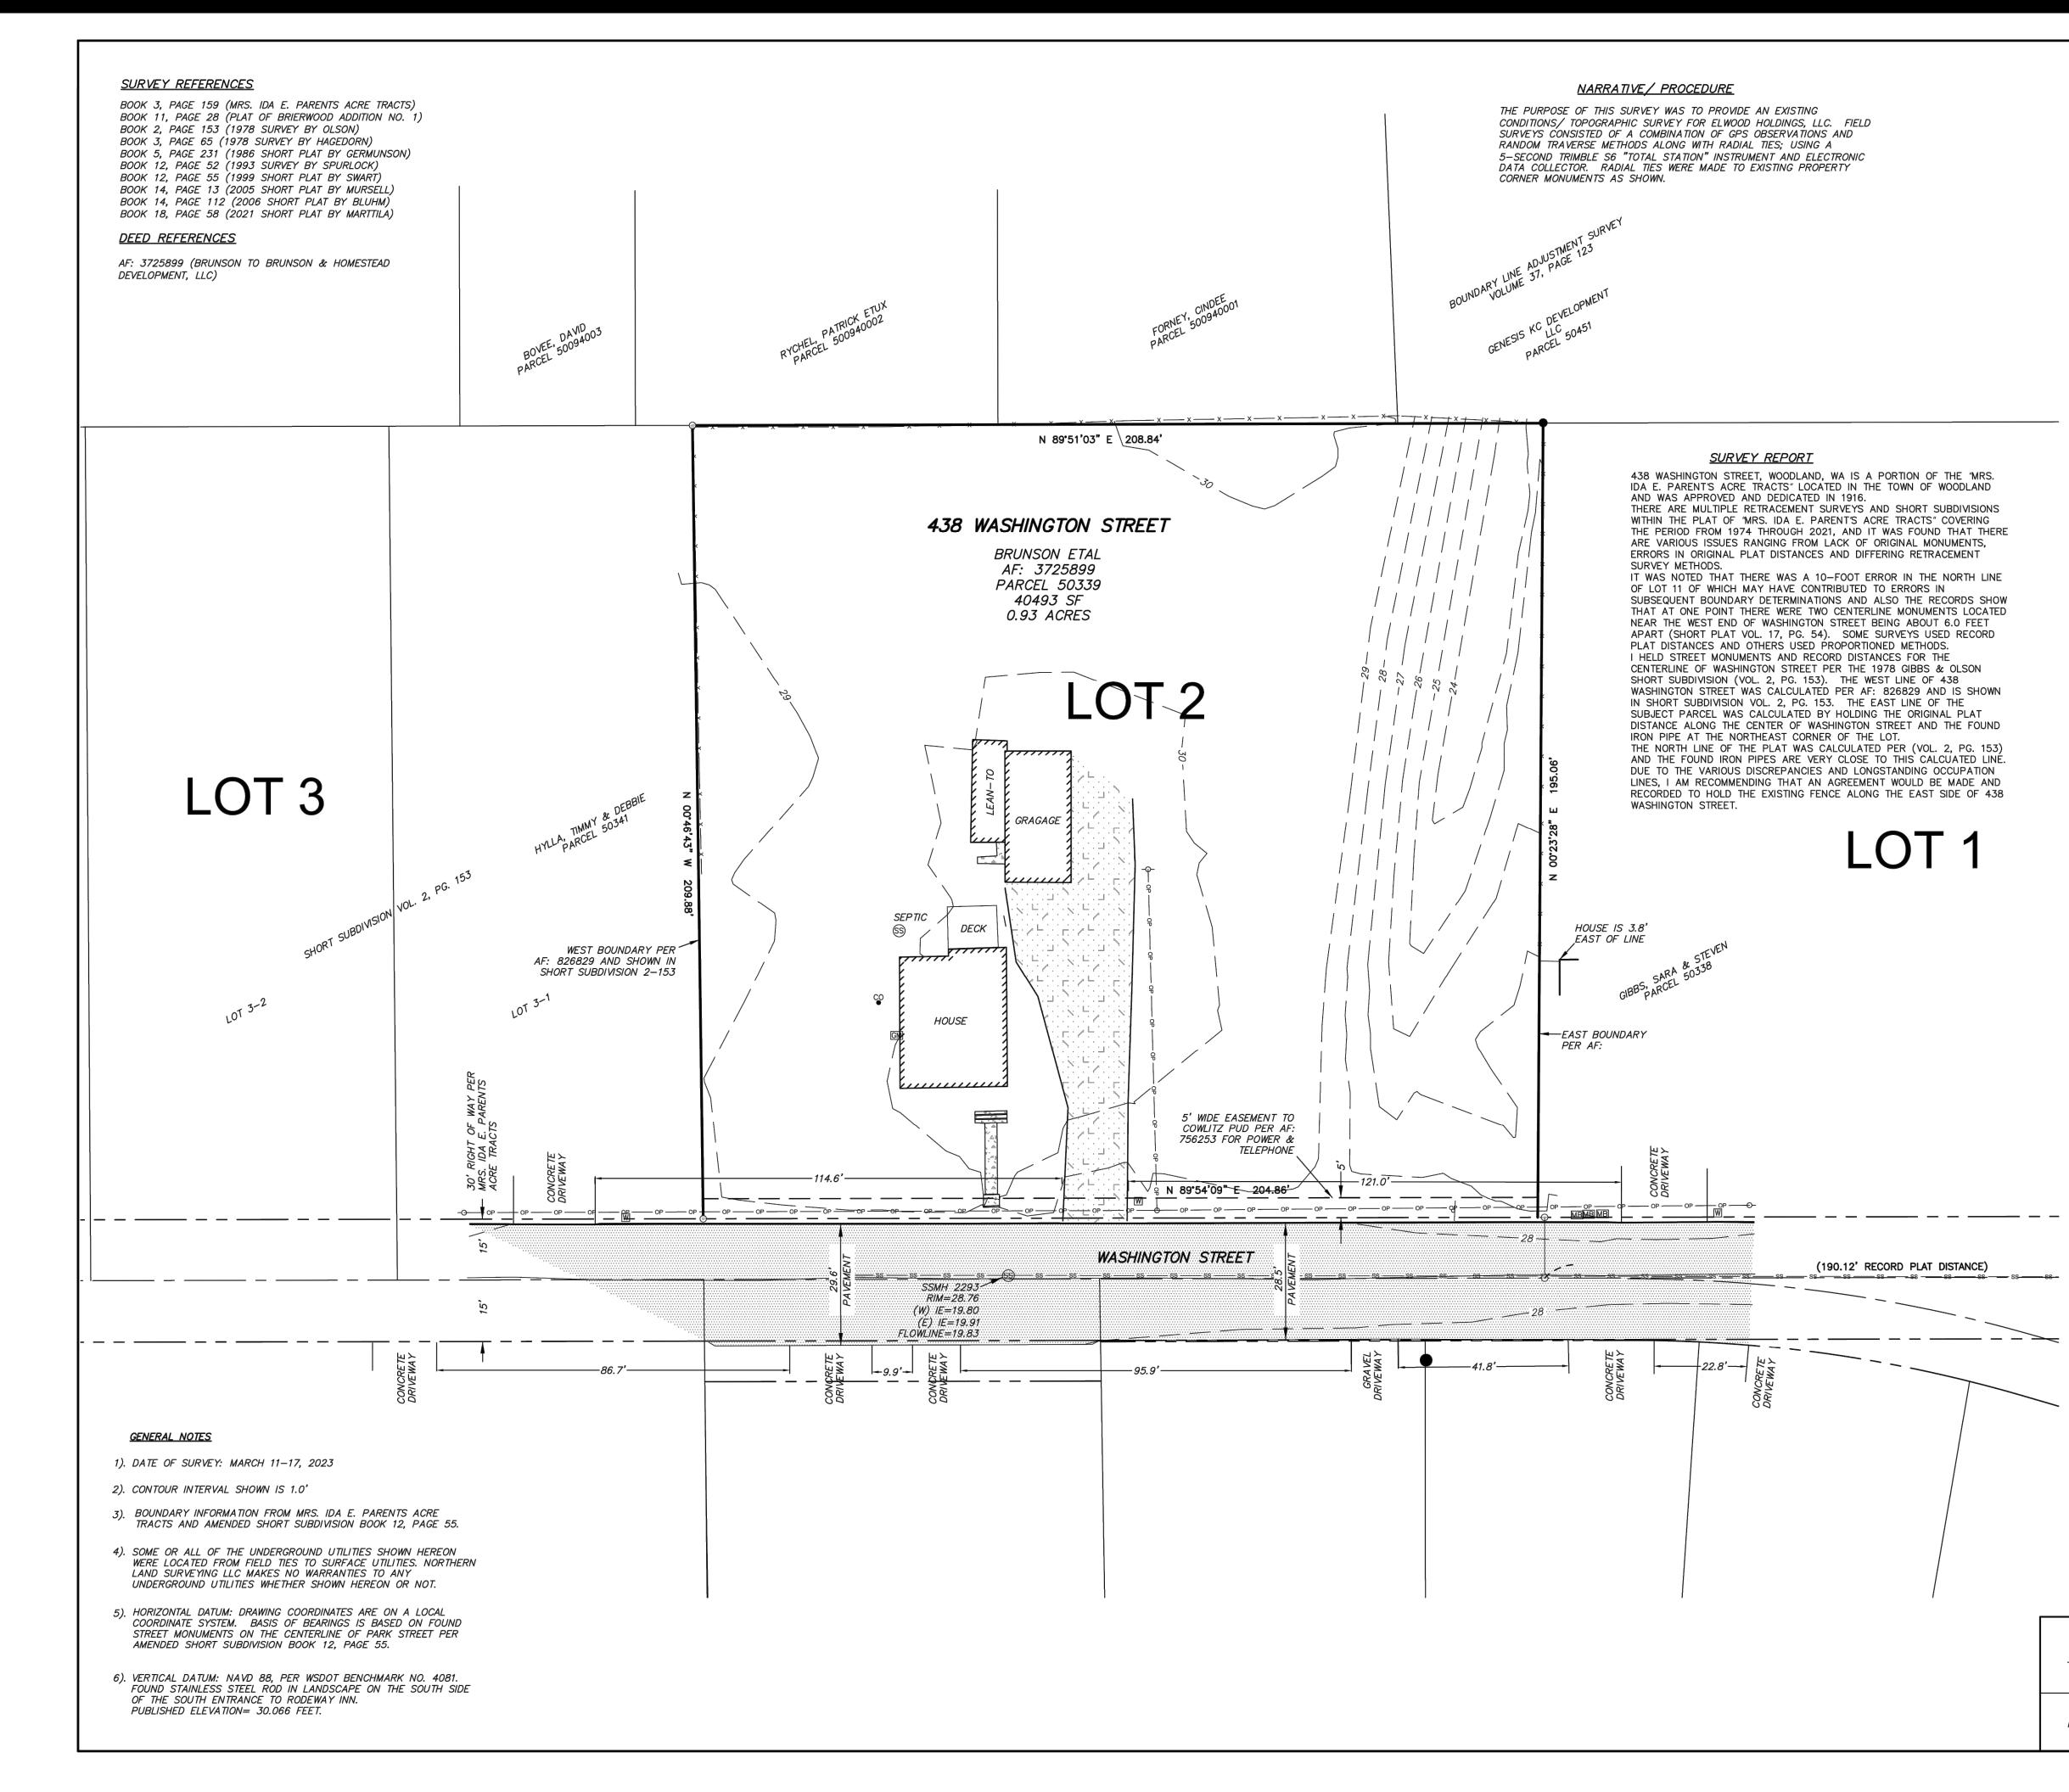

# EXISTING CONDITIONS SURVEY for ELWOOD HOLDINGS, LLC

A PORTION OF LOT 2 OF MRS. IDA E. PARENT'S ACRE TRACTS IN THE TOWN OF WOODLAND, WASHINGTON IN A PORTION OF THE S&M BOZARTH D.L.C. IN SECTION 24, T5N, R1W, W.M. COWLITZ COUNTY, WA

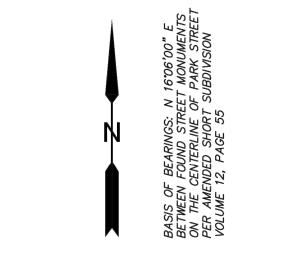



SCALE 1"=20'


# <u>LEGEND</u>

| ٠                | MONUMENT FOUND<br>(VISITED MARCH, 2023) |
|------------------|---|
| O                | INDICATES CALCULATED POSITION           |
| R.O.S.           | RECORD OF SURVEY (WITH BOOK AND PAGE)   |
| AF:              | AUDITOR'S FILE NUMBER                   |
| ()               | RECORD DATA                             |
| x x              | FENCING AS NOTED                        |
| ço               | CLEAN OUT (SANITARY)                    |
| 65)              | SANITARY MANHOLE                        |
| ss               | SANITARY SEWER LINE                     |
| -0-              | POWER POLE                              |
| OP               | OVERHEAD POWER                          |
| W                | WATER METER                             |
| MB               | MAILBOX                                 |
| GM               | GAS METER                               |
| - <del>o</del> - | SIGN                                    |
|                  |   |
|                  | CONCRETE AREA                           |

GRAVEL AREA

ASPHALT AREA

7 1 × 12 

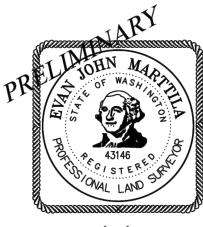

07/28/2023




P.O. Box 2017 Battle Ground, WA 98604 360.553.5992

Drawn By: D Checked By:

|     |                  |              | _ |
|-----|------------------|--------------|---|
|     | Date: 07/28/2023 | Job No. 2591 |   |
| EJM | Scale: 1"=20'    | Sheet: 1 OF  | 1 |

EXISTING CONDITIONS SURVEY

for ELWOOD HOLDINGS, LLC

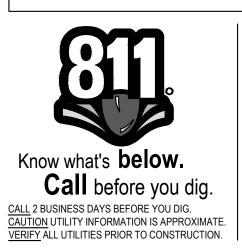


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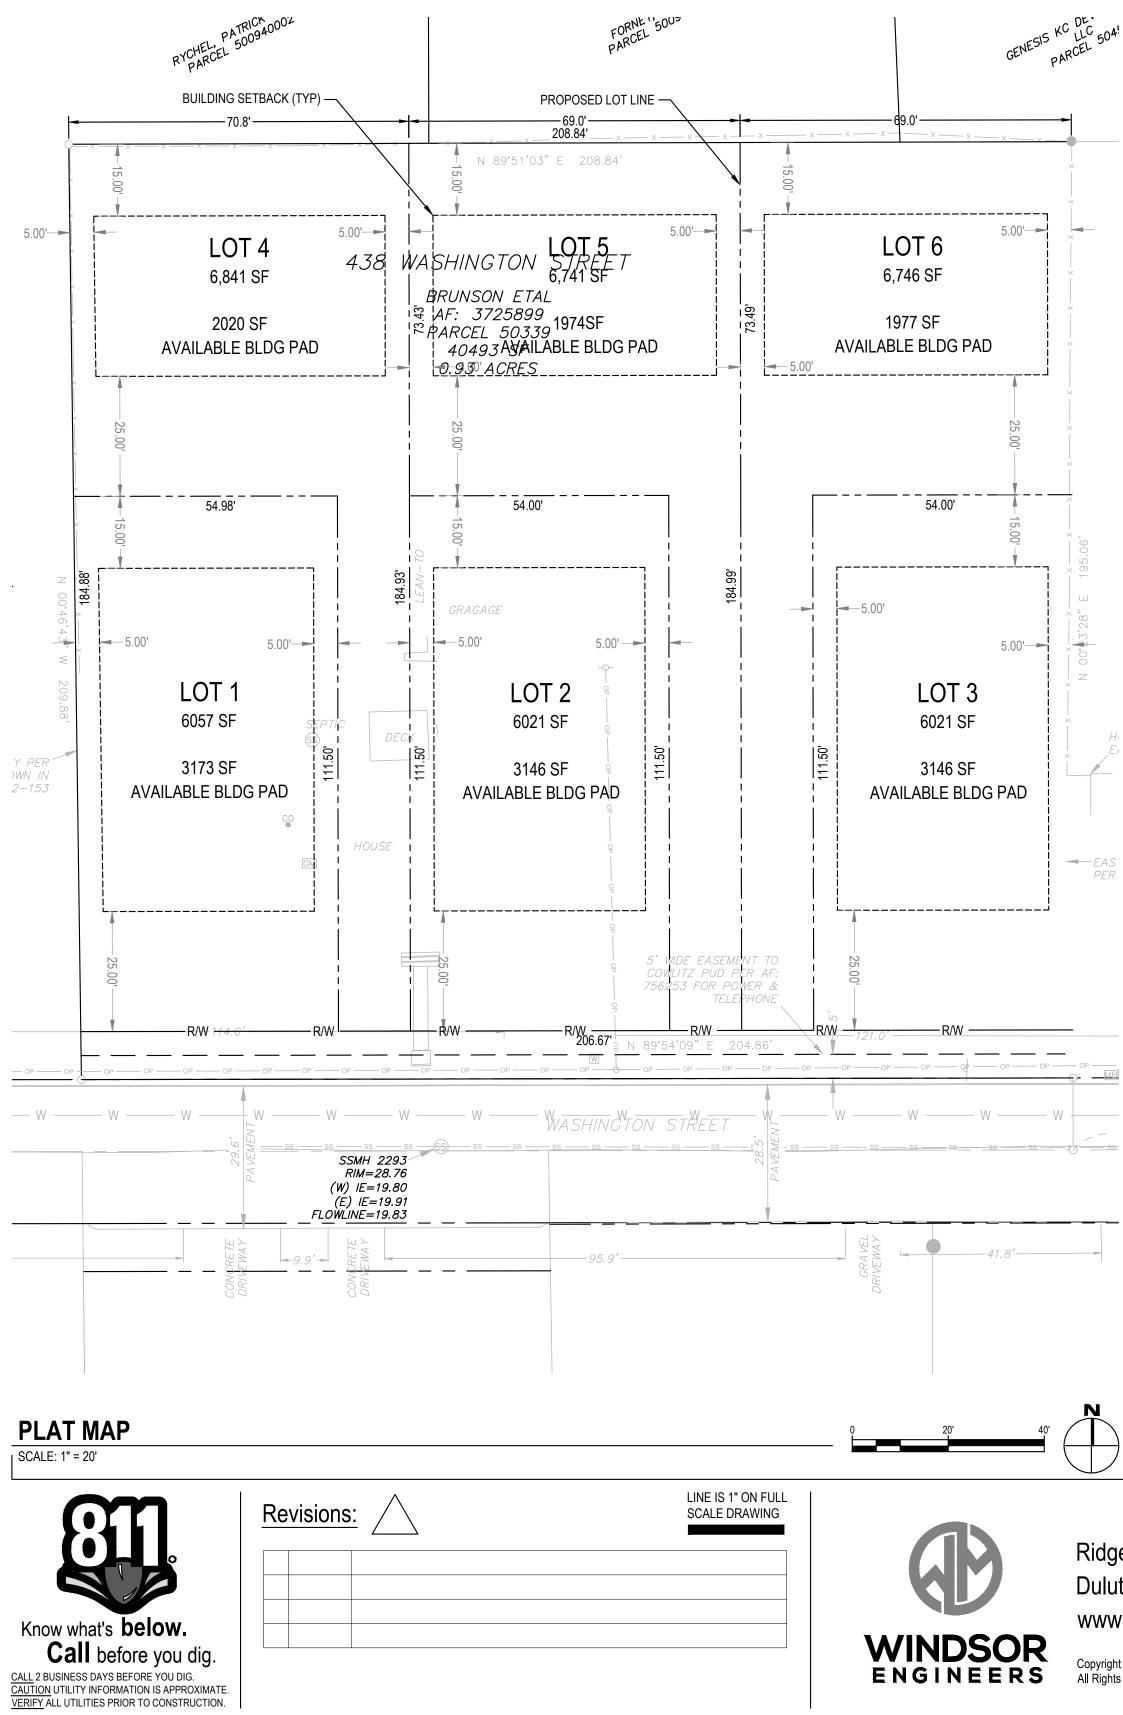
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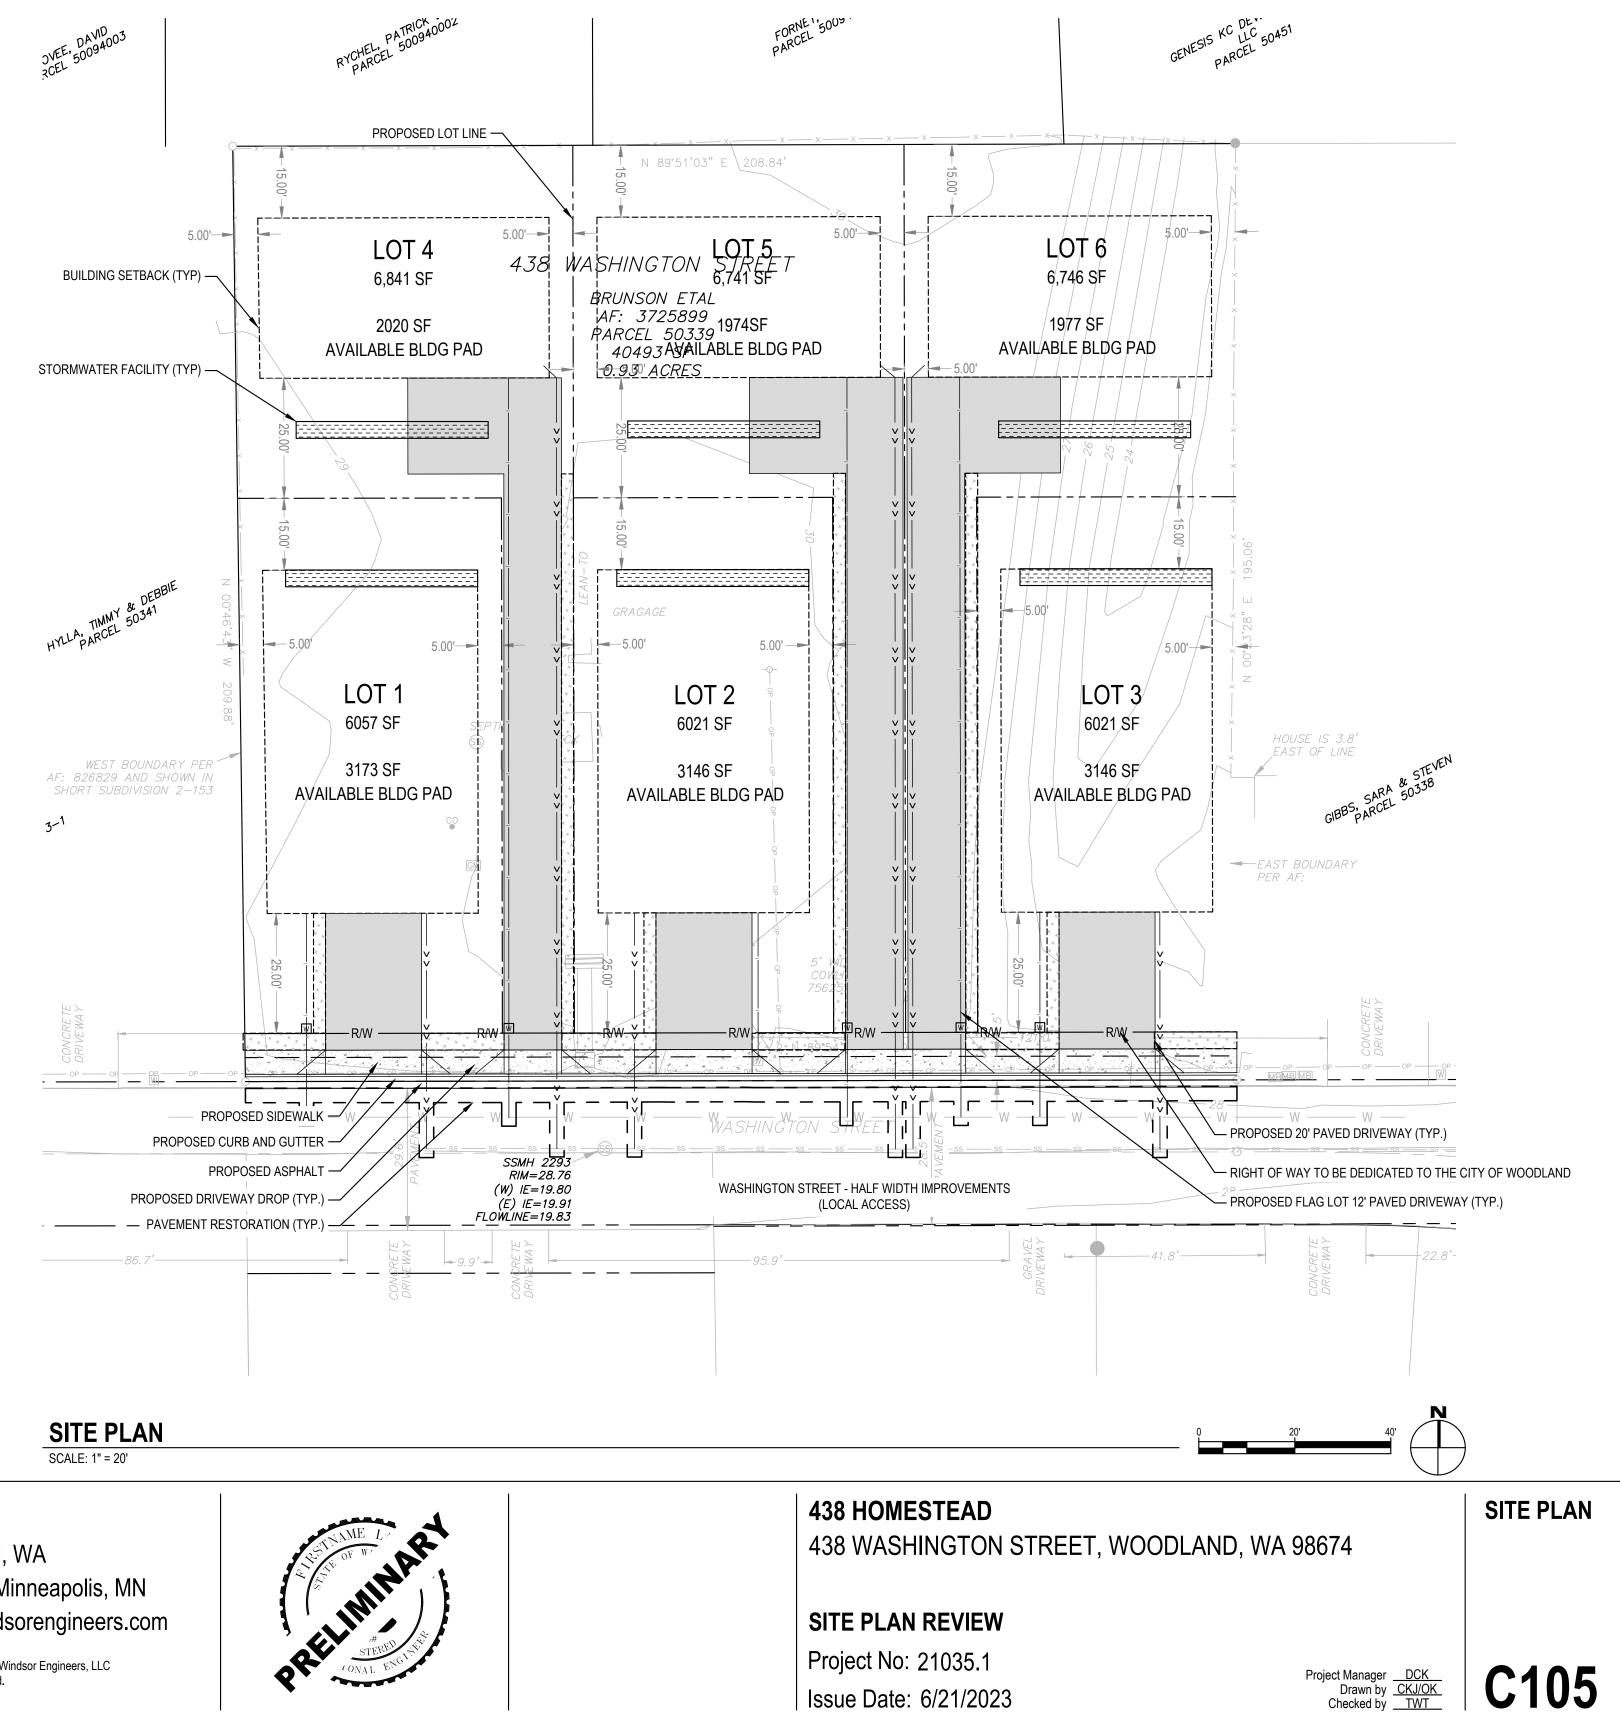
Issue Date: 6/21/2023

# GENERAL SHEET NOTES:

- 1. SEE SHEET G002 FOR PROJECT NOTES.
- 2. CONTRACTOR TO VERIFY ALL UTILITY LOCATIONS AND DEPTHS PRIOR TO CONSTRUCTION.
- 3. CONTRACTOR TO TAKE PRECAUTIONS TO PROTECT UNDERGROUND UTILITIES.
- 4. CONTRACTOR TO ONLY REMOVE EXISTING VEGETATION AS NECESSARY TO COMPLETE THE WORK.
- 5. NO CONSTRUCTION WORK SHALL BEGIN PRIOR TO A PRECONSTRUCTION MEETING CONFERENCE WITH A PUBLIC WORKS AND A BUILDING INSPECTIONS REPRESENTATIVE.
- 6. CONTRACTOR TO DISPOSE OF EXISTING TREES, SHRUBS, AND OTHER DEMOLITION DEBRIS IN AN ACCEPTABLE MANNER OF THE CONTRACTOR'S CHOOSING
- 7. CONTRACTOR TO COORDINATE TELECOM LINES, POWER LINES, AND ASSOCIATED INFRASTRUCTURE WITH APPROPRIATE UTILITY COMPANY
- 8. CURRENT USE IS AS A SINGLE FAMILY HOME, GARAGE AND STORAGE.

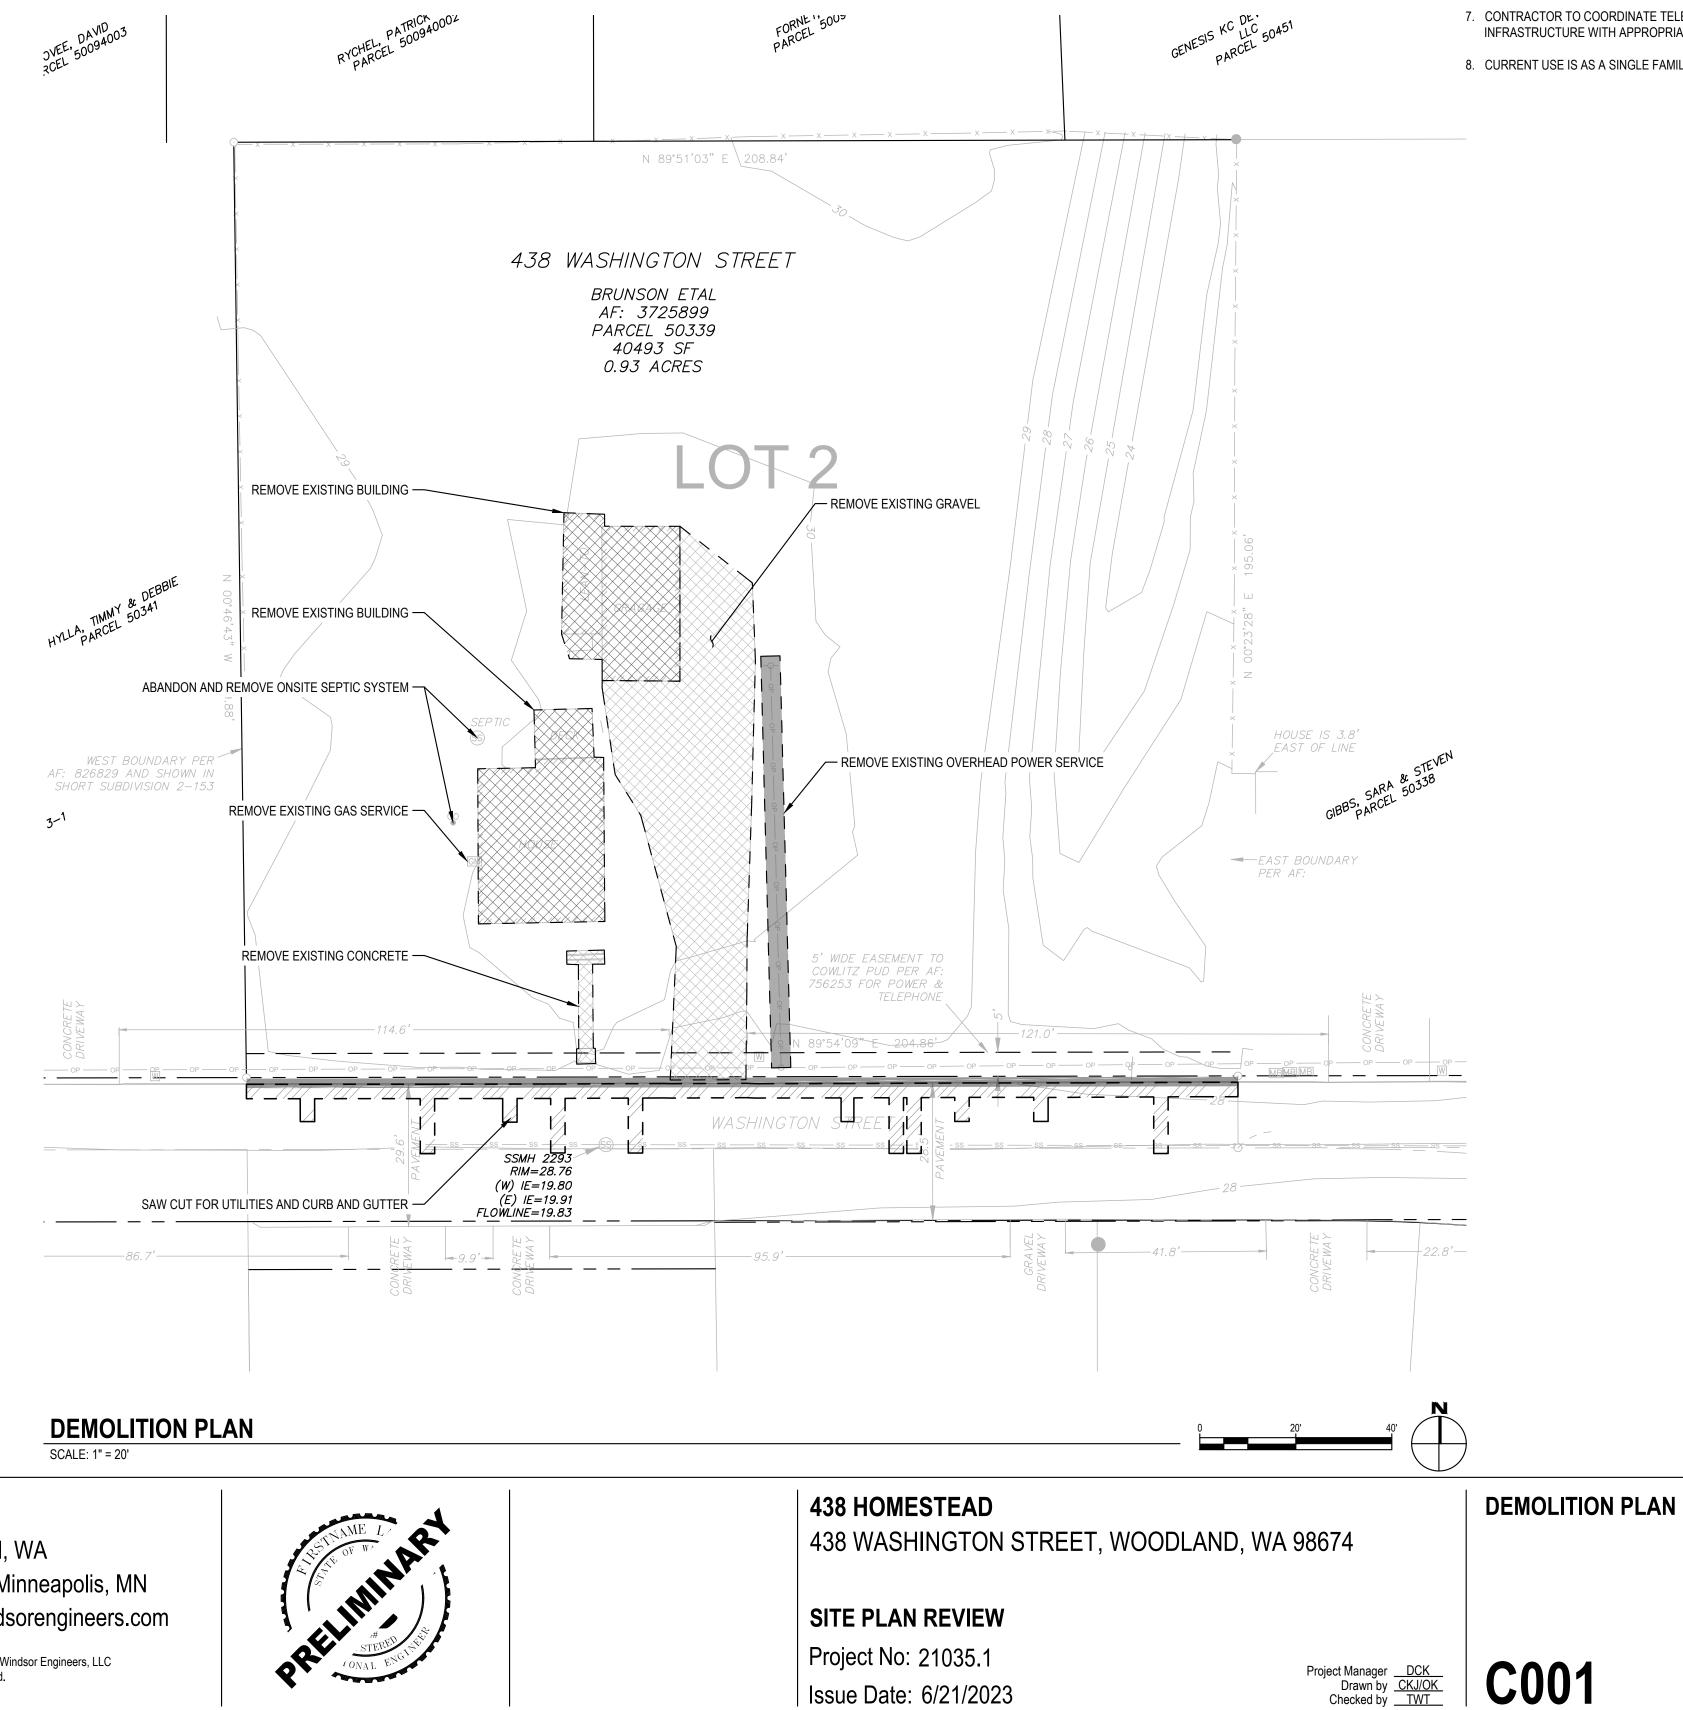

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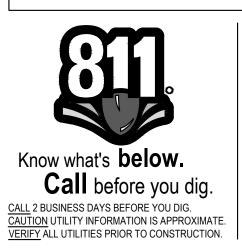


Issue Date: 6/21/2023

# NOTES:

- 1. SEE SHEETS G002 AND G003, CIVIL NOTES, LEGENDS AND ABBREVIATIONS.
- 2. SIDEWALK PER CITY OF WOODLAND DETAIL T-07.
- 3. CURB AND GUTTER PER CITY OF WOODLAND DETAIL T-01.
- 4. STREET FRONTAGE IMPROVEMENTS PER CITY OF WOODLAND DETAIL T-27.
- 5. DRIVEWAY APPROACH PER CITY OF WOODLAND DETAIL T-05.
- 6. STREET SECTION PER CITY OF WOODLAND DETAIL T-27.
- 7. MAXIMUM LOT COVERAGE: 50%
- 8. INTERIOR LOT SET BACKS:
  - REAR 15 FEET SIDE - 5 FEET
  - FRONT 25 FEET






| Revisions: | $\square$ |
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# COMPOSITE UTILITY PLAN

SCALE: 1" = 20'

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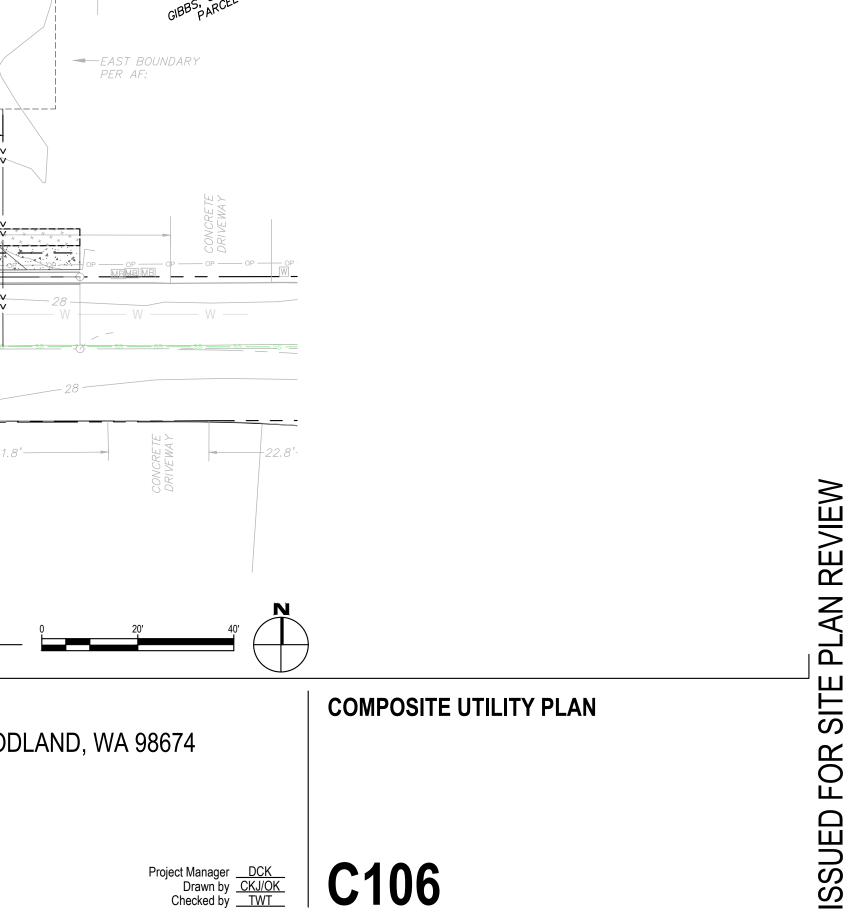
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438 HOMESTEAD 438 WASHINGTON STREET, WOODLAND, WA 98674

# SITE PLAN REVIEW Project No: 21035.1

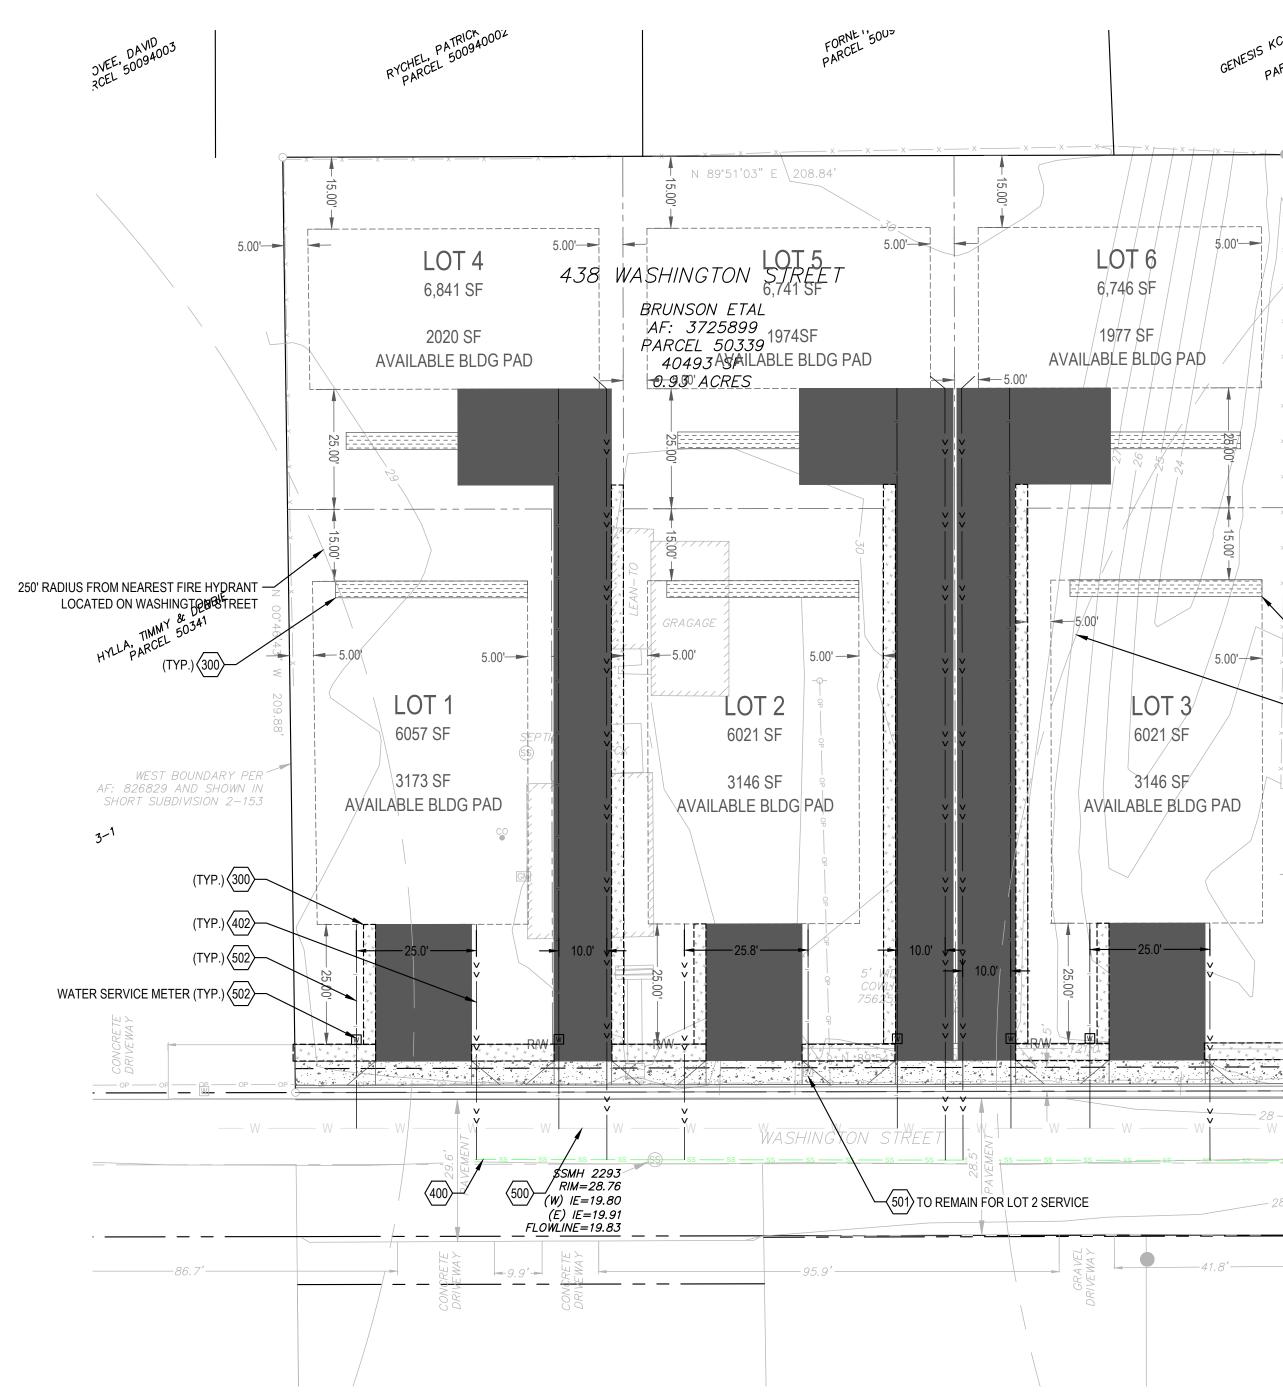Issue Date: 6/21/2023



300 (TYP.)

– 250' RADIUS FROM NEAREST FIRE HYDRANT

HCSTREET AND PARK STREET

LOCATED AT INTERSECTION OF WASHINGTON

- 402 SANITARY SEWER SERVICE (PROPOSED) 4"

# **WATER 500**

- 500 WATERMAIN PIPE (EXISTING MAIN LINE EXACT LOCATION UNKNOWN) 6"

GENESIS KC DE. PARCEL 50451

5.00'----

/ 5.00'-/---

\_\_\_\_\_

# GENERAL UTILITY SHEET NOTES:

- 1. MARK CURB AND GUTTER WITH A "W" OR "S" TO SHOW LOCATION OF UTILITY SERVICE LINE CROSSINGS.
- 2. SEE DETAIL SHEETS FOR CONSTRUCTION DETAILS
- 3. STORMWATER DETAILS SHEET C603. SANITARY SEWER DETAILS - SHEET C604 WATER DETAILS - SHEET C604.
- 4. SEE SHEET G002 AND G003, CIVIL NOTES, LEGENDS AND ABBREVIATIONS.
- 5. MAINTAIN 18" MIN. VERTICAL SEPARATION AND 10' MIN. HORIZONTAL SEPARATION BETWEEN WATER UTILITY AND SANITARY SEWER (TYP.)
- 6. SERVICE LATERAL CONSTRUCTION: SERVICE LATERAL CONNECTIONS AND PIPING WITHIN PUBLIC SANITARY SEWER EASEMENTS SHALL BE CONSTRUCTED TO PUBLIC STANDARDS. CONSTRUCTION SERVICES INSPECTIONS REQUIRED.
- 7. CONTRACTOR TO VERIFY LOCATIONS OF EXISTING UTILITIES USING POT HOLING OR OTHER EQUIVALENT METHODS.
- 8. ALL SEWER LATERALS ARE PRIVATE BETWEEN THE PROPERTY LINE AND BUILDING

# KEYNOTES:


# STORM 300

300 STORM WATER FACILITY - SEE SHEET C390

# SANITARY 400

- 400 SANITARY SEWER PIPE (EXISTING MAIN LINE) 8"
- 401 SANITARY SEWER MANHOLE (EXISTING MH)

- 501 WATER METER (EXISTING)
- 502 WATER SERVICE (PROPOSED) 1" WITH 3' MINIMUM DEPTH.

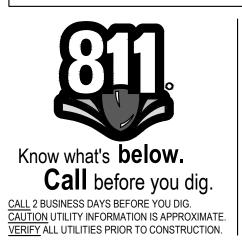


| <b>Revisions:</b> |   |
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Issue Date: 6/21/2023

# NOTES:

- 1. SEE SHEETS G002 AND G003, CIVIL NOTES, LEGENDS AND ABBREVIATIONS.
- 2. SEE SHEET C601, WOODLAND GENERAL EROSION NOTES DETAIL E-03
- 3. BMP C105 CONSTRUCTION ENTRANCE PER CITY OF WOODLAND DETAIL E-05
- 3.1. LENGTH MODIFIED FROM STANDARD DETAIL DUE TO SITE SIZE. LENGTH MODIFIED TO 50 FT.
- 3.2. A WHEEL WASH PER CITY OF WOODLAND DETAIL E-06 OR STREET SWEEPING PER STANDARD SET BY THE CITY OF WOODLAND MAY BE REQUIRED IF TRACKING OCCURS DUE TO MODIFIED CONSTRUCTION ENTRANCE.
- 4. BMP C 233 SILT FENCE PER CITY OF WOODLAND DETAIL E-20
- 5. BMP C120/121 TEMPORARY/PERMANENT SEEDING AND MULCHING, FOLLOW WASHINGTON DEPARTMENT OF ECOLOGY STANDARDS
- 6. BMP C220 STORM DRAIN INLET PROTECTION PER CITY OF WOODLAND DETAIL E-16 & E-17

# SITE STABILIZATION

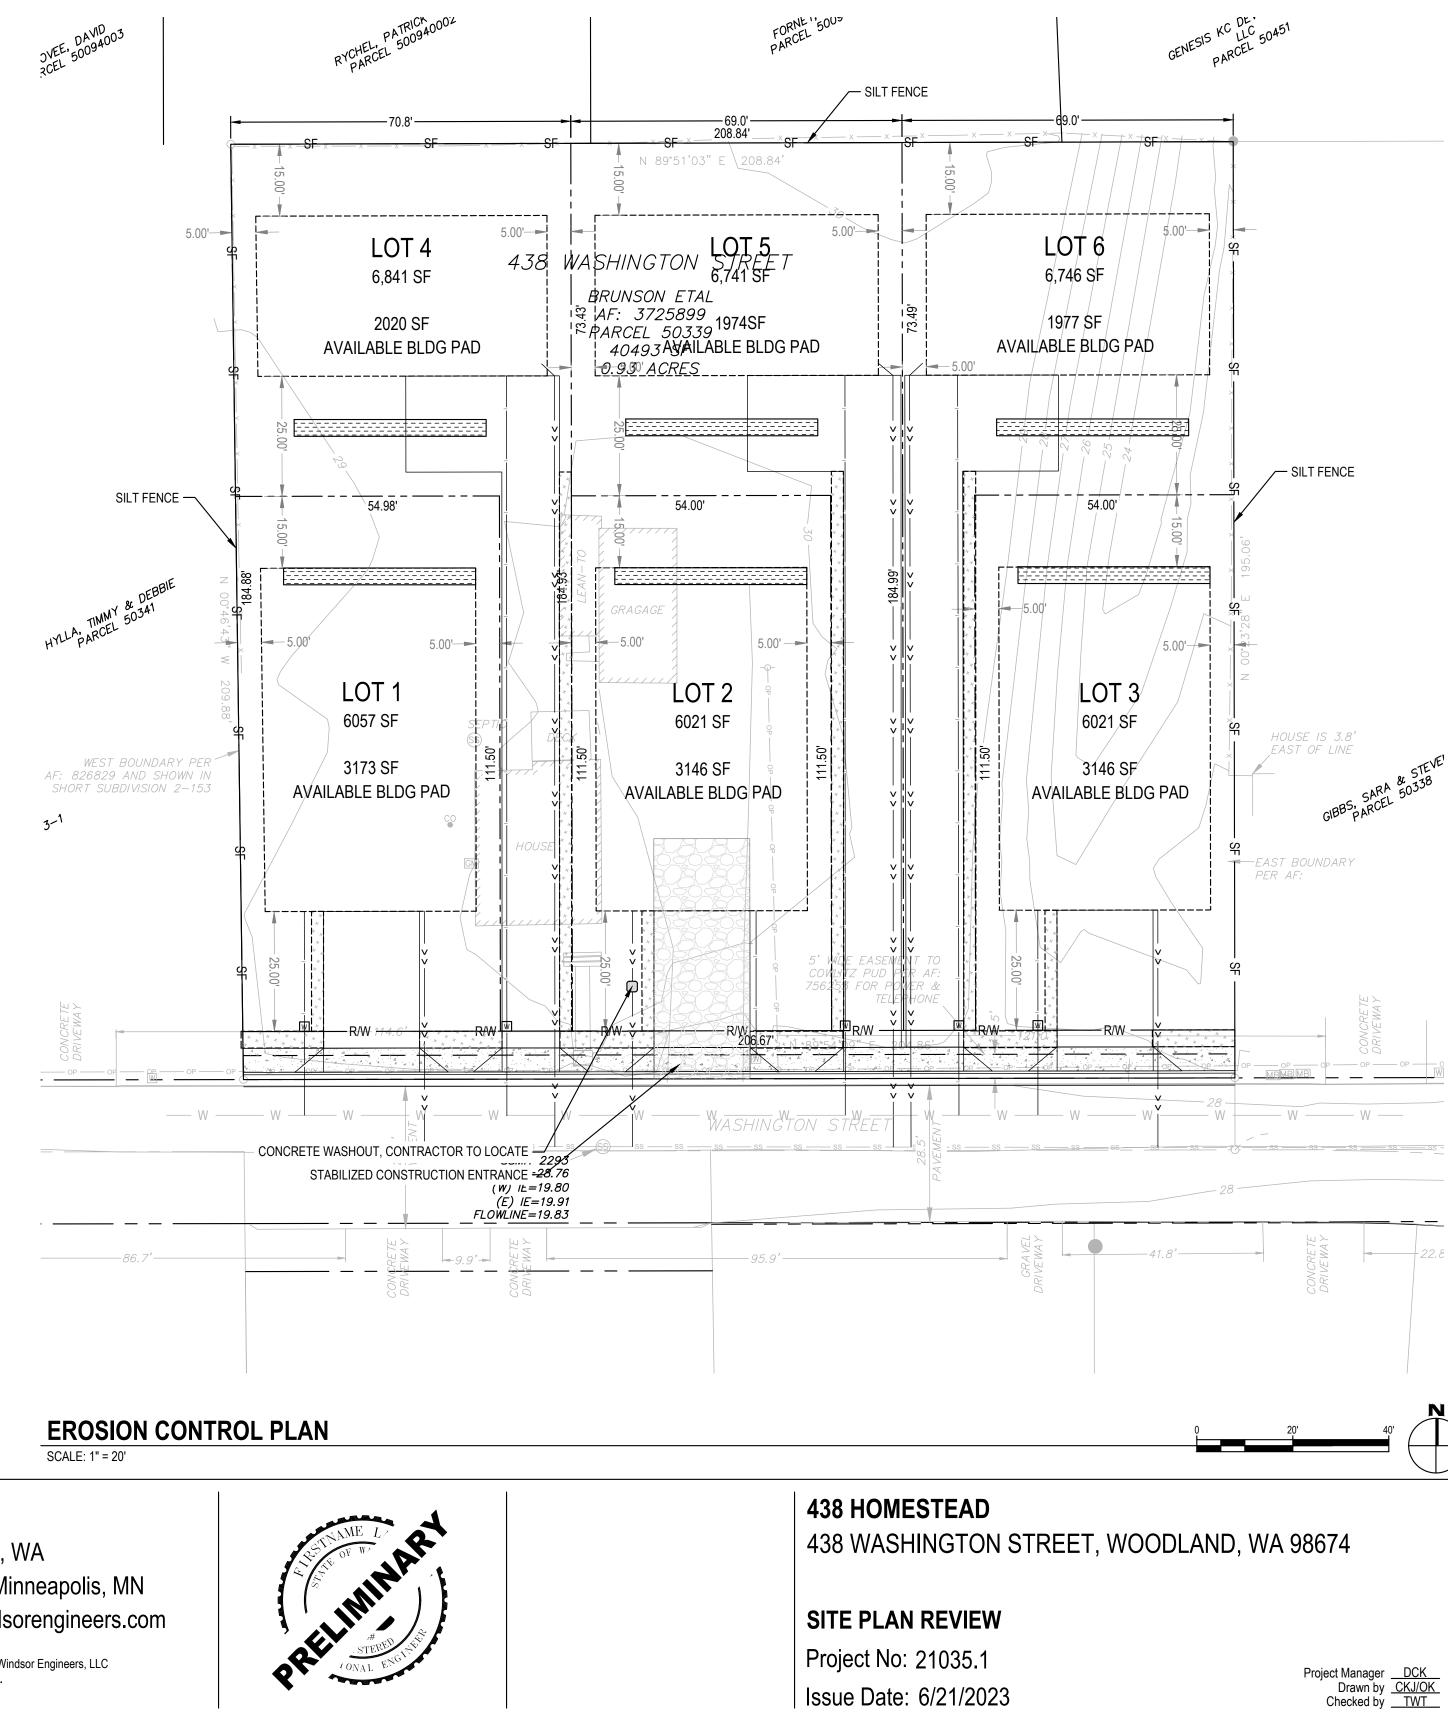THE PROJECT CESCL IS SOLELY RESPONSIBLE FOR SELECTION, INSTALLATION, AND MAINTENANCE OF THE CHOSEN BMPs.

SITE STABILIZATION TO OCCUR DURING AND AFTER CONSTRUCTION. TO PREVENT EROSION, EXPOSED AND UNWORKED SOILS SHALL NOT REMAIN UNWORKED AND EXPOSED FOR MORE THAN THE TIME PERIODS DESCRIBED IN THE TABLE BELOW. SOILS MUST BE STABILIZED AT THE END OF THE SHIFT BEFORE A HOLIDAY OR WEEKEND IF NEEDED BASED ON THE WEATHER FORECAST. THIS APPLIES TO ALL SOILS WITHIN THE SITE, REGARDLESS OF FINAL GRADE OR NOT. EXPOSED AND UNWORKED SOILS SHALL BE STABILIZED THROUGHOUT THE LIFE OF THE PROJECT BY APPLICATION OF BMP C120/C121 SEEDING AND MULCHING. A TOTAL LIST OF POSSIBLE BPMS FOR STABILIZATION INCLUDE THE FOLLOWING BUT OTHER BMPs NOT INCLUDED ON THIS LIST MAY BE CHOSEN BY THE PROJECT CESCL AS APPROPRIATE.

- BMP C120: TEMP. AND PERMANENT SEEDING BMP C121: MULCHING BMP C122: NETS AND BLANKETS BMP C123: PLASTIC COVERING
- BMP C125: TOPSOILING BMP C130: SURFACE ROUGHENING

AFTER CONSTRUCTION IS COMPLETE, THE ENTIRE SITE SHALL BE PERMANENTLY STABILIZED. PERMANENT STABILIZATION CAN BE COMPLETED BY ANY COMBINATION OF THE ABOVE OR OTHER APPROPRIATE METHODS AS CHOSEN BY THE PROJECT CESCL.

# **EROSION CONTROL PLAN**

C110

**PLAN REVIEW ISSUED FOR SITE** 




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Revisions:



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SCALE: 1" = 20'

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# **438 HOMESTEAD** 438 WASHINGTON STREET, WOODLAND, WA 98674

# SITE PLAN REVIEW Project No: 21035.1

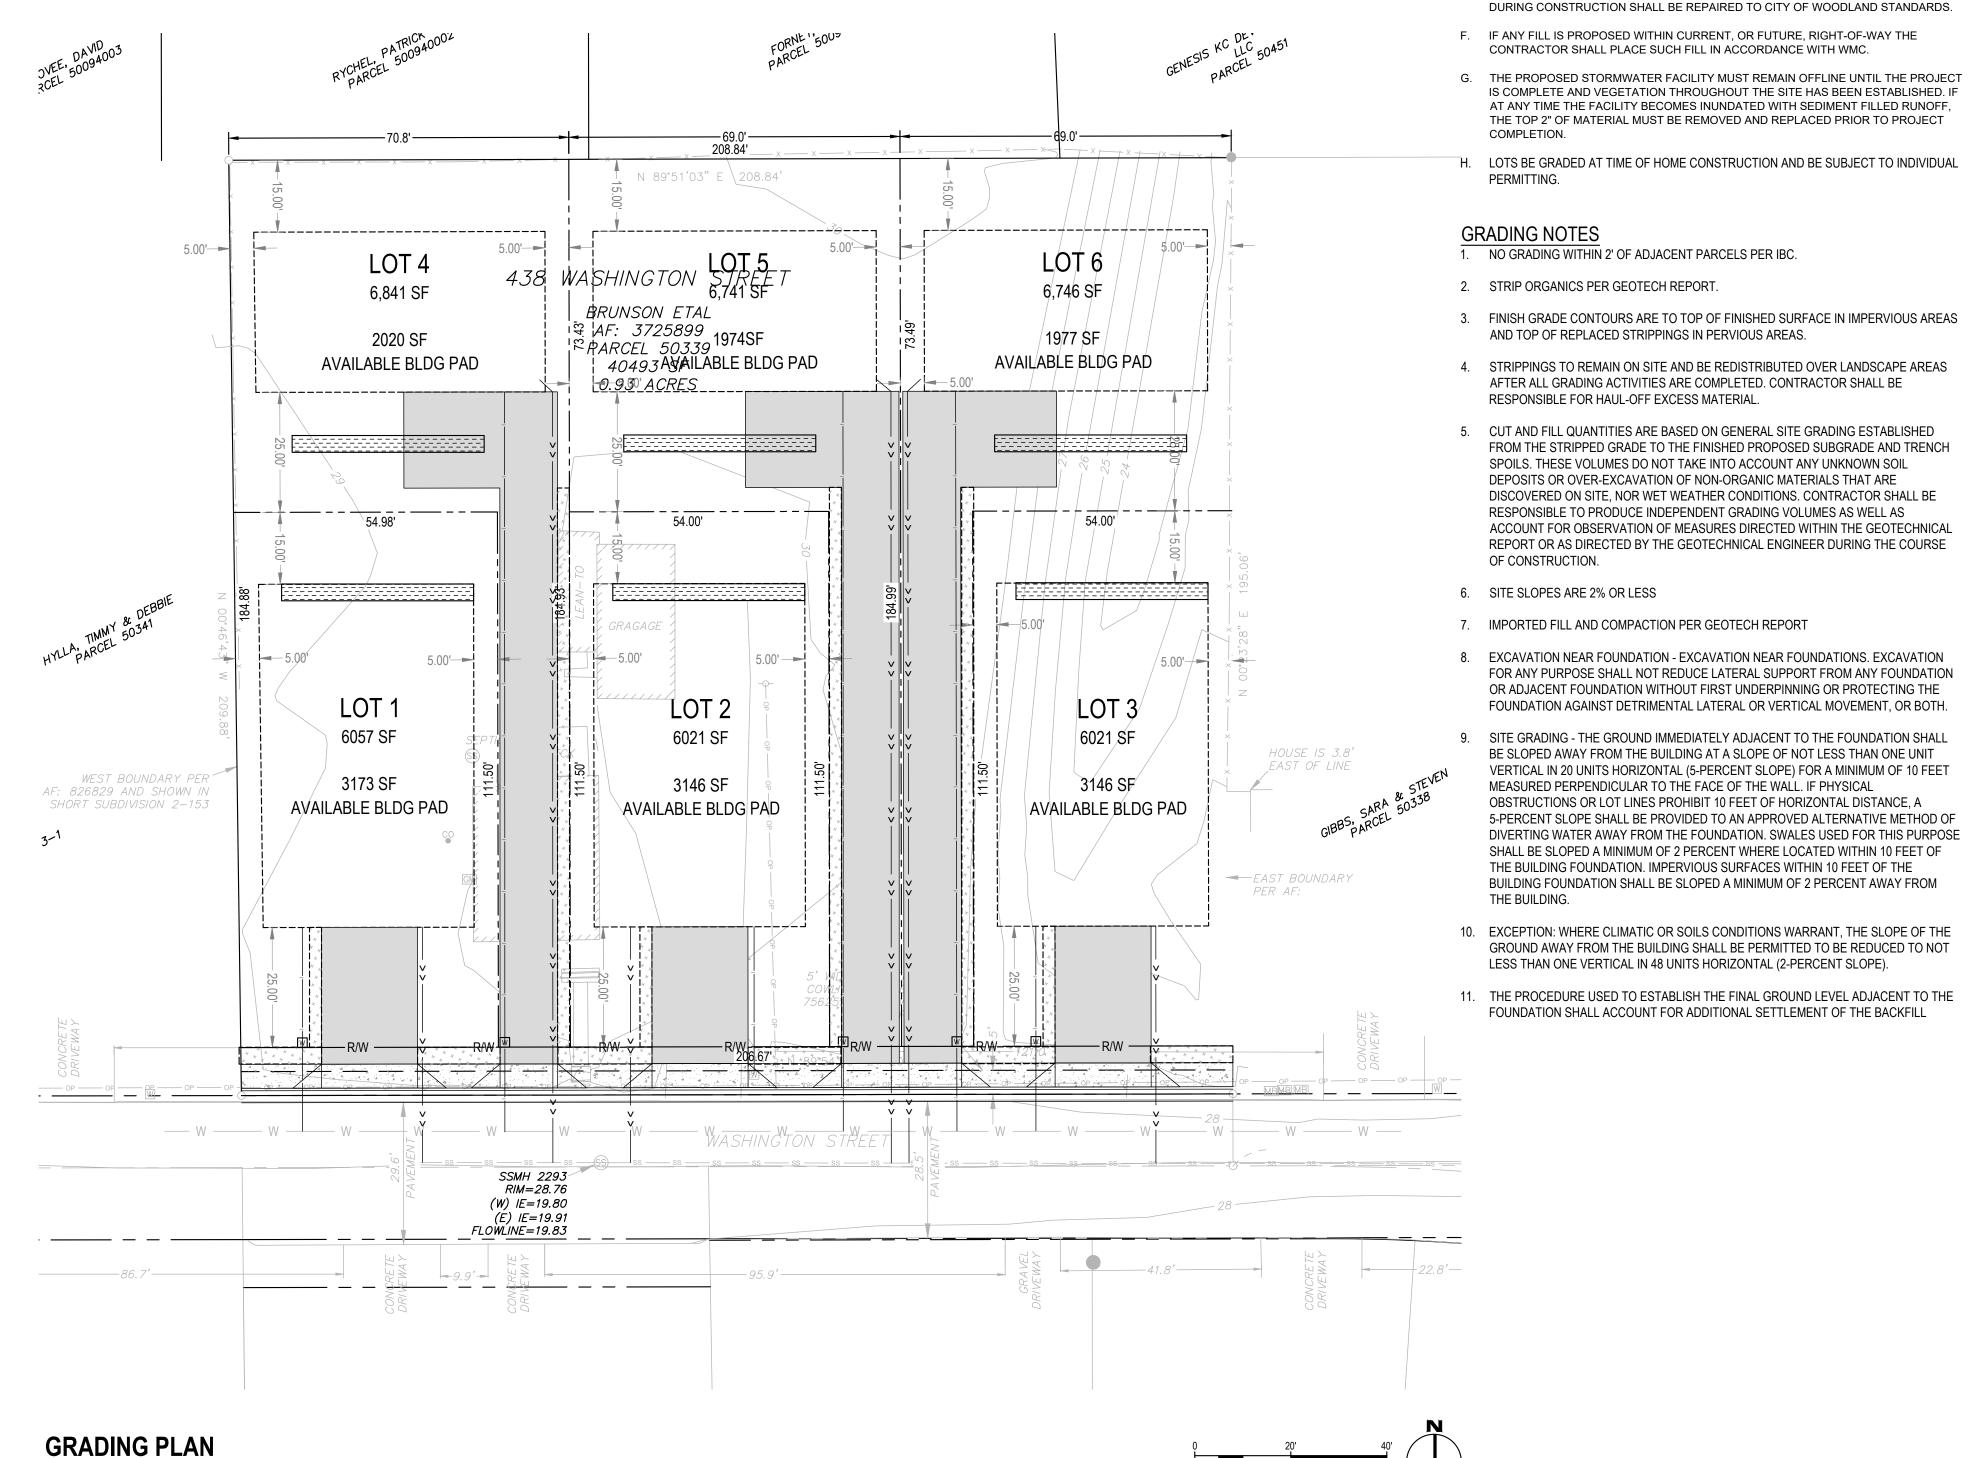Issue Date: 6/21/2023



# **GRADING PLAN**

**C130** 

Project Manager <u>DCK</u> Drawn by <u>CKJ/OK</u> Checked by <u>TWT</u>

THE BUILDING.

- 10. EXCEPTION: WHERE CLIMATIC OR SOILS CONDITIONS WARRANT, THE SLOPE OF THE GROUND AWAY FROM THE BUILDING SHALL BE PERMITTED TO BE REDUCED TO NOT LESS THAN ONE VERTICAL IN 48 UNITS HORIZONTAL (2-PERCENT SLOPE). 11. THE PROCEDURE USED TO ESTABLISH THE FINAL GROUND LEVEL ADJACENT TO THE FOUNDATION SHALL ACCOUNT FOR ADDITIONAL SETTLEMENT OF THE BACKFILL

**PLAN REVIEW** 

**ISSUED FOR SITE** 

BE SLOPED AWAY FROM THE BUILDING AT A SLOPE OF NOT LESS THAN ONE UNIT VERTICAL IN 20 UNITS HORIZONTAL (5-PERCENT SLOPE) FOR A MINIMUM OF 10 FEET MEASURED PERPENDICULAR TO THE FACE OF THE WALL. IF PHYSICAL

5-PERCENT SLOPE SHALL BE PROVIDED TO AN APPROVED ALTERNATIVE METHOD OF DIVERTING WATER AWAY FROM THE FOUNDATION. SWALES USED FOR THIS PURPOSE

SHALL BE SLOPED A MINIMUM OF 2 PERCENT WHERE LOCATED WITHIN 10 FEET OF THE BUILDING FOUNDATION. IMPERVIOUS SURFACES WITHIN 10 FEET OF THE

BUILDING FOUNDATION SHALL BE SLOPED A MINIMUM OF 2 PERCENT AWAY FROM

OBSTRUCTIONS OR LOT LINES PROHIBIT 10 FEET OF HORIZONTAL DISTANCE, A

- 8. EXCAVATION NEAR FOUNDATION EXCAVATION NEAR FOUNDATIONS. EXCAVATION FOR ANY PURPOSE SHALL NOT REDUCE LATERAL SUPPORT FROM ANY FOUNDATION OR ADJACENT FOUNDATION WITHOUT FIRST UNDERPINNING OR PROTECTING THE FOUNDATION AGAINST DETRIMENTAL LATERAL OR VERTICAL MOVEMENT, OR BOTH.
- 9. SITE GRADING THE GROUND IMMEDIATELY ADJACENT TO THE FOUNDATION SHALL
- DISCOVERED ON SITE, NOR WET WEATHER CONDITIONS. CONTRACTOR SHALL BE RESPONSIBLE TO PRODUCE INDEPENDENT GRADING VOLUMES AS WELL AS ACCOUNT FOR OBSERVATION OF MEASURES DIRECTED WITHIN THE GEOTECHNICAL REPORT OR AS DIRECTED BY THE GEOTECHNICAL ENGINEER DURING THE COURSE OF CONSTRUCTION. 6. SITE SLOPES ARE 2% OR LESS 7. IMPORTED FILL AND COMPACTION PER GEOTECH REPORT

FROM THE STRIPPED GRADE TO THE FINISHED PROPOSED SUBGRADE AND TRENCH SPOILS. THESE VOLUMES DO NOT TAKE INTO ACCOUNT ANY UNKNOWN SOIL DEPOSITS OR OVER-EXCAVATION OF NON-ORGANIC MATERIALS THAT ARE

3. FINISH GRADE CONTOURS ARE TO TOP OF FINISHED SURFACE IN IMPERVIOUS AREAS AND TOP OF REPLACED STRIPPINGS IN PERVIOUS AREAS. 4. STRIPPINGS TO REMAIN ON SITE AND BE REDISTRIBUTED OVER LANDSCAPE AREAS

AFTER ALL GRADING ACTIVITIES ARE COMPLETED. CONTRACTOR SHALL BE

H. LOTS BE GRADED AT TIME OF HOME CONSTRUCTION AND BE SUBJECT TO INDIVIDUAL PERMITTING.

- 2. STRIP ORGANICS PER GEOTECH REPORT.

- **GRADING NOTES** 1. NO GRADING WITHIN 2' OF ADJACENT PARCELS PER IBC.

RESPONSIBLE FOR HAUL-OFF EXCESS MATERIAL.

- IS COMPLETE AND VEGETATION THROUGHOUT THE SITE HAS BEEN ESTABLISHED. IF AT ANY TIME THE FACILITY BECOMES INUNDATED WITH SEDIMENT FILLED RUNOFF, THE TOP 2" OF MATERIAL MUST BE REMOVED AND REPLACED PRIOR TO PROJECT COMPLETION.

CONTRACTOR SHALL PLACE SUCH FILL IN ACCORDANCE WITH WMC.

E. ANY PUBLIC, OR PRIVATE, CURB, GUTTER, SIDEWALK, OR ASPHALT DAMAGED DURING CONSTRUCTION SHALL BE REPAIRED TO CITY OF WOODLAND STANDARDS. F. IF ANY FILL IS PROPOSED WITHIN CURRENT, OR FUTURE, RIGHT-OF-WAY THE

PRESERVATION AT (360) 753-4011 IMMEDIATELY. FAILURE TO DO SO COULD RESULT

# A. CITY OF WOODLAND CODE - WMC

CONSTRUCTION SOIL QUALITY AND DEPTH


GENERAL SHEET NOTES:

IN A FELONY CONVICTION.


B. "WASHINGTON STATE DEPARTMENT OF ECOLOGY STORMWATER MANAGEMENT MANUAL FOR WESTERN WASHINGTON" LATEST EDITION. AVAILABLE ON THE WASHINGTON DOE WEBSITE.

C. ALL SOILS SHALL BE AMENDED TO MEET THE STANDARD SET BY BMP T5.13 POST


D. SHOULD ANY ITEM OF ARCHAEOLOGICAL INTEREST (VMC 20.710.090) BE FOUND DURING DEVELOPMENT, YOU ARE REQUIRED TO STOP WORK AND NOTIFY THE PLANNING CASE MANAGER IN DEVELOPMENT REVIEW SERVICES AT (360) 487-7800, AND THE WASHINGTON STATE OFFICE OF ARCHAEOLOGY AND HISTORIC

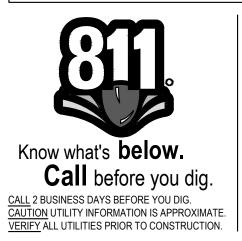

| - | Re | visions | <u>.</u> | $\bigtriangleup$ |  |
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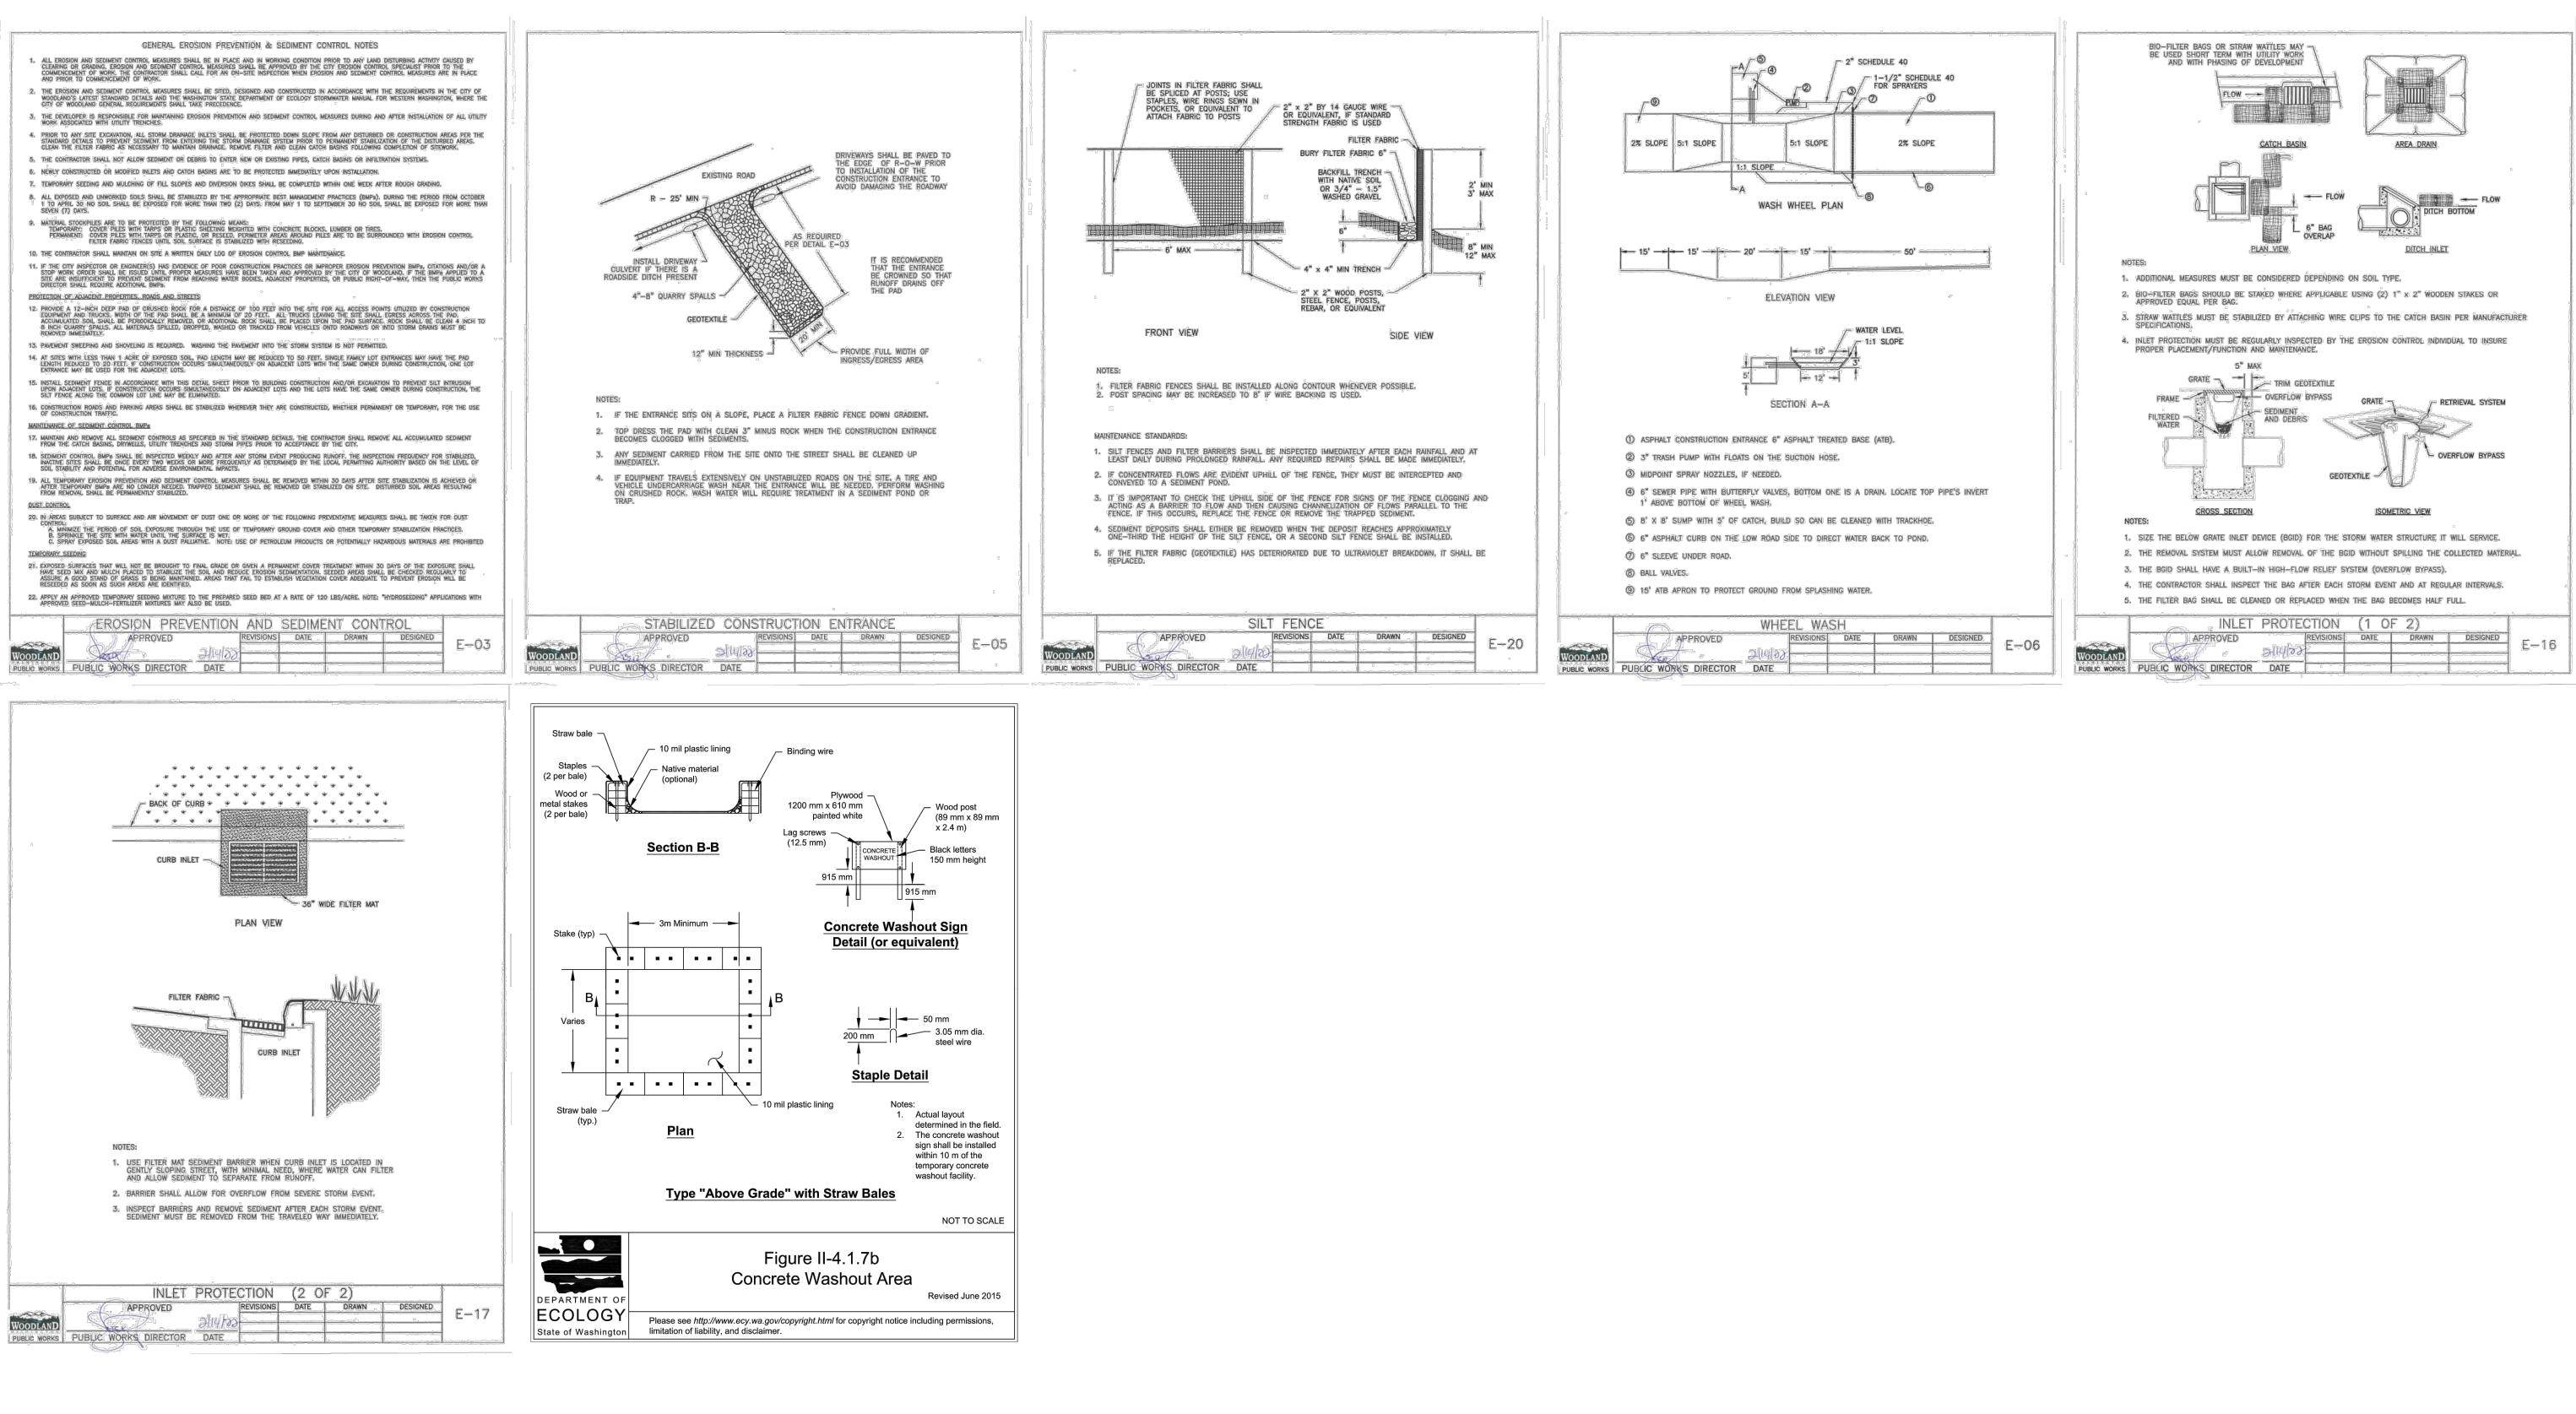


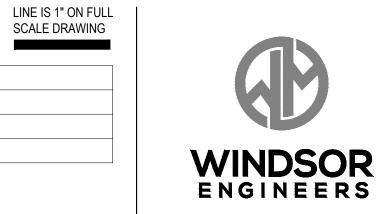
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# STORMWATER KEYNOTES:

- A. STORMWATER FACILITIES THAT ARE PRIVATELY OWNED AND SHALL BE MAINTAINED BY THE LANDOWNER
- B. ALL INFILTRATION SHALL BE AT LEAST 10 FEET FROM ANY STRUCTURE, PROPERTY LINE, OR SENSITIVE AREA (EXCEPT SLOPES OVER 40%)

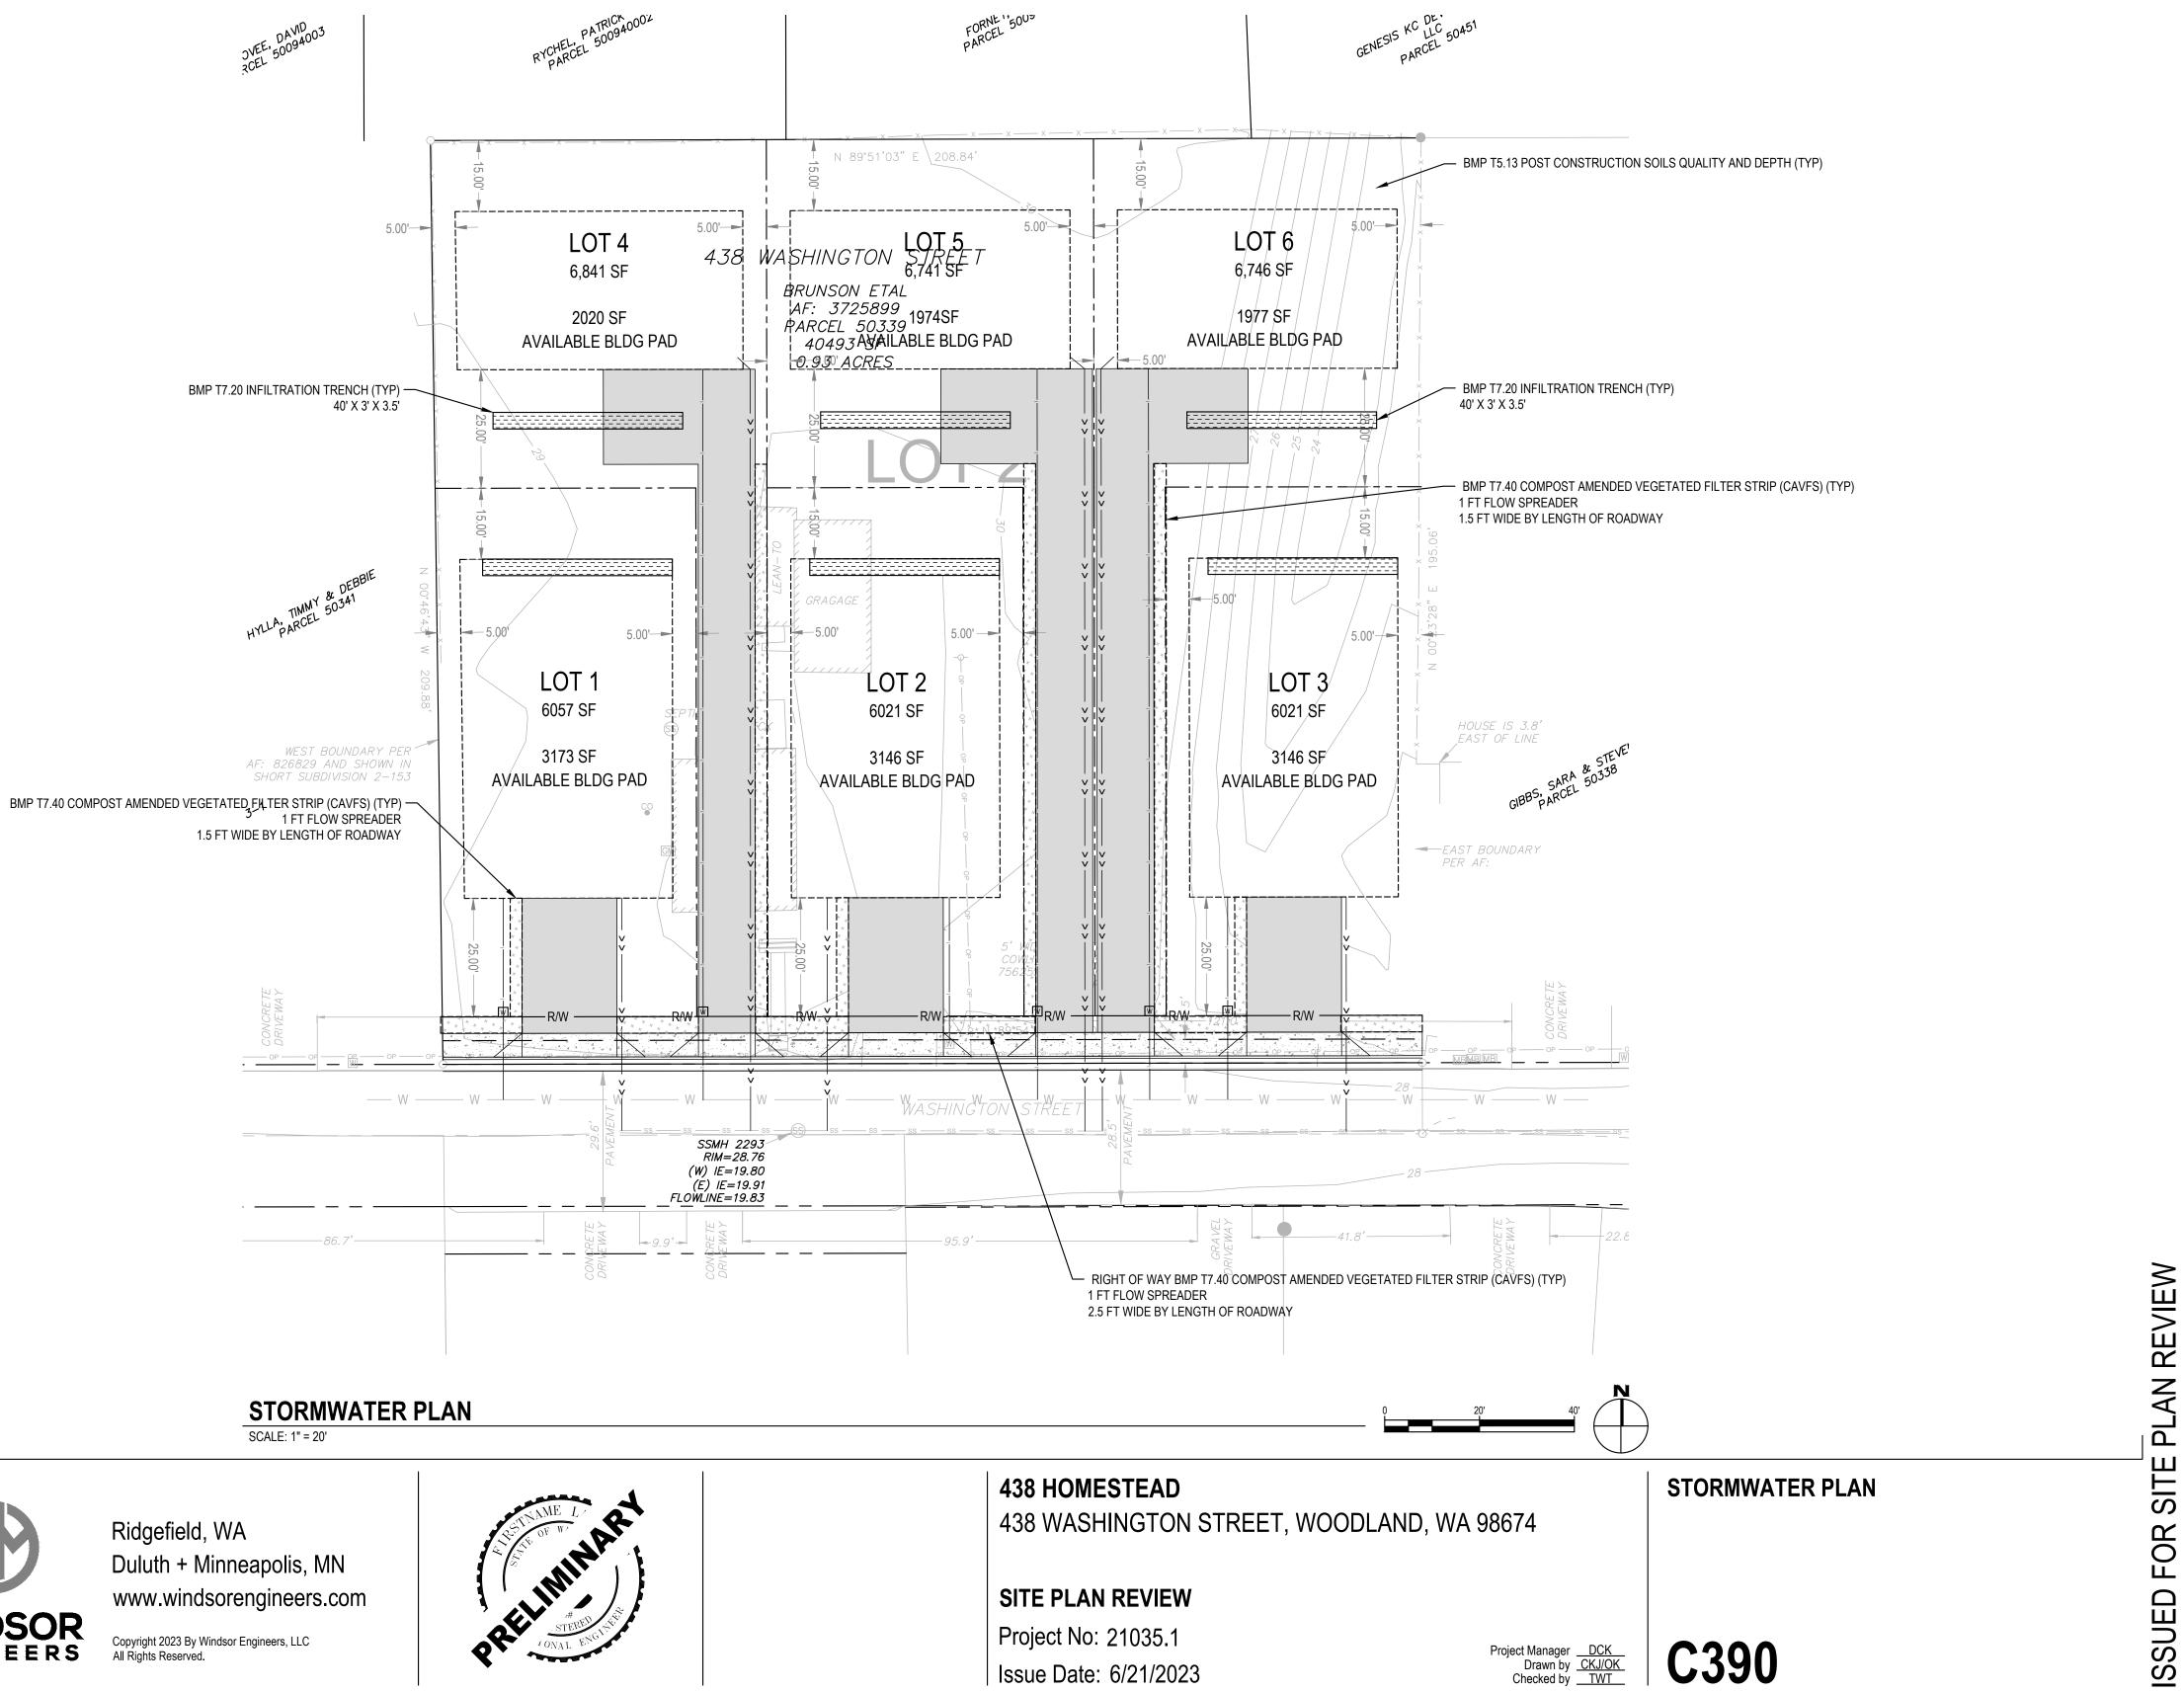



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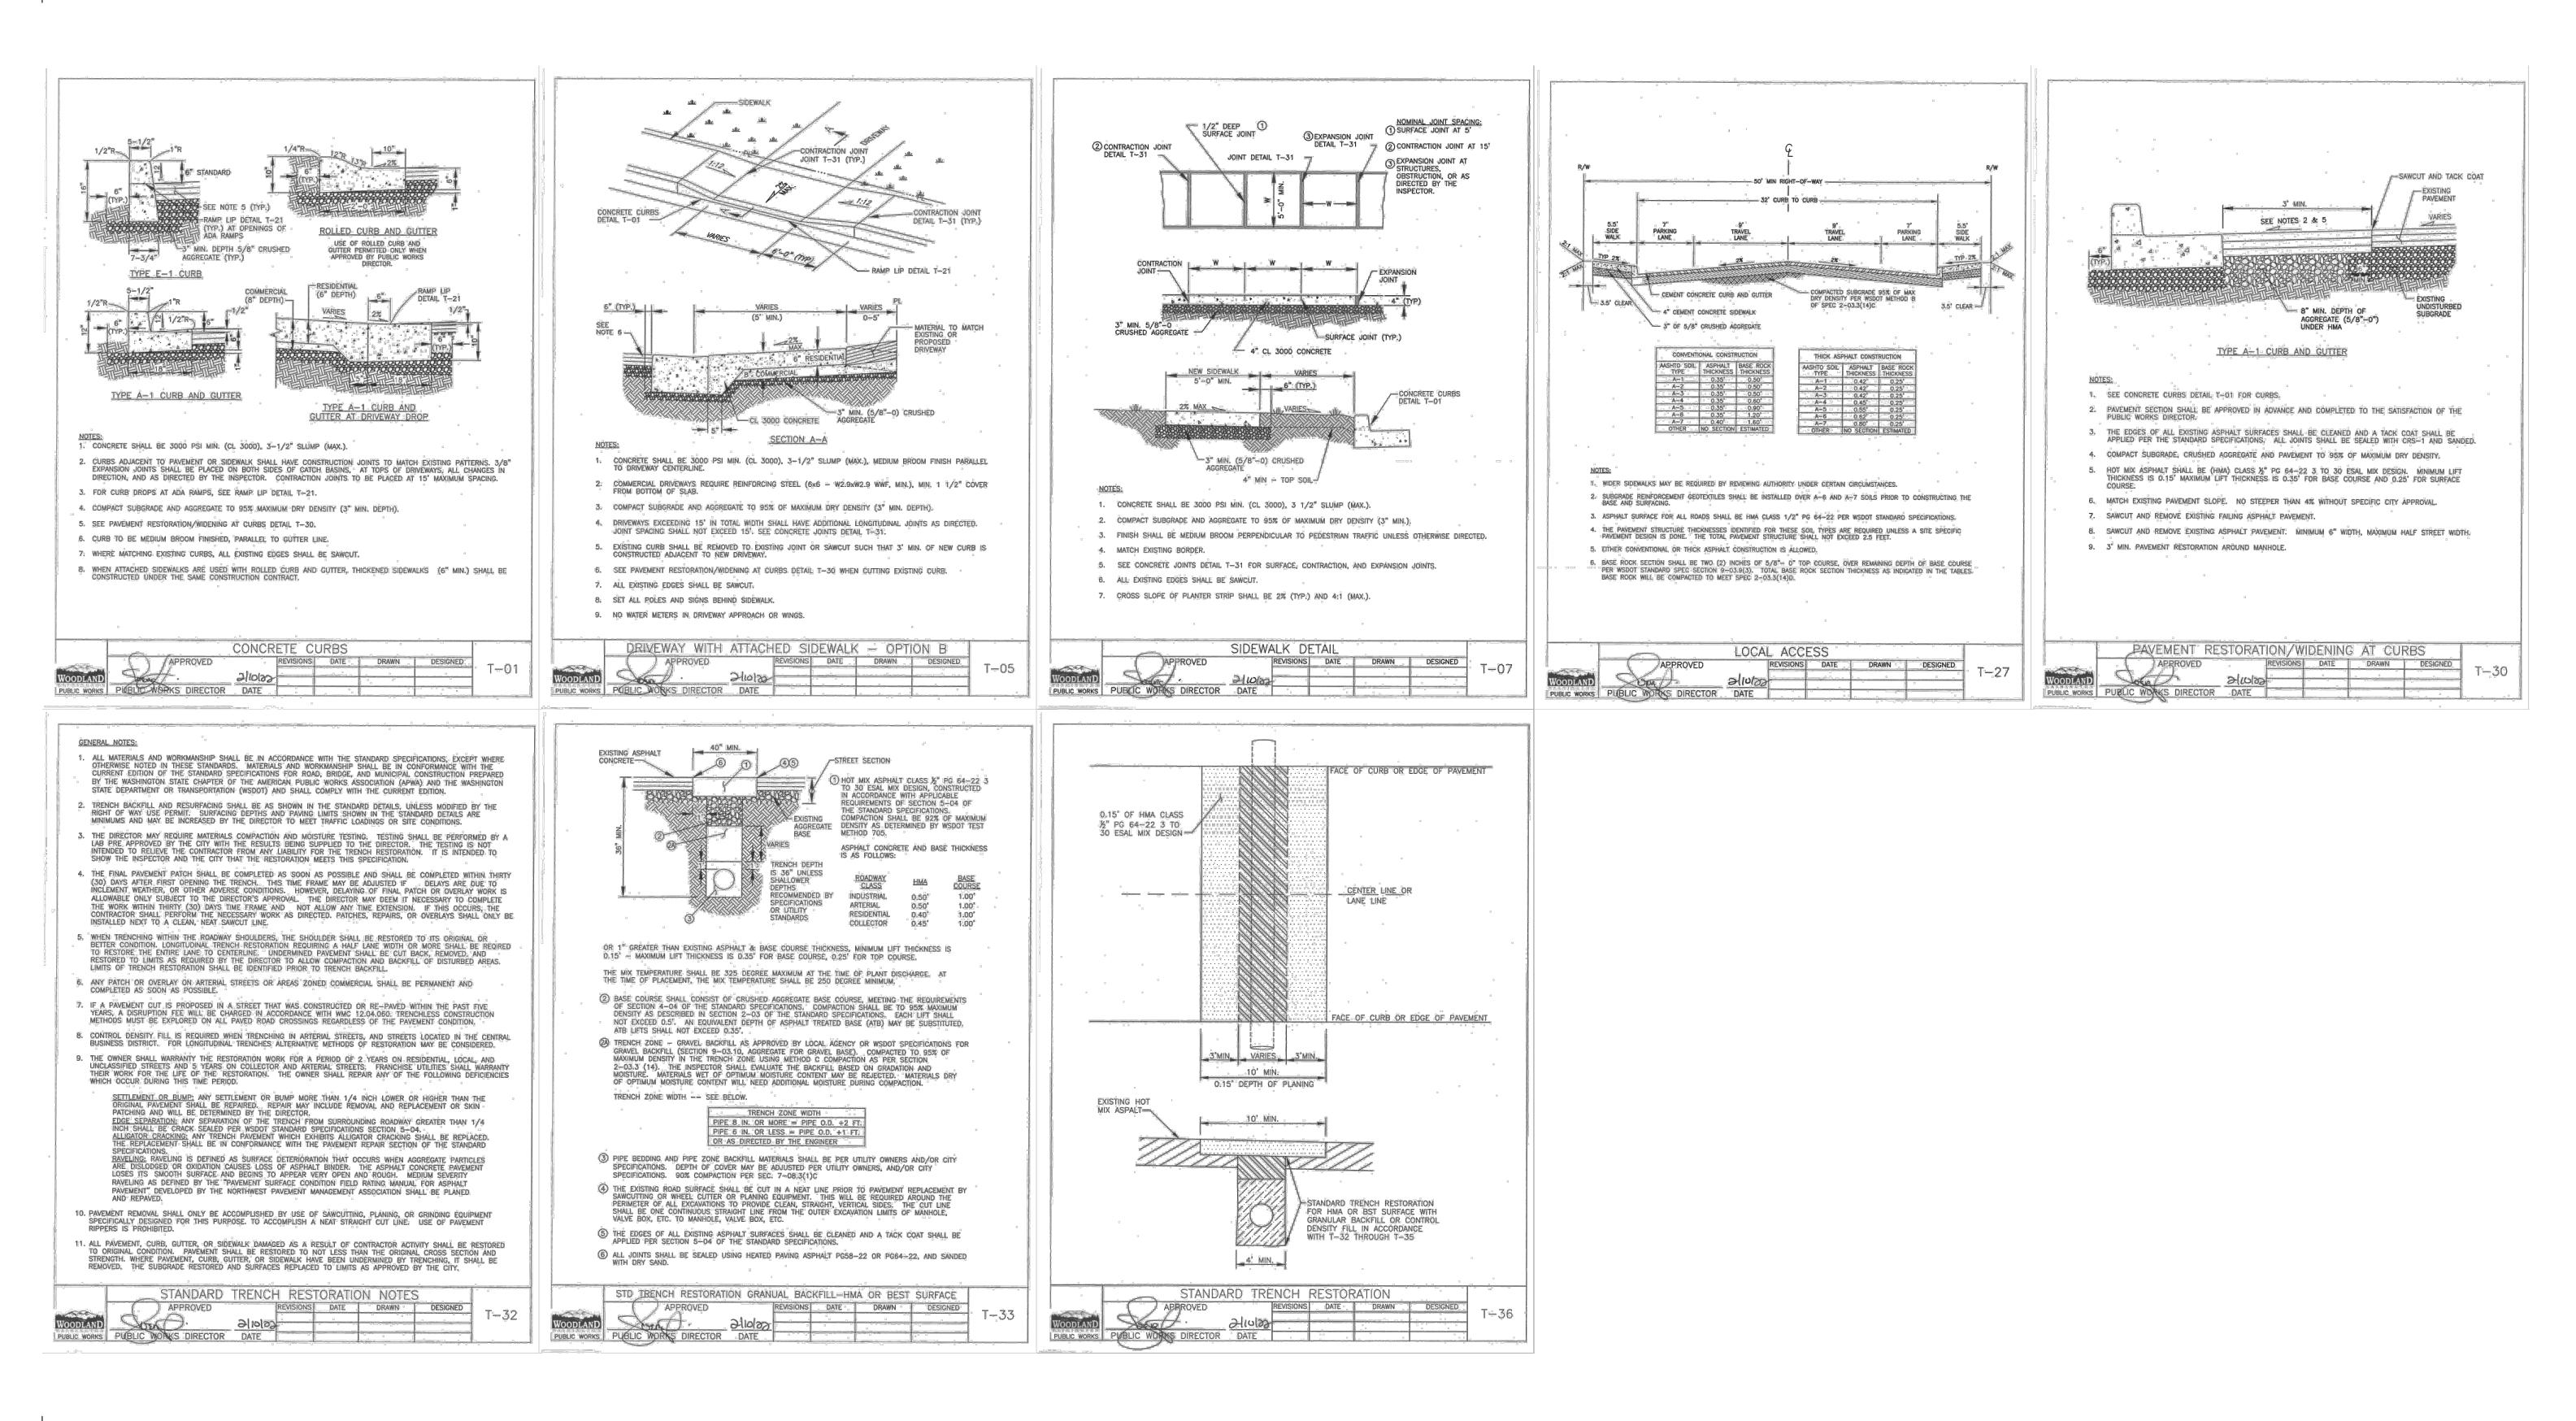
**438 HOMESTEAD** 438 WASHINGTON STREET, WOODLAND, WA 98674
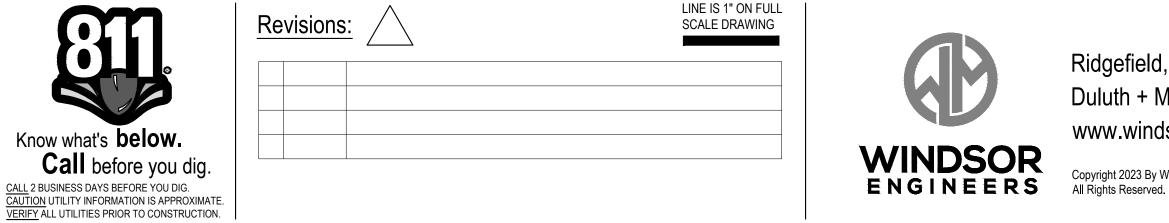
# SITE PLAN REVIEW Project No: 21035.1 Issue Date: 6/21/2023

**EROSION CONTROL DETAILS** 

Project Manager <u>DCK</u> Drawn by <u>CKJ/OK</u> Checked by <u>TWT</u>

**C601** 



| Revisions: | LINE IS 1" ON FULL<br>SCALE DRAWING |                      |                               |
|------------|-------------------------------------|----------------------|-------------------------------|
|            |                                     |                      | Ridgef                        |
|            |                                     |                      | Duluth                        |
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|            |                                     | WINDSOR<br>ENGINEERS | Copyright 20<br>All Rights Re |
|            |                                     |                      | Revisions: Scale DRAWING      |


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**438 HOMESTEAD** 438 WASHINGTON STREET, WOODLAND, WA 98674

SITE PLAN REVIEW Project No: 21035.1 Issue Date: 6/21/2023 SITE DETAILS

Project Manager <u>DCK</u> Drawn by <u>CKJ/OK</u> Checked by <u>TWT</u> C602



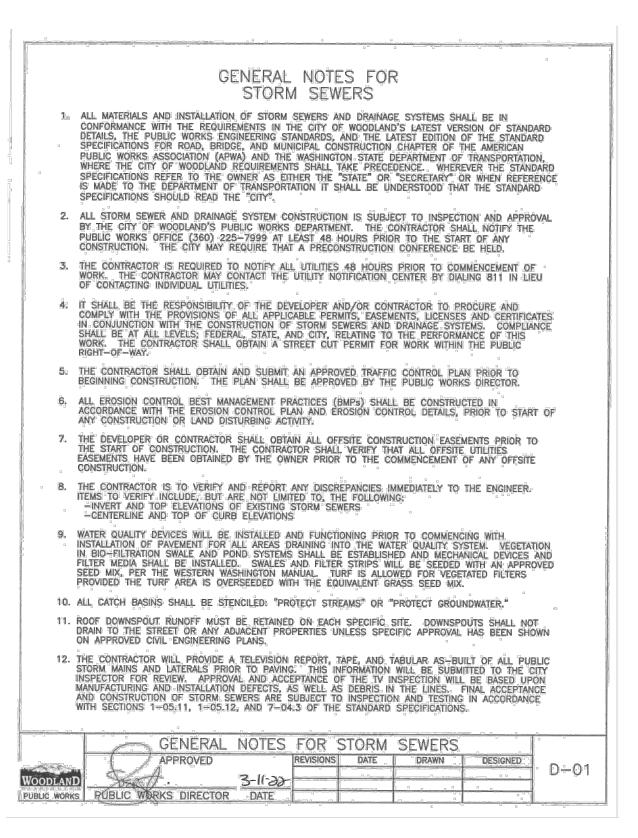

| Know what's <b>below.</b>  |
|--|
| Call before you dig.   |
| ALL 2 BUSINESS DAYS BEFORE YOU DIG.<br>AUTION UTILITY INFORMATION IS APPROXIMATE<br>FRIEVALL UTILITIES PRIOR TO CONSTRUCTION |

LINE IS 1" ON FULL SCALE DRAWING




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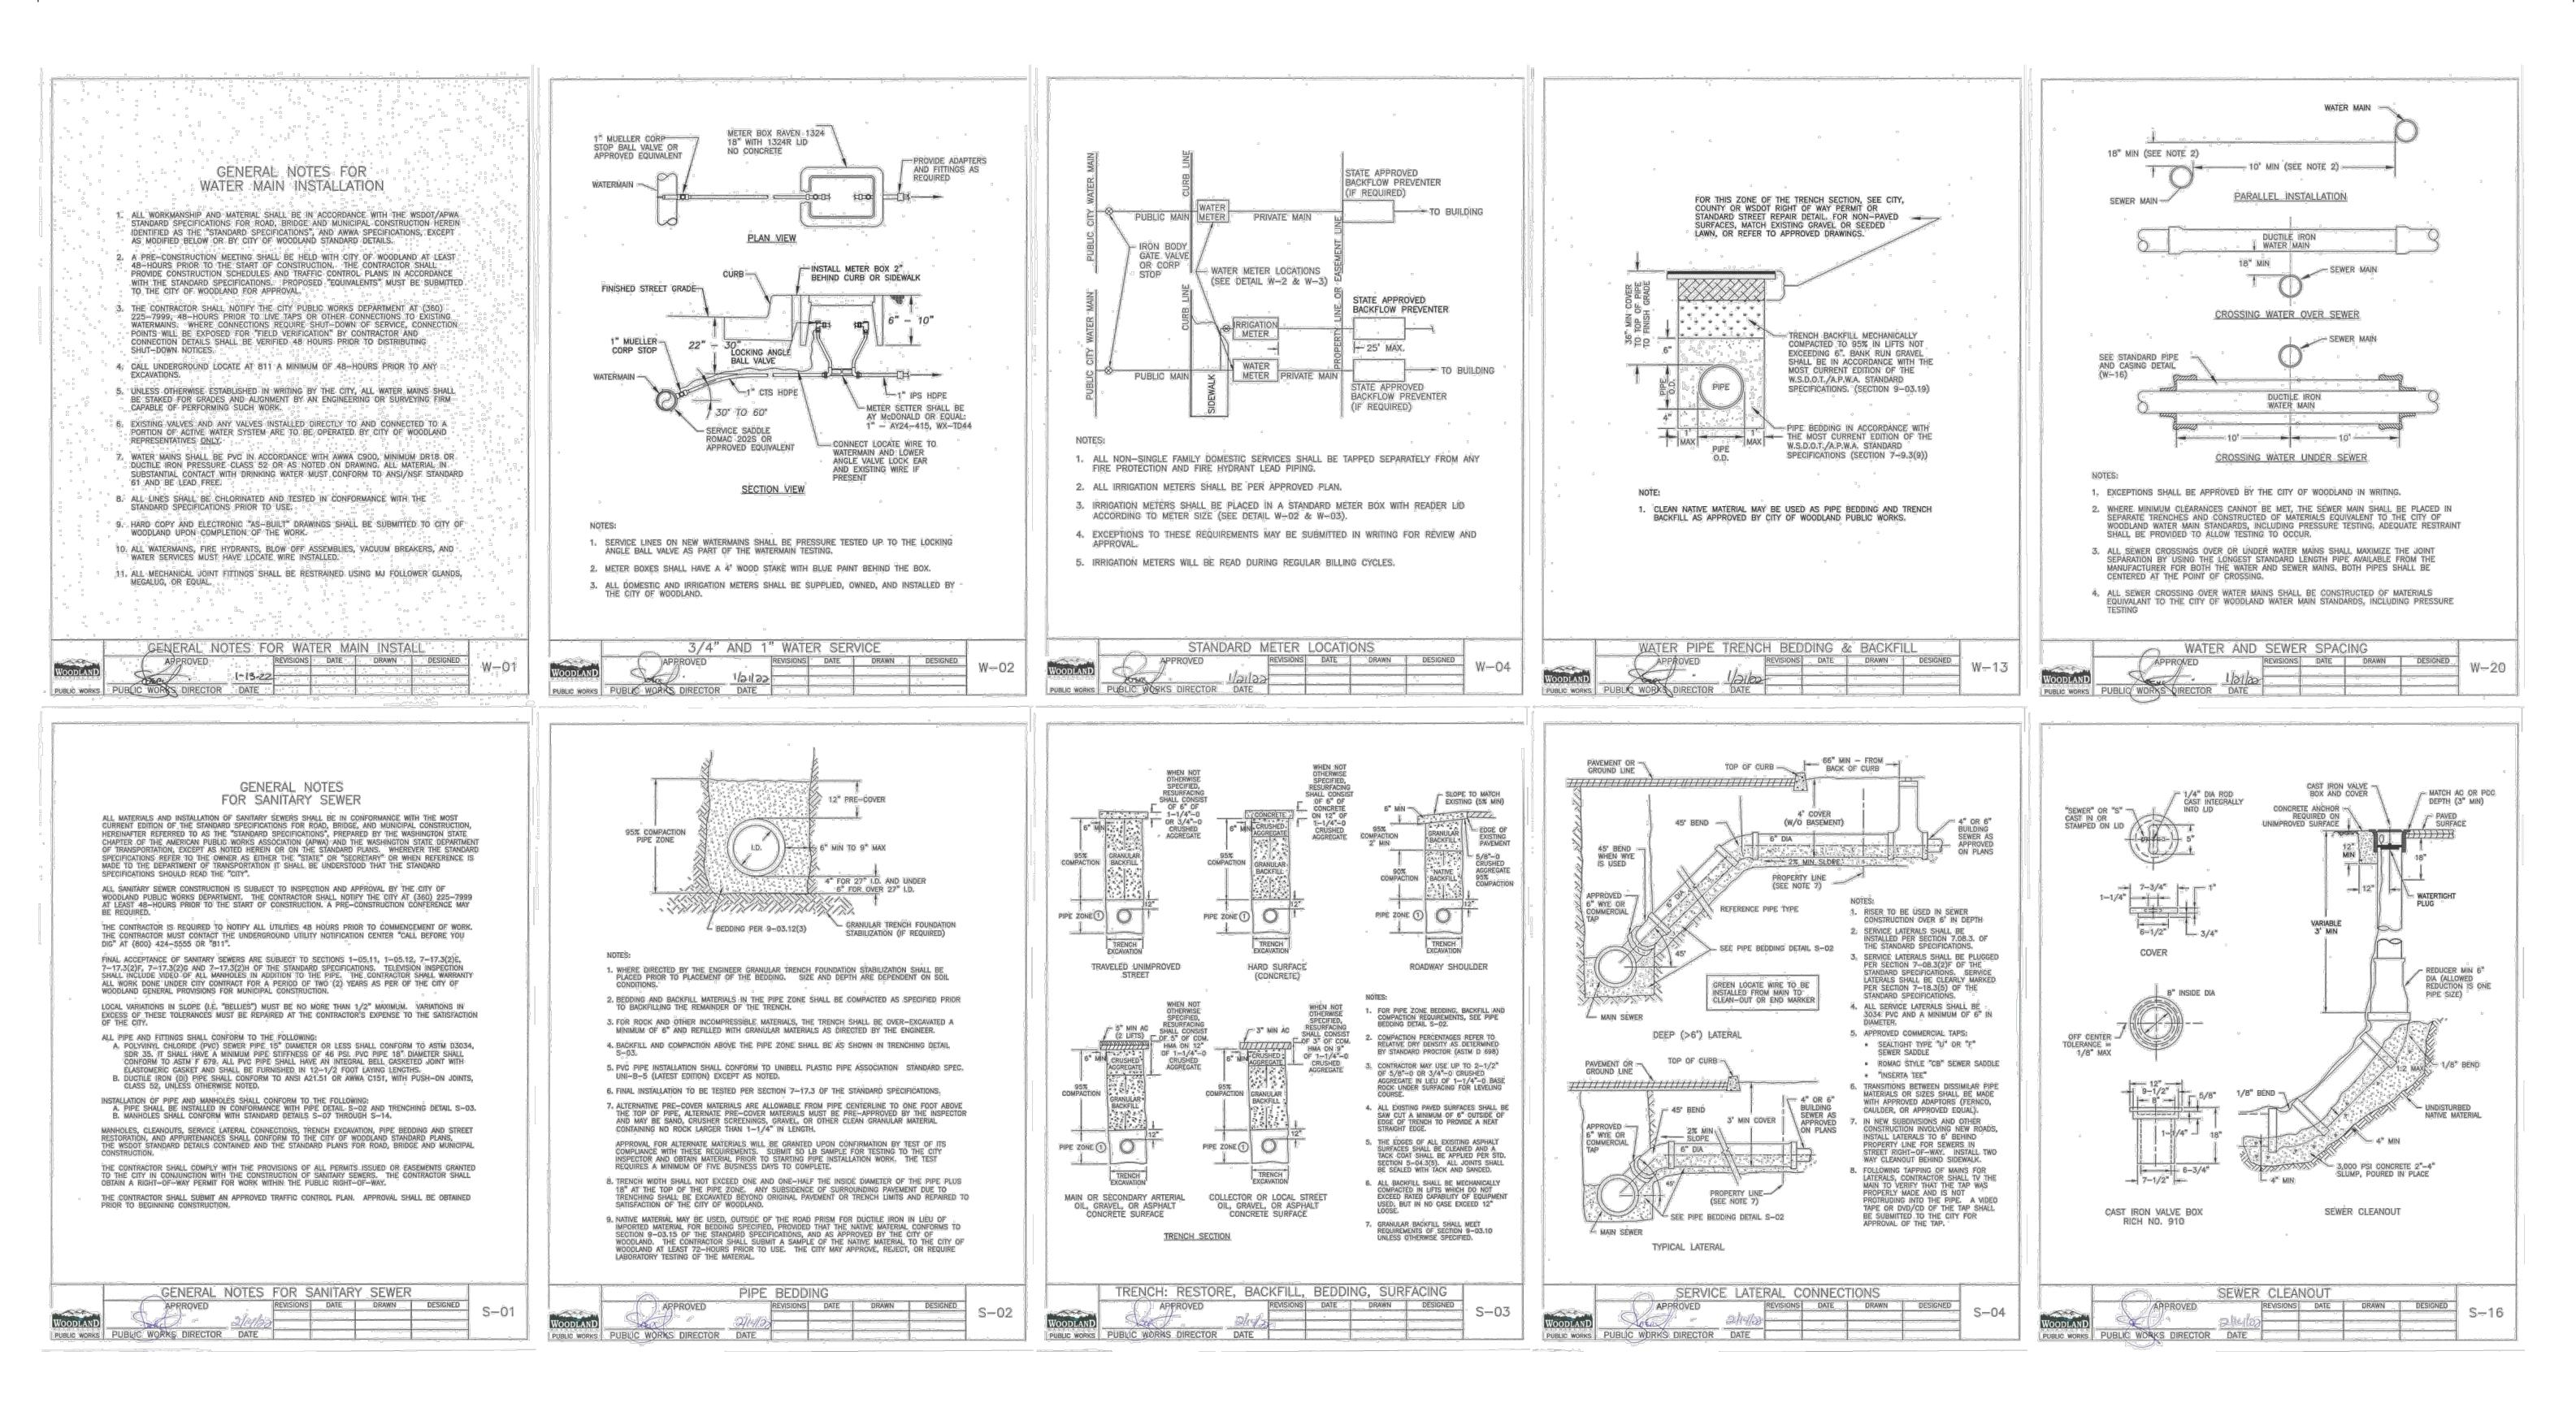



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SITE PLAN REVIEW Project No: 21035.1 Issue Date: 6/21/2023 STORMWATER DETAILS







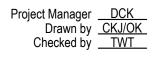
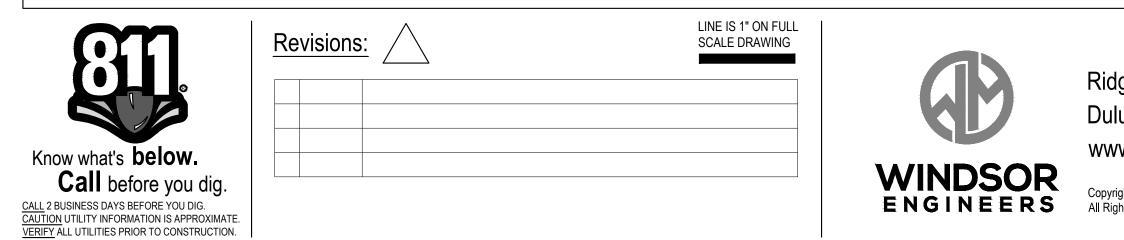
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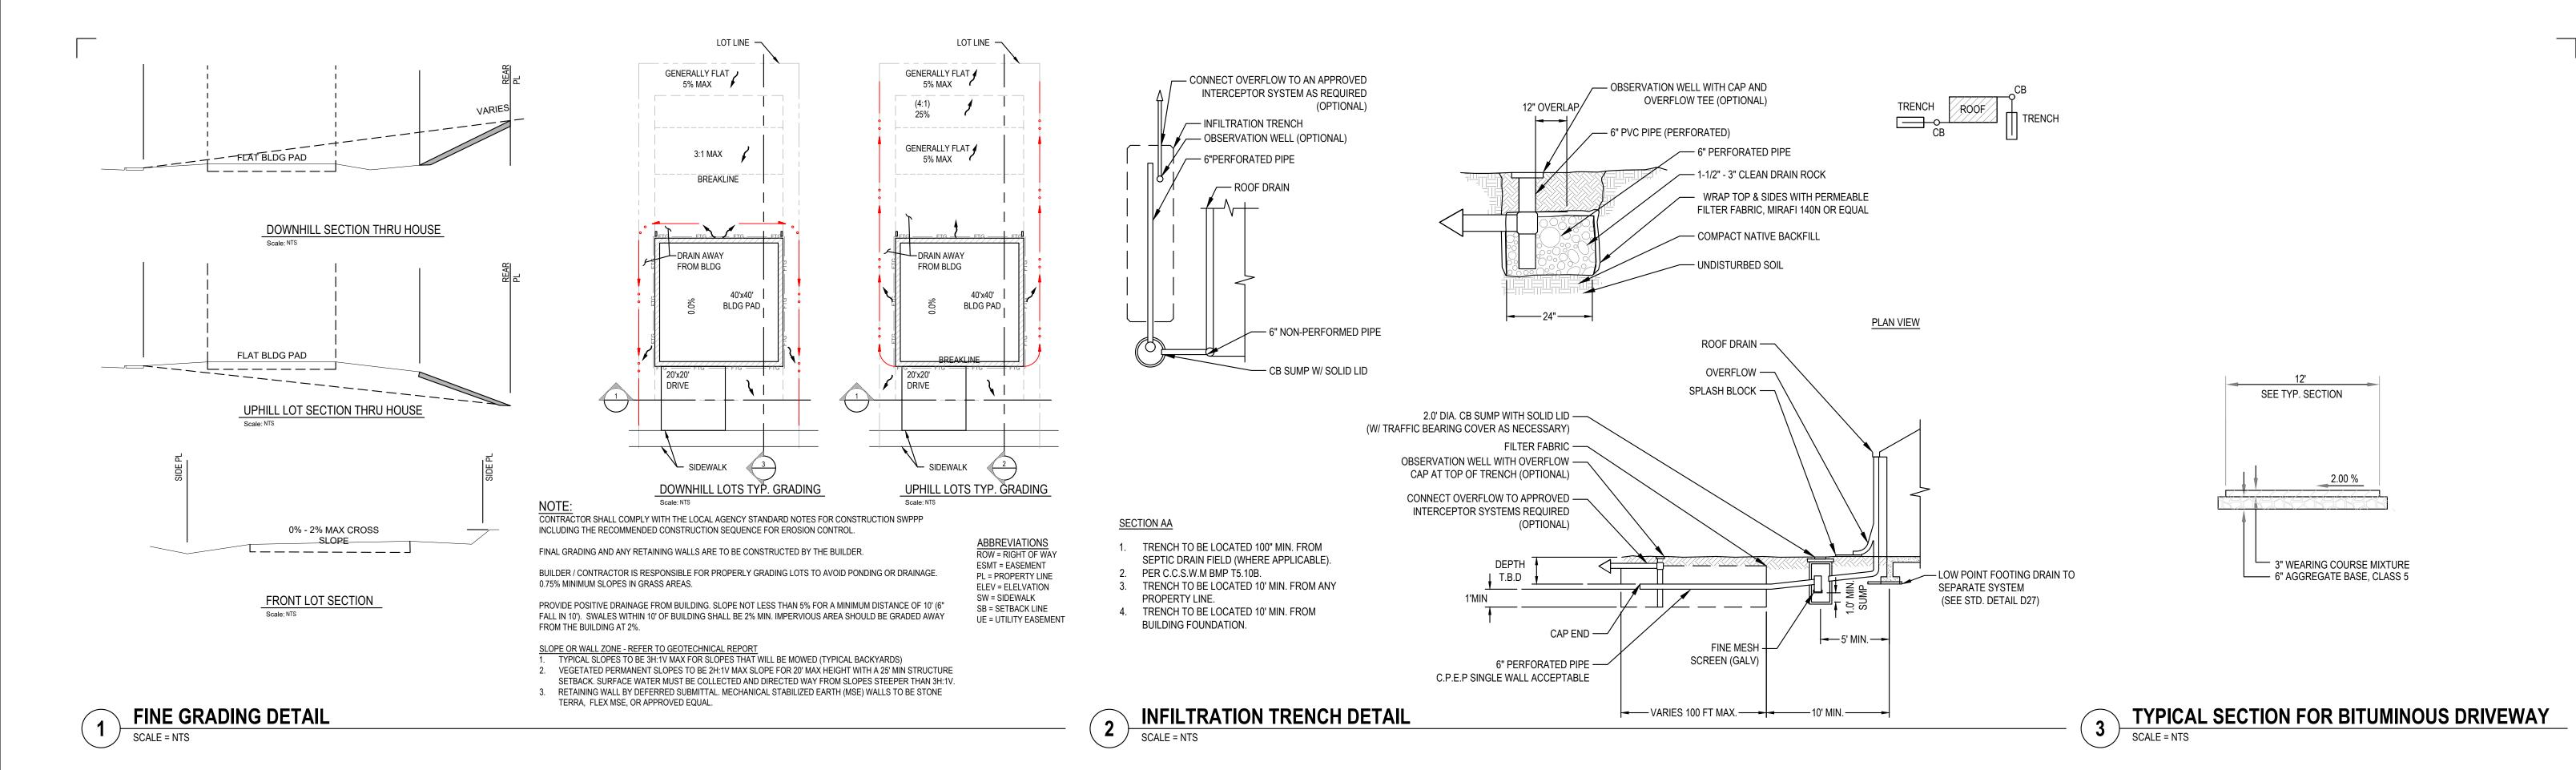
SITE PLAN REVIEW Project No: 21035.1 Issue Date: 6/21/2023

# **UTILITY DETAILS**


C604

REVIEW PLAN SITE FOR ISSUED

Project Manager <u>DCK</u> Drawn by <u>CKJ/OK</u> Checked by <u>TWT</u>



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| CALL 2 BUSINESS DAYS BEFORE YOU DIG.<br>CAUTION UTILITY INFORMATION IS APPROXIMATE.<br>VERIFY ALL UTILITIES PRIOR TO CONSTRUCTION. |

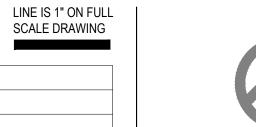



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438 HOMESTEAD 438 WASHINGTON STREET, WOODLAND, WA 98674

SITE PLAN REVIEW Project No: 21035.1 Issue Date: 6/21/2023



SITE DETAILS

Project Manager <u>DCK</u> Drawn by <u>CKJ/OK</u> Checked by <u>TWT</u>

C605