Walmartais

WOODLAND, WASHINGTON STORE NO.: 3742-279

DRAWING INDEX

EXTERIOR ELEVATIONS

PLAN GENERAL NOTES AND DETAILS

MECHANICAL AND PLUMBING PLANS

ELECTRICAL PLANS AND SCHEDULES

DETAILS

GENERAL

ARCHITECTURAL

STRUCTURAL

MECHANICAL

ARCHITECTURAL:

(479) 636-3545

pb2 architecture + engineering

ROGERS, ARKANSAS 72758

2809 AJAX AVENUE SUITE 100

MECHANICAL/ELECTRICAL/PLUMBING: BUILDING REVIEW:

pb2 architecture + engineering

ROGERS, ARKANSAS 72758

2809 AJAX AVENUE SUITE 100

CITY OF WOODLAND BUILDING DIVISION

WOODLAND, WASHINGTON 98674

230 DAVIDSON AVENUE

SPECIAL PROJECT

NAME OF PROJECT

STREET ADDRESS:

PROPOSED USE:

BUILDING CODE:

PLUMBING CODE:

FIRE CODE:

LIFE SAFETY:

MECHANICAL CODE:

ELECTRICAL CODE:

ACCESSIBILITY CODE:

S1-STORAGE AREA

VB UNPROTECTED (SPRINKLERED)

M-MERCANTILE; WHOLESALE OR RETAIL STORE (MAIN USE)

WOODLAND, WASHINGTON SPECIAL PROJECT

2015 IBC W/ WASHINGTON AMENDMENTS

2015 UPC W/ WASHINGTON AMENDMENTS

2017 NEC W/ WASHINGTON AMENDMENTS

2015 IFC W/ WASHINGTON AMENDMENTS

2015 WASHINGTON STATE ENERGY CODE

2015 IBC WITH WASHINGTON AMENDMENTS

1486 DIKE ACCESS RD.

BUILDING CODE SUMMARY

OCCUPANCY:

TYPE OF CONTRUCTION:

ALLOWABLE AREA:

EXISTING SQ FT: DATE:

155,980 10/15/2021

10. WHERE EXISTING FINISHES ARE TO REMAIN, CLEAN, REPAIR, PATCH, AND/OR ALL WORK SHALL BE DONE IN A SAFE MANNER AND IN STRICT ACCORDANCE REPAINT AS NECESSARY TO BLEND WITH ADJACENT SURFACES. COORDINATE WITH WALMART CONSTRUCTION MANAGER. . THE GENERAL CONTRACTOR SHALL BE RESPONSIBLE FOR THE TIMELY

HAVING A THOROUGH KNOWLEDGE OF ALL DRAWINGS AND SPECIFICATIONS IN THEIR RELATED FIELD. THE FAILURE TO ACQUAINT HIMSELF WITH THIS KNOWLEDGE DOES NOT RELIEVE HIM OF ANY RESPONSIBILITY FOR PERFORMING HIS WORK PROPERLY. NO ADDITIONAL COMPENSATION SHALL BE ALLOWED BECAUSE OF CONDITIONS THAT OCCUR DUE TO FAILURE TO FAMILIARIZE WORKERS WITH THIS KNOWLEDGE.

DEBRIS. INSTALL DUST PARTITIONS OR DRAPES AS REQUIRED AND/OR DIRECTED BY THE WALMART CONSTRUCTION MANAGER TO KEEP DUST AND MOISTURE FROM THE OPERATING AREAS OF THE STORE.

ANY DAMAGE TO WALMART PROPERTY, WHICH OCCURS DURING THE PROCESS OF CONSTRUCTION, SHALL BE REPAIRED/REPLACED AT NO ADDITIONAL COST TO WALMART, THIS INCLUDES ALL MERCHANDISE. THE CONTRACTOR SHALL PAY WALMART THE RETAIL COST FOR ALL DAMAGED MERCHANDISE

THE CONTRACTOR SHALL KEEP WORK AREA CLEAN AND FREE OF DEBRIS AND SHALL REMOVE ALL TRASH AND DEBRIS FROM THE CONSTRUCTION AREA DAILY. NO FLAMMABLE MATERIALS OR LIQUIDS MAY BE STORED IN THE EXISTING BUILDING OR CONSTRUCTION AREAS.

REMOVE ANY EXISTING ITEMS. SERVICES. FINISHES OR SURFACES AS REQUIRED FOR THE INSTALLATION OF NEW CONSTRUCTION. PROVIDE FURRING FOR CONDUITS AND PIPING, SHOWN OR NOT, AND FINISH OUT FURRING TO MATCH

FOR THE OPENING (DEMOLITION) OF ANY EXTERIOR WALL. ALL ADJACENT TENANT SPACES SHALL REMAIN IN SERVICE DURING DEMOLITION AND CONSTRUCTION. 16. FIRE ALARM DRAWINGS TO BE FURNISHED AND INSTALLED BY WALMART ALARM

18. CONTRACTOR RESPONSIBLE FOR PERMITS AND TRADE LICENSES THROUGH REPAIR, RE-ROUTE, AND EXTEND ALL SERVICES, PIPING, CONDUIT OF EXISTING ITEMS AND EQUIPMENT AS REQUIRED DURING THE CONSTRUCTION PROCESS FOR THE COMPLETE INSTALLATION AND OPERATIONS OF NEW EQUIPMENT. THIS INCLUDES ALL ITEMS SHOWN OR NOT SHOWN ON THE DRAWINGS. RESET EXISTING EQUIPMENT OR RELATED ITEMS AS REQUIRED FOR PROPER

SITE VERIFICATION

REQUIREMENTS

THE ARCHITECT HAS PREPARED THESE DRAWINGS BASED ON THE EXISTING

BUILDING CONDITIONS. IT IS THE RESPONSIBILITY OF THE CONTRACTOR TO

PAID DUE TO THE CONTRACTOR'S FAILURE TO ACQUAINT HIMSELF WITH EXISTING SITE CONDITIONS WHICH INCLUDE, BUT ARE NOT LIMITED TO EXISTING

ANY DISCREPANCY WITH THE EXISTING SITE CONDITIONS AND/OR THE DRAWINGS SHALL BE BROUGHT TO THE ATTENTION OF THE ARCHITECT FOR

WALL, CEILINGS, OR UTILITIES.

MATCH EXISTING CONDITIONS.

VERIFY ALL EXISTING CONDITIONS PRIOR TO THE SUBMISSION OF HIS BID AND

CLARIFICATION AND INSTRUCTION. THESE CONSTRUCTION DOCUMENTS HAVE

UPON ARRIVAL AT THIS SITE, SHALL VERIFY ALL EXISTING STRUCTURAL COLUMN

ROOFING CONDITIONS (INCLUDING PARAPETS). IF DISCREPANCIES ARE FOUND

ARCHITECT IMMEDIATELY TO DETERMINE WHAT ACTION SHOULD BE TAKEN TO

ALL UTILITY LOCATIONS SHOWN ARE APPROXIMATE. THE CONTRACTOR SHALL FIELD VERIFY THE EXACT LOCATION OF ALL EXISTING UTILITIES (WHETHER

COMMENCEMENT OF CONSTRUCTION. THE CONTRACTOR SHALL NOTIFY THE

REPORT ANY DISCREPANCIES FOUND IN THE FIELD IMMEDIATELY TO WALMART

BEEN DESIGNED AND DRAWN ASSUMING EXISTING BUILDING CONDITIONS MATCH THE ORIGINAL DRAWINGS. THE GENERAL CONTRACTOR, IMMEDIATELY

DIMENSIONS, STRUCTURAL BEARING HEIGHTS, EXISTING DIMENSION, AND

CONDITIONS, CONTACT THE WALMART CONSTRUCTION MANAGER AND THE

BETWEEN WHAT IS SHOWN ON THE DRAWINGS AND EXISTING FIELD

SHOWN OR NOT) PRIOR TO THE SUBMISSION OF HIS BID OR THE

OF EXISTING UTILITIES NOT SHOWN OR NOTED ON THE DRAWINGS.

THE CONTRACTOR SHALL VERIFY EXACT LOCATIONS AND DEPTHS OF UNDERGROUND UTILITY SERVICES PRIOR TO ANY EXCAVATION.

THE COMMENCEMENT OF ANY WORK. NO ADDITIONAL COMPENSATION WILL BE

CONSTRUCTION OPERATIONS.

LOCAL JURISDICTION.

CONTRACTOR IS RESPONSIBLE FOR ALL JOBSITE SAFETY AND COMPLIANCE WITH REGULATIONS. CONTRACTOR SHALL INSTALL TEMPORARY WALL, DUST BARRICADES AND CONSTRUCTION BARRIERS AND TAKE ALL PRECAUTIONS TO PROTECT CUSTOMERS AND ASSOCIATES FROM CONSTRUCTION OPERATIONS.

THE CONTRACTOR SHALL FIELD VERIFY THE EXTENT OF DEMOLITION. IF

FINISH FLOOR OR A MINIMUM OF 6" ABOVE FINISH CEILING. MANAGER FOR APPROPRIATE HOURS TO MINIMIZE CUSTOMERS

GENERAL CONTRACTOR IS RESPONSIBLE FOR REMOVAL OF CONSTRUCTION AND ASSOCIATES FROM CONTACT WITH CONSTRUCTION WASTE.

AND THE ARCHITECT PRIOR TO MAKING ANY MODIFICATIONS OR ORDERING OF

GENERAL SCOPE OF WORK

NEW EXTERIOR SLIDING DOOR FOR PICKUP EXPANSION OF EXISTING LANDING AND RAMP AT PICKUP DOOR

INSTALLATION OF ASSOCIATE CANOPY AT PICKUP DOOR AND RAMP

GENERAL REQUIREMENTS

WITH THE LOCAL AND/OR STATE BUILDING CODES, AND ALL APPLICABLE CODES. REGULATION, ORDINANCES, AND AUTHORITIES HAVING JURISDICTION. EACH CONTRACTOR AND THEIR SUB-CONTRACTORS ARE RESPONSIBLE FOR ORDERING OF MATERIALS TO PROHIBIT DELAYS OF THE CONSTRUCTION

2. THE GENERAL CONTRACTOR SHALL RESPOND TO ALL REQUIREMENTS OF THE

SCHEDULE ALL WORK TO KEEP DISRUPTIONS TO THE STORE OPERATIONS AT A MINIMUM. COORDINATE UTILITY DISRUPTIONS WITH THE WALMART STORE

DEMOLITION NOTES

SCHEDULE OF THIS PROJECT. IT IS THE RESPONSIBILITY OF THE CONTRACTOR

CHEMICAL FIRE EXTINGUISHER, OR ONE STANDARD U.L. LISTED 2-1/2 GALLON

MOUNTED TOGETHER IN EACH 3000 SQUARE FOOT OF WORK AREA OR

CONTRACTOR SHALL HIRE A LICENSED SPRINKLER CONTRACTOR. THE

APPROVAL TO THE AHJ PRIOR TO ANY ALTERATION OF THE AUTOMATIC

15. THE CONTRACTOR SHALL MAINTAIN THE INTEGRITY OF THE EXISTING BUILDING

BE RESPONSIBLE TO MAINTAIN THE INTEGRITY OF ALL EXISTING SECURITY

SYSTEM. THE CONTRACTOR SHALL OBTAIN PERMISSION FROM THE STORE MANAGER PRIOR TO THE MODIFICATION OF ANY EXISTING SECURITY SYSTEM

CURITY AT ALL TIMES. THIS INCLUDES KEEPING THE BUILDING SECURE FROM

PERSONS, ENVIRONMENTAL ELEMENTS OR HAZARDS. THE CONTRACTOR SHALL

7. CONTRACTOR TO MAINTAIN ACCESS TO ALL EMERGENCY EGRESS EXITS DURING

4. IF MODIFICATION TO SPRINKLER SYSTEM IS REQUIRED. THE GENERAL

WATER (E-10) AND ONE U.L. LISTED 10BC CARBON DIOXIDE FIRE EXTINGUISHER

FRACTION THEREOF (MINIMUM OF TWO AVAILABLE IN ALL CONSTRUCTION AREAS

CONTRACTOR IS TO SUBMIT SIGNED AND SEALED SPRINKLER DRAWINGS FOR

TO COORDINATE DELIVERY OF MATERIALS IN A TIMELY MANNER.

ARCHITECT FOR VERIFICATIONS, RESPONSES AND SUBMISSIONS.

DISCREPANCIES ARE FOUND, CONTACT THE ARCHITECT AND WALMART CONSTRUCTION MANAGER. WHEN UTILITIES ARE REMOVED, CAP AND SEAL A MINIMUM OF 8" BELOW

SAW CUTTING OF EXISTING CONCRETE WILL BE COORDINATED WITH STORE DISTURBANCE. NO JACKHAMMERS ARE ALLOWED.

WASTE AND DEBRIS. DO NOT USE STORE DUMPSTERS. PREVENT CUSTOMERS COORDINATE LOCATION OF DUMPSTER ON SITE WITH WALMART CM.

WALMART CONSTRUCTION MANAGER AND THE ARCHITECT OF THE DISCOVERY

DOCUMENTS THAT DO NOT HAVE THE ARCHITECT OR

2809 Ajax Avenue Suite 100 Rogers Arkansas 72758

Phone: 479.636.3545 Fax: 479.636.1209 Architect of Record William Douglas Hurley Washington License No. 885 Unified Business ID No. 602 491 66

SPECIAL PROJECT

ISSUE BLOCK

CHECKED BY:


DRAWN BY:

PROTO CYCLE:

DOCUMENT DATE: 10/15/2021

ENGINEER OF RECORD SEAL AND SIGNATURE SHALL BE CONSIDERED NOT FOR CONSTRUCTION


> COVER SHEET

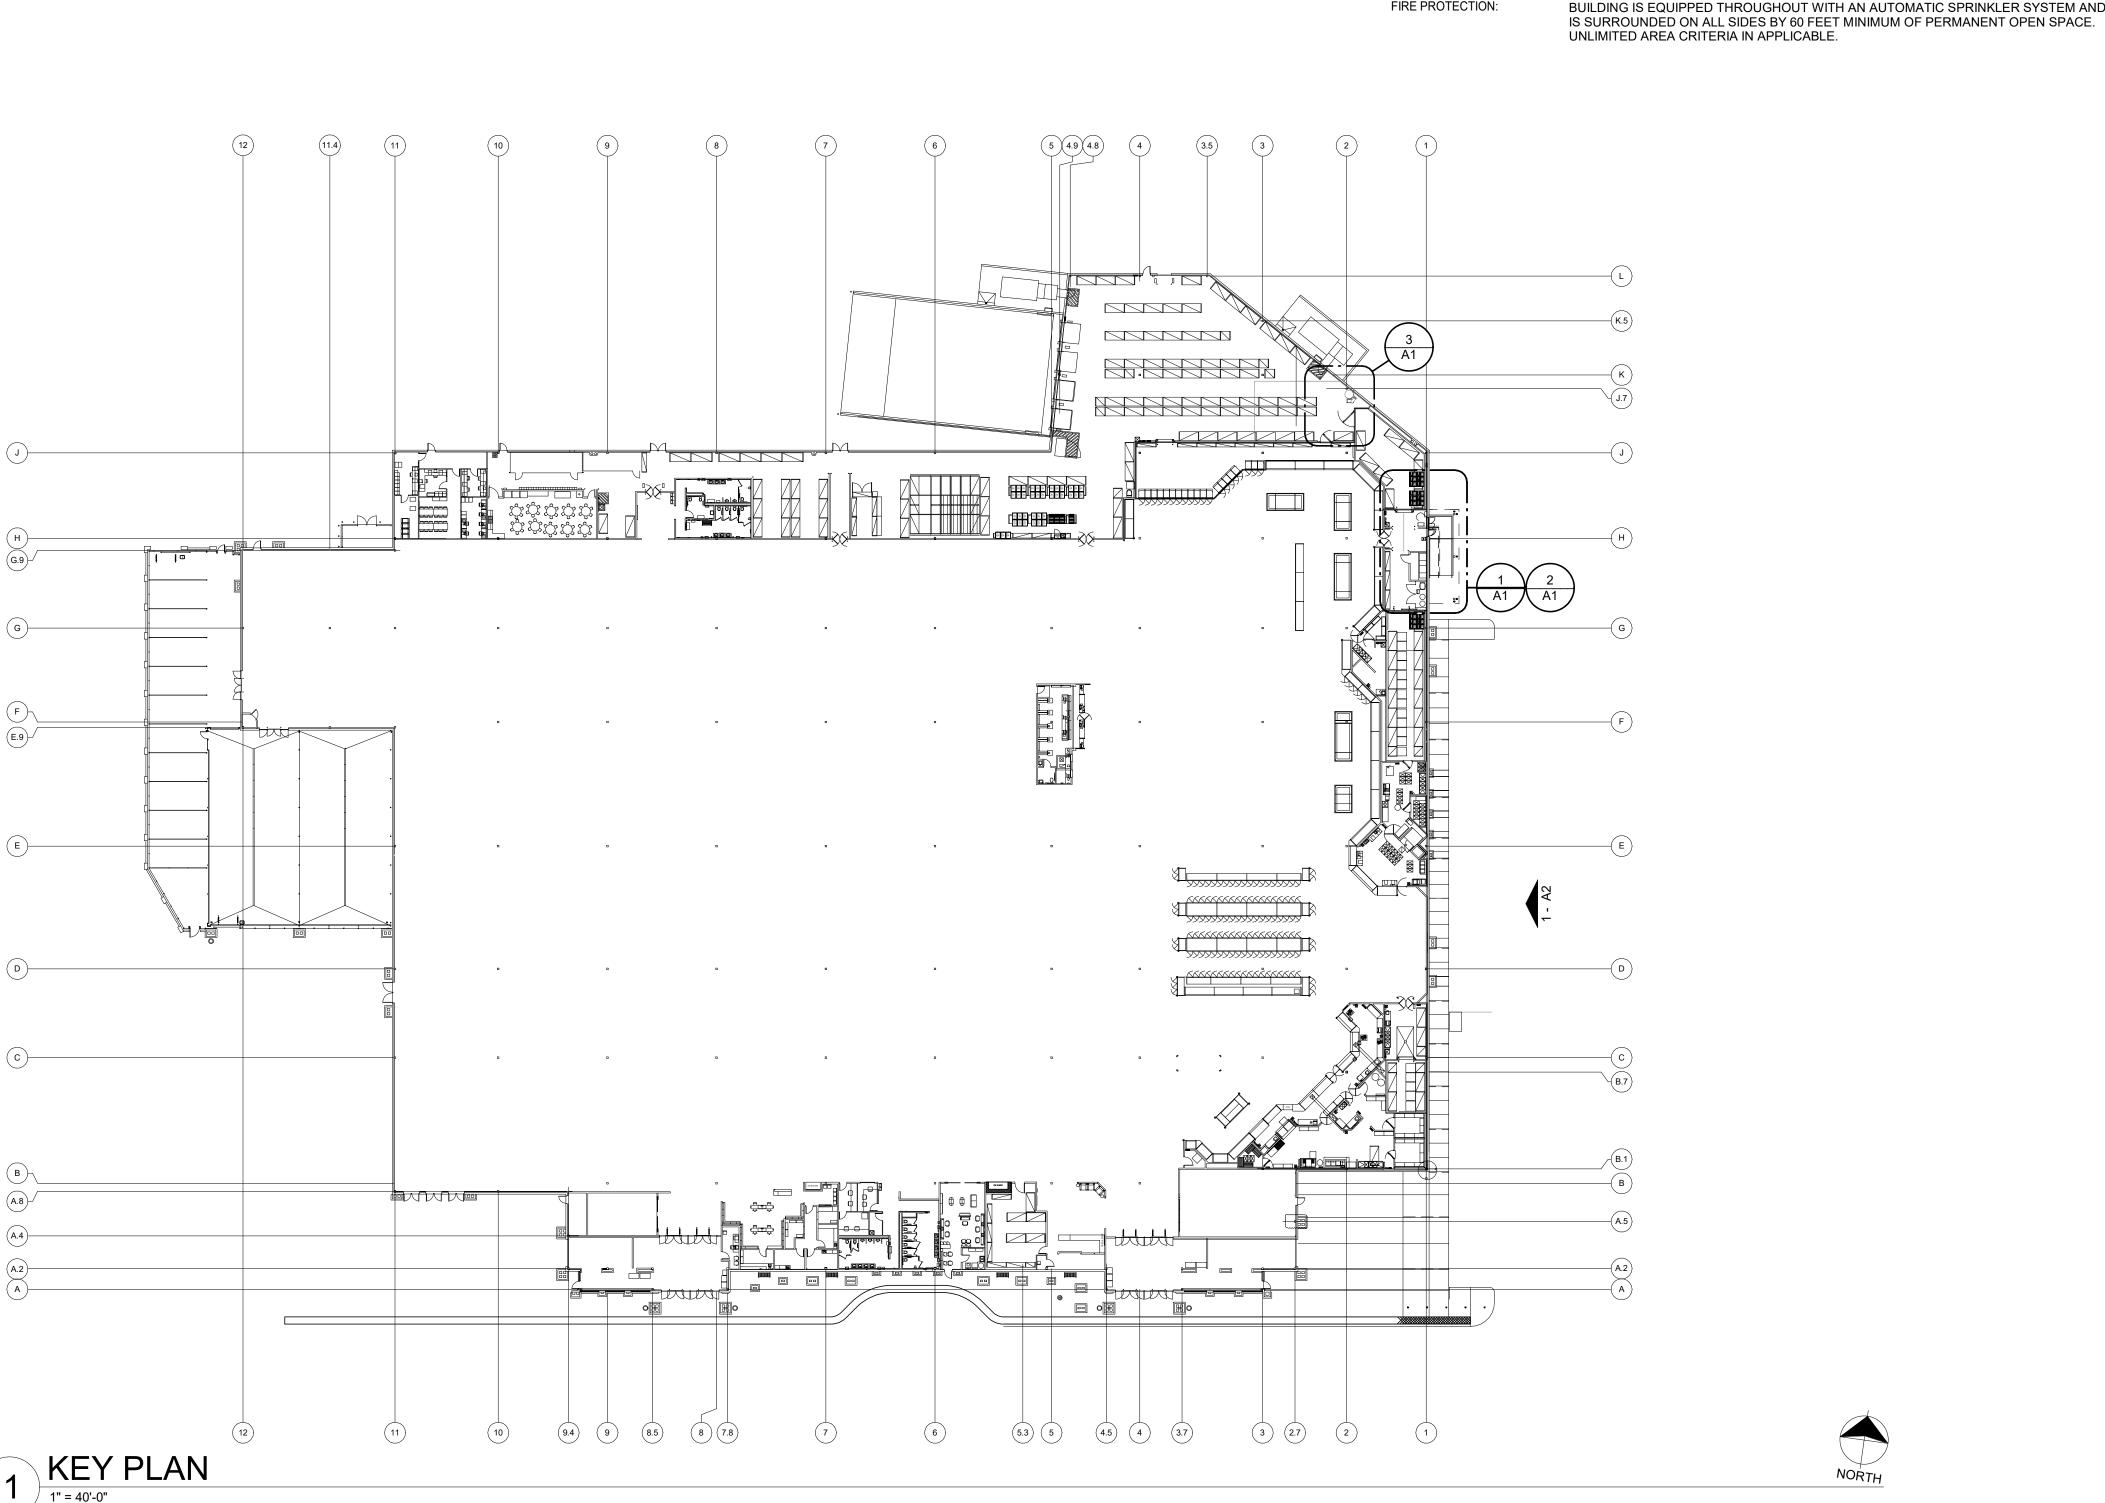

STORE ADDRESS:

1486 DIKE ACCESS RD.

WOODLAND, WASHINGTON 98674

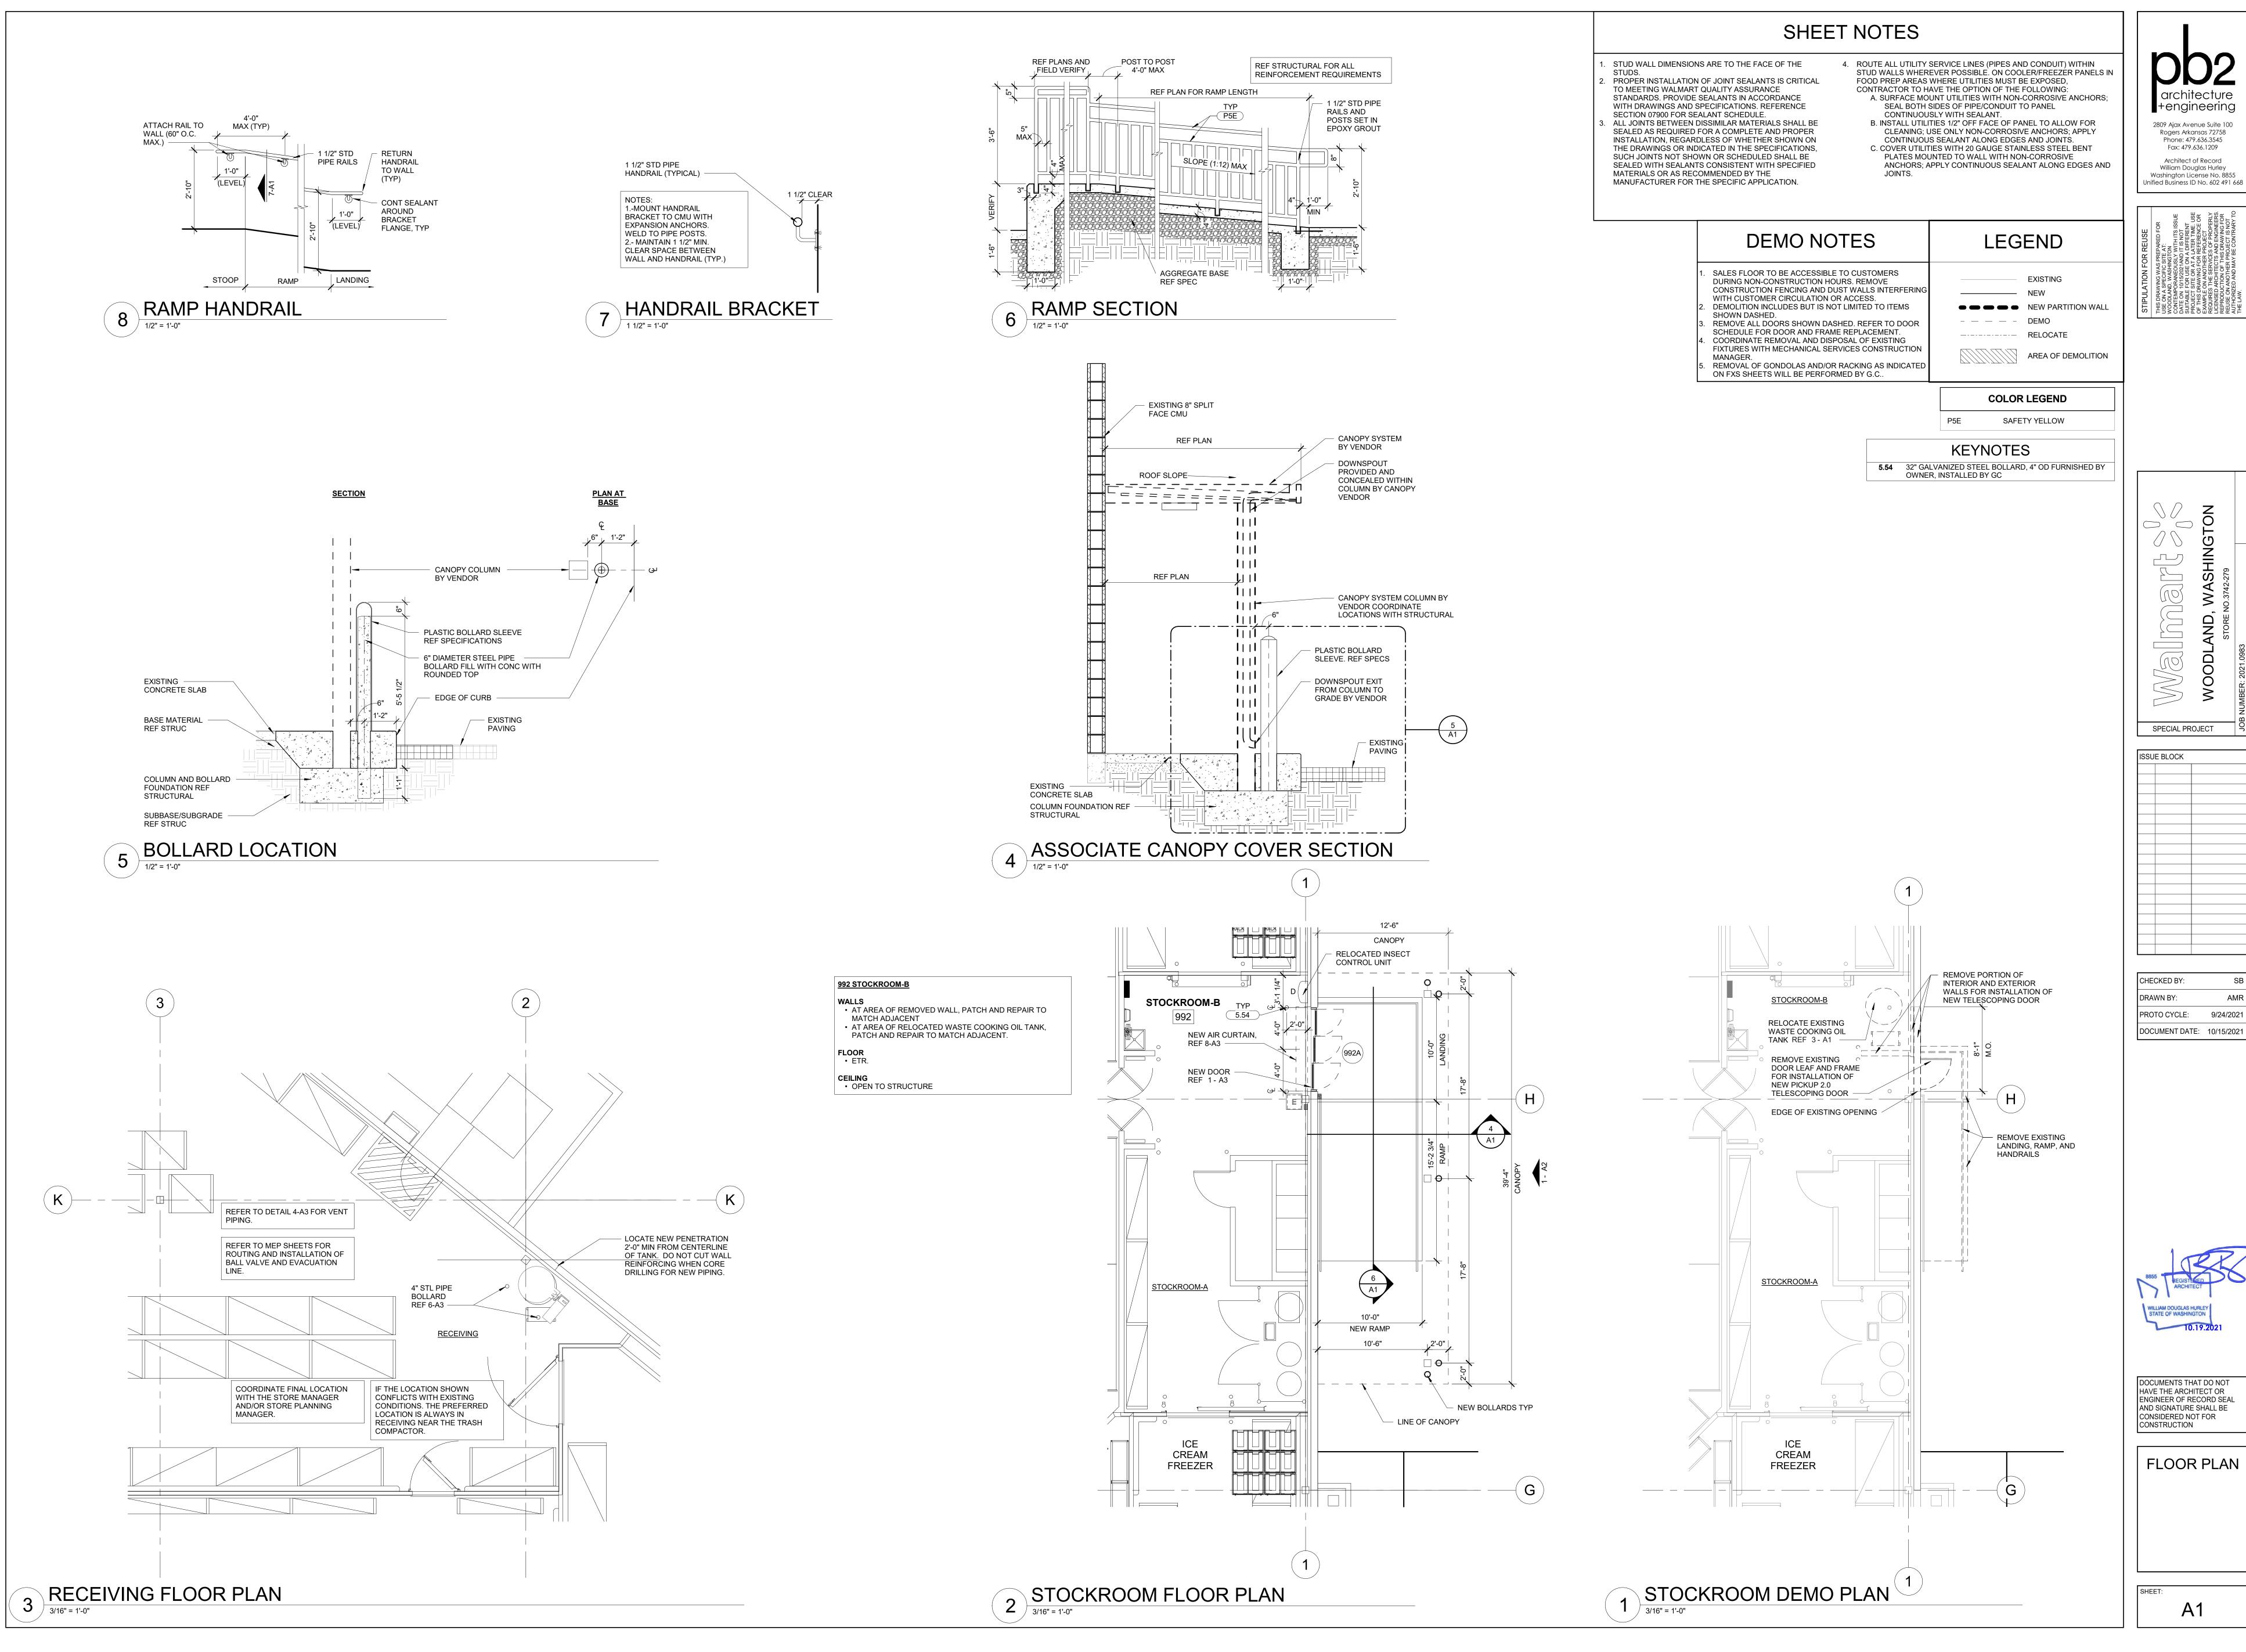

+engineering 2809 Ajax Avenue Suite 100 Rogers Arkansas 72758

Phone: 479.636.3545 Fax: 479.636.1209 Architect of Record William Douglas Hurley Washington License No. 8855 Unified Business ID No. 602 491 668

SHINGTON SPECIAL PROJECT

> CHECKED BY: DRAWN BY: PROTO CYCLE: 9/24/2021

DOCUMENTS THAT DO NOT HAVE THE ARCHITECT OR ENGINEER OF RECORD SEAL AND SIGNATURE SHALL BE CONSIDERED NOT FOR CONSTRUCTION


FLOOR PLAN

A1


KEYNOTES 5.01 6" PIPE BOLLARD WITH GRAY PLASTIC SLEEVE (HEIGHT OF SLEEVE NOTED ADJACENT TO KEYNOTE)


COLOR LEGEND

P162E **BLACK GRAY**

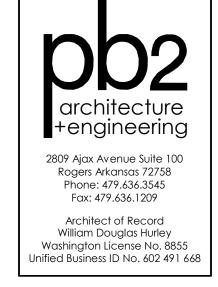





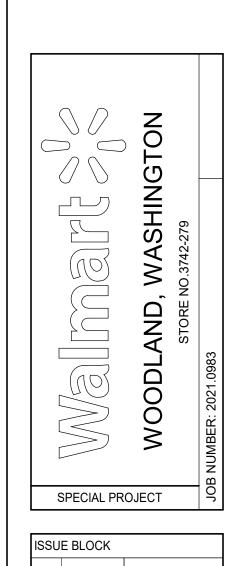

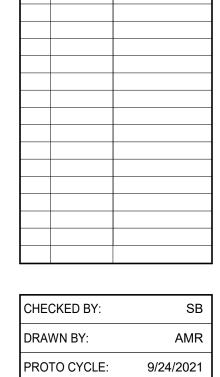


DOCUMENT DATE: 10/15/2021

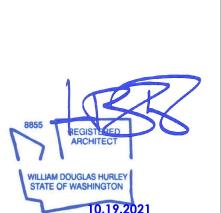


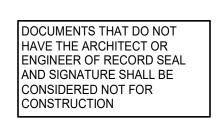


EXTERIOR ELEVATIONS


A2

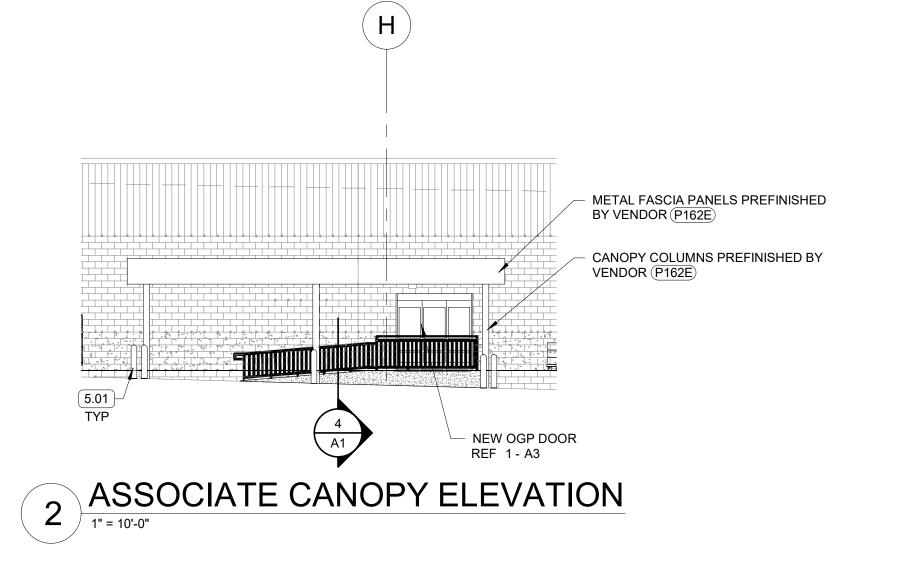

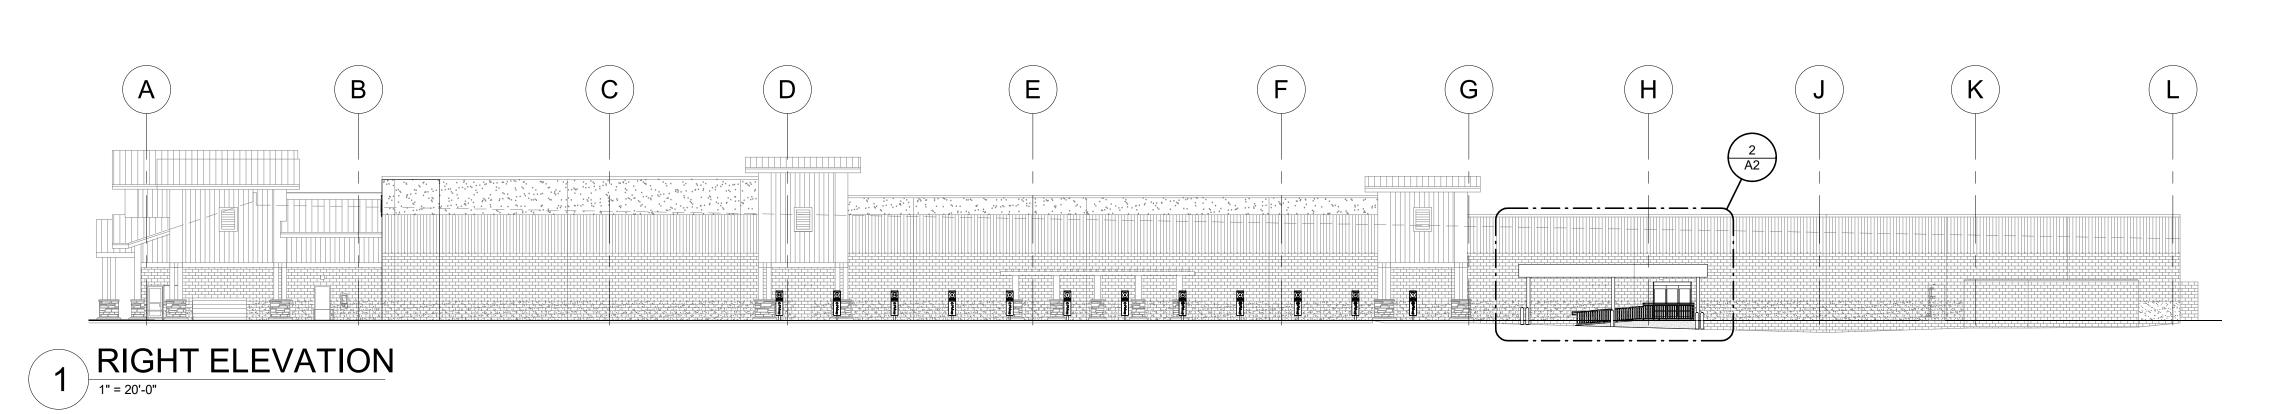

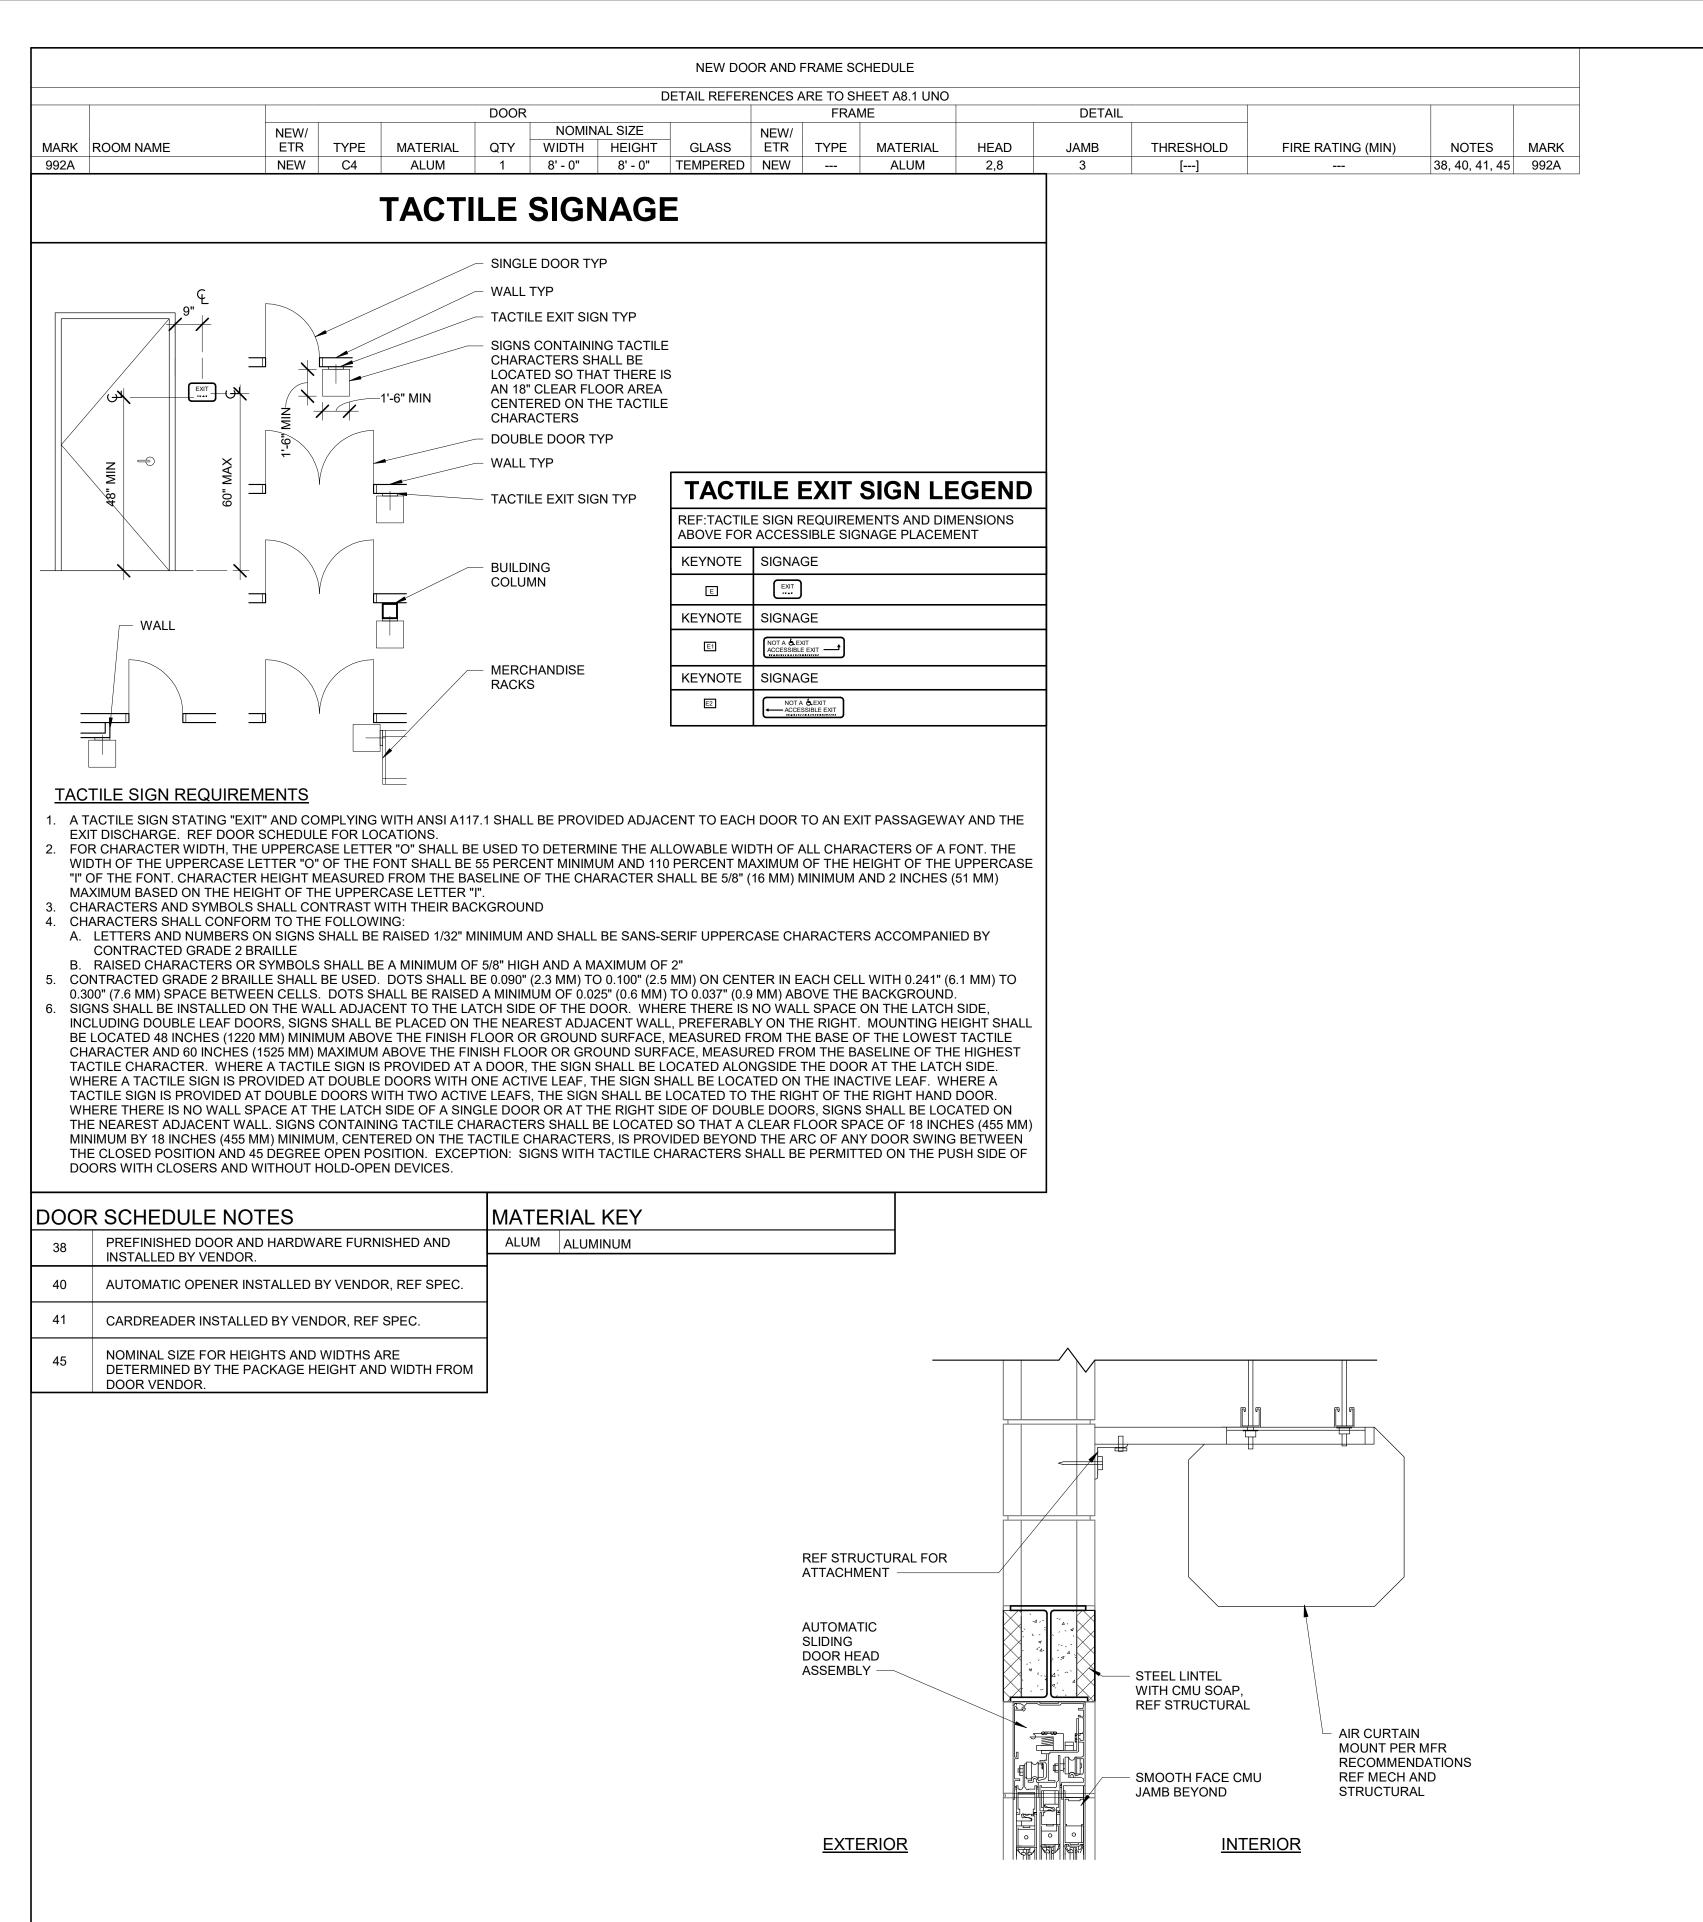

8 AIR CURTAIN AT SURFACE MOUNTED DOOR

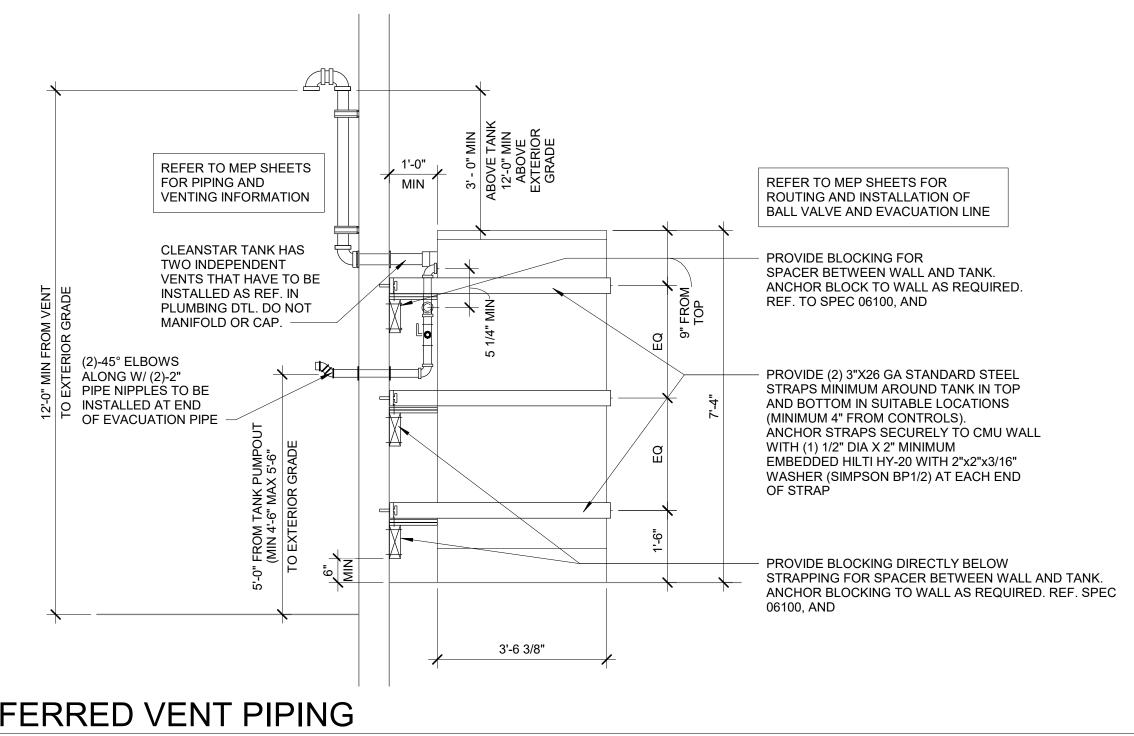

GENERAL NOTES

FURNISH AND INSTALL ALL MATERIALS REQUIRED FOR A COMPLETE INSTALLATION READY FOR INTENDED USE. SCHEDULE ALL WORK TO KEEP DISRUPTIONS TO THE STORE


OPERATIONS AT A MINIMUM. COORDINATE UTILITY

DISRUPTIONS WITH THE WALMART STORE MANAGER. GENERAL CONTRACTOR TO COORDINATE RELOCATION OF TANK WITH WALMART CONSTRUCTION MANAGER. . ENVIRONMENTAL, HEALTH AND SAFETY COMPLIANCE SHALL BE RESPONSIBLE FOR EMPTYING, HANDLING, REMOVAL, AND DISPOSAL OF TANK CONTENTS.

SHEET NOTES

- EXISTING CONDITIONS SHOWN IN THESE PLANS ARE FROM ORIGINAL DESIGN DRAWINGS AND HAVE NOT BEEN FIELD VERIFIED BY THE ARCHITECT. ALL EXISTING MATERIAL. DIMENSIONS, ELEVATION, AND GENERAL CONDITIONS OF THE BUILDING SHALL BE VERIFIED BEFORE PURCHASE OF MATERIAL AND CONSTRUCTION. CONTRACTOR TO NOTIFY WALMART CONSTRUCTION MANAGER OF ANY DISCREPANCIES BETWEEN PLANS AND FIELD CONDITIONS IMMEDIATELY
- GENERAL CONTRACTOR SHALL PROVIDE DISCONNECTION OF ALL EQUIPMENT, LINE, PIPES, AND RETAINING
- HARDWARE. GENERAL CONTRACTOR SHALL NOT PERFORM ANY WORK BEFORE THE TANK HAS BEEN EMPTIED. GENERAL CONTRACTOR SHALL COORDINATE ALL WORK

WITH WALMART CONSTRUCTION MANAGER.

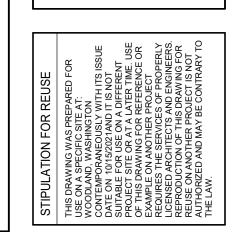

NGTON

ODF

SPECIAL PROJECT

ISSUE BLOCK

CHECKED BY:

PROTO CYCLE:

DOCUMENT DATE: 10/15/2021

DRAWN BY:

+engineering

2809 Ajax Avenue Suite 100


Rogers Arkansas 72758


Phone: 479.636.3545 Fax: 479.636.1209


Architect of Record

William Douglas Hurley Washington License No. 8855


Unified Business ID No. 602 491 668

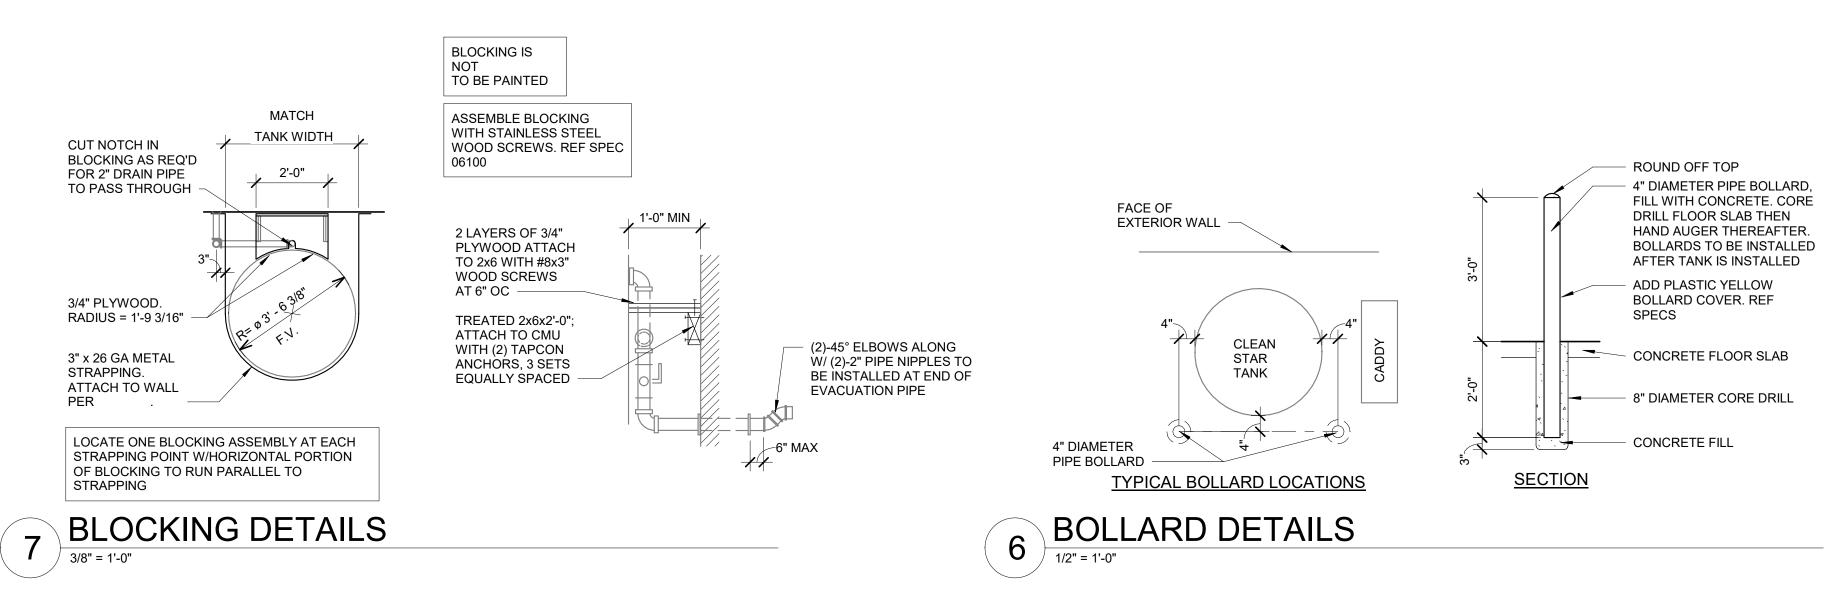


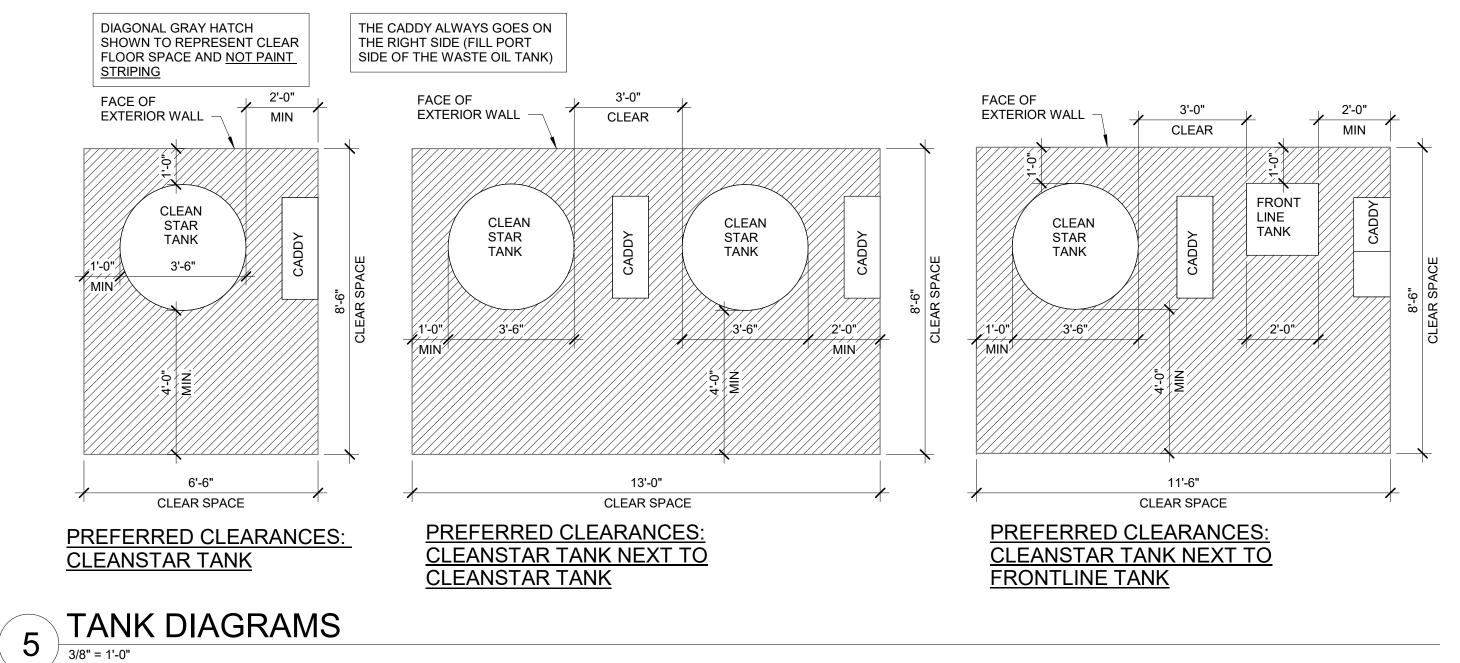

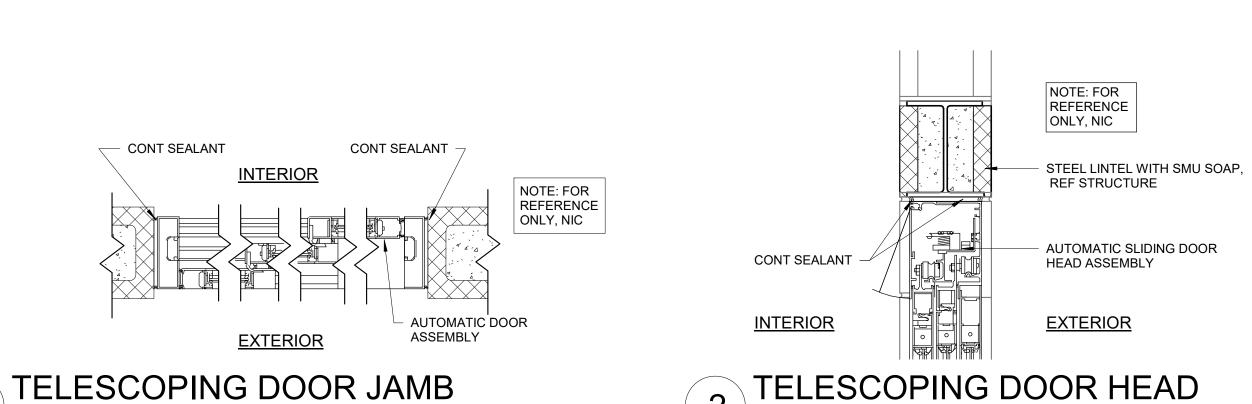

 $3)\frac{1}{1.1/2"} = 1'-0"$

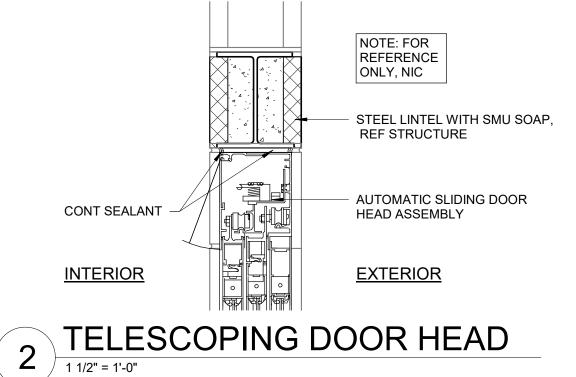

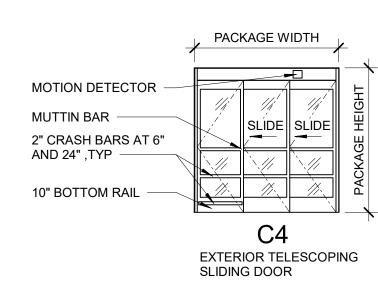

A3

DOCUMENTS THAT DO NOT

HAVE THE ARCHITECT OR


ENGINEER OF RECORD SEAL

AND SIGNATURE SHALL BE

DETAILS


CONSIDERED NOT FOR

CONSTRUCTION

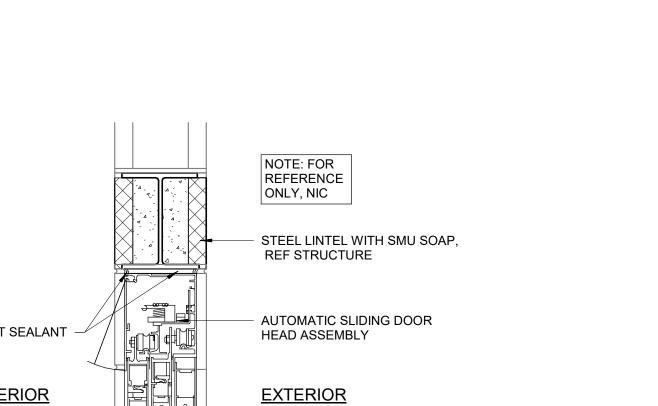

DOOR TYPES 3/16" = 1'-0"

A3 -PREFERRED VENT PIPING

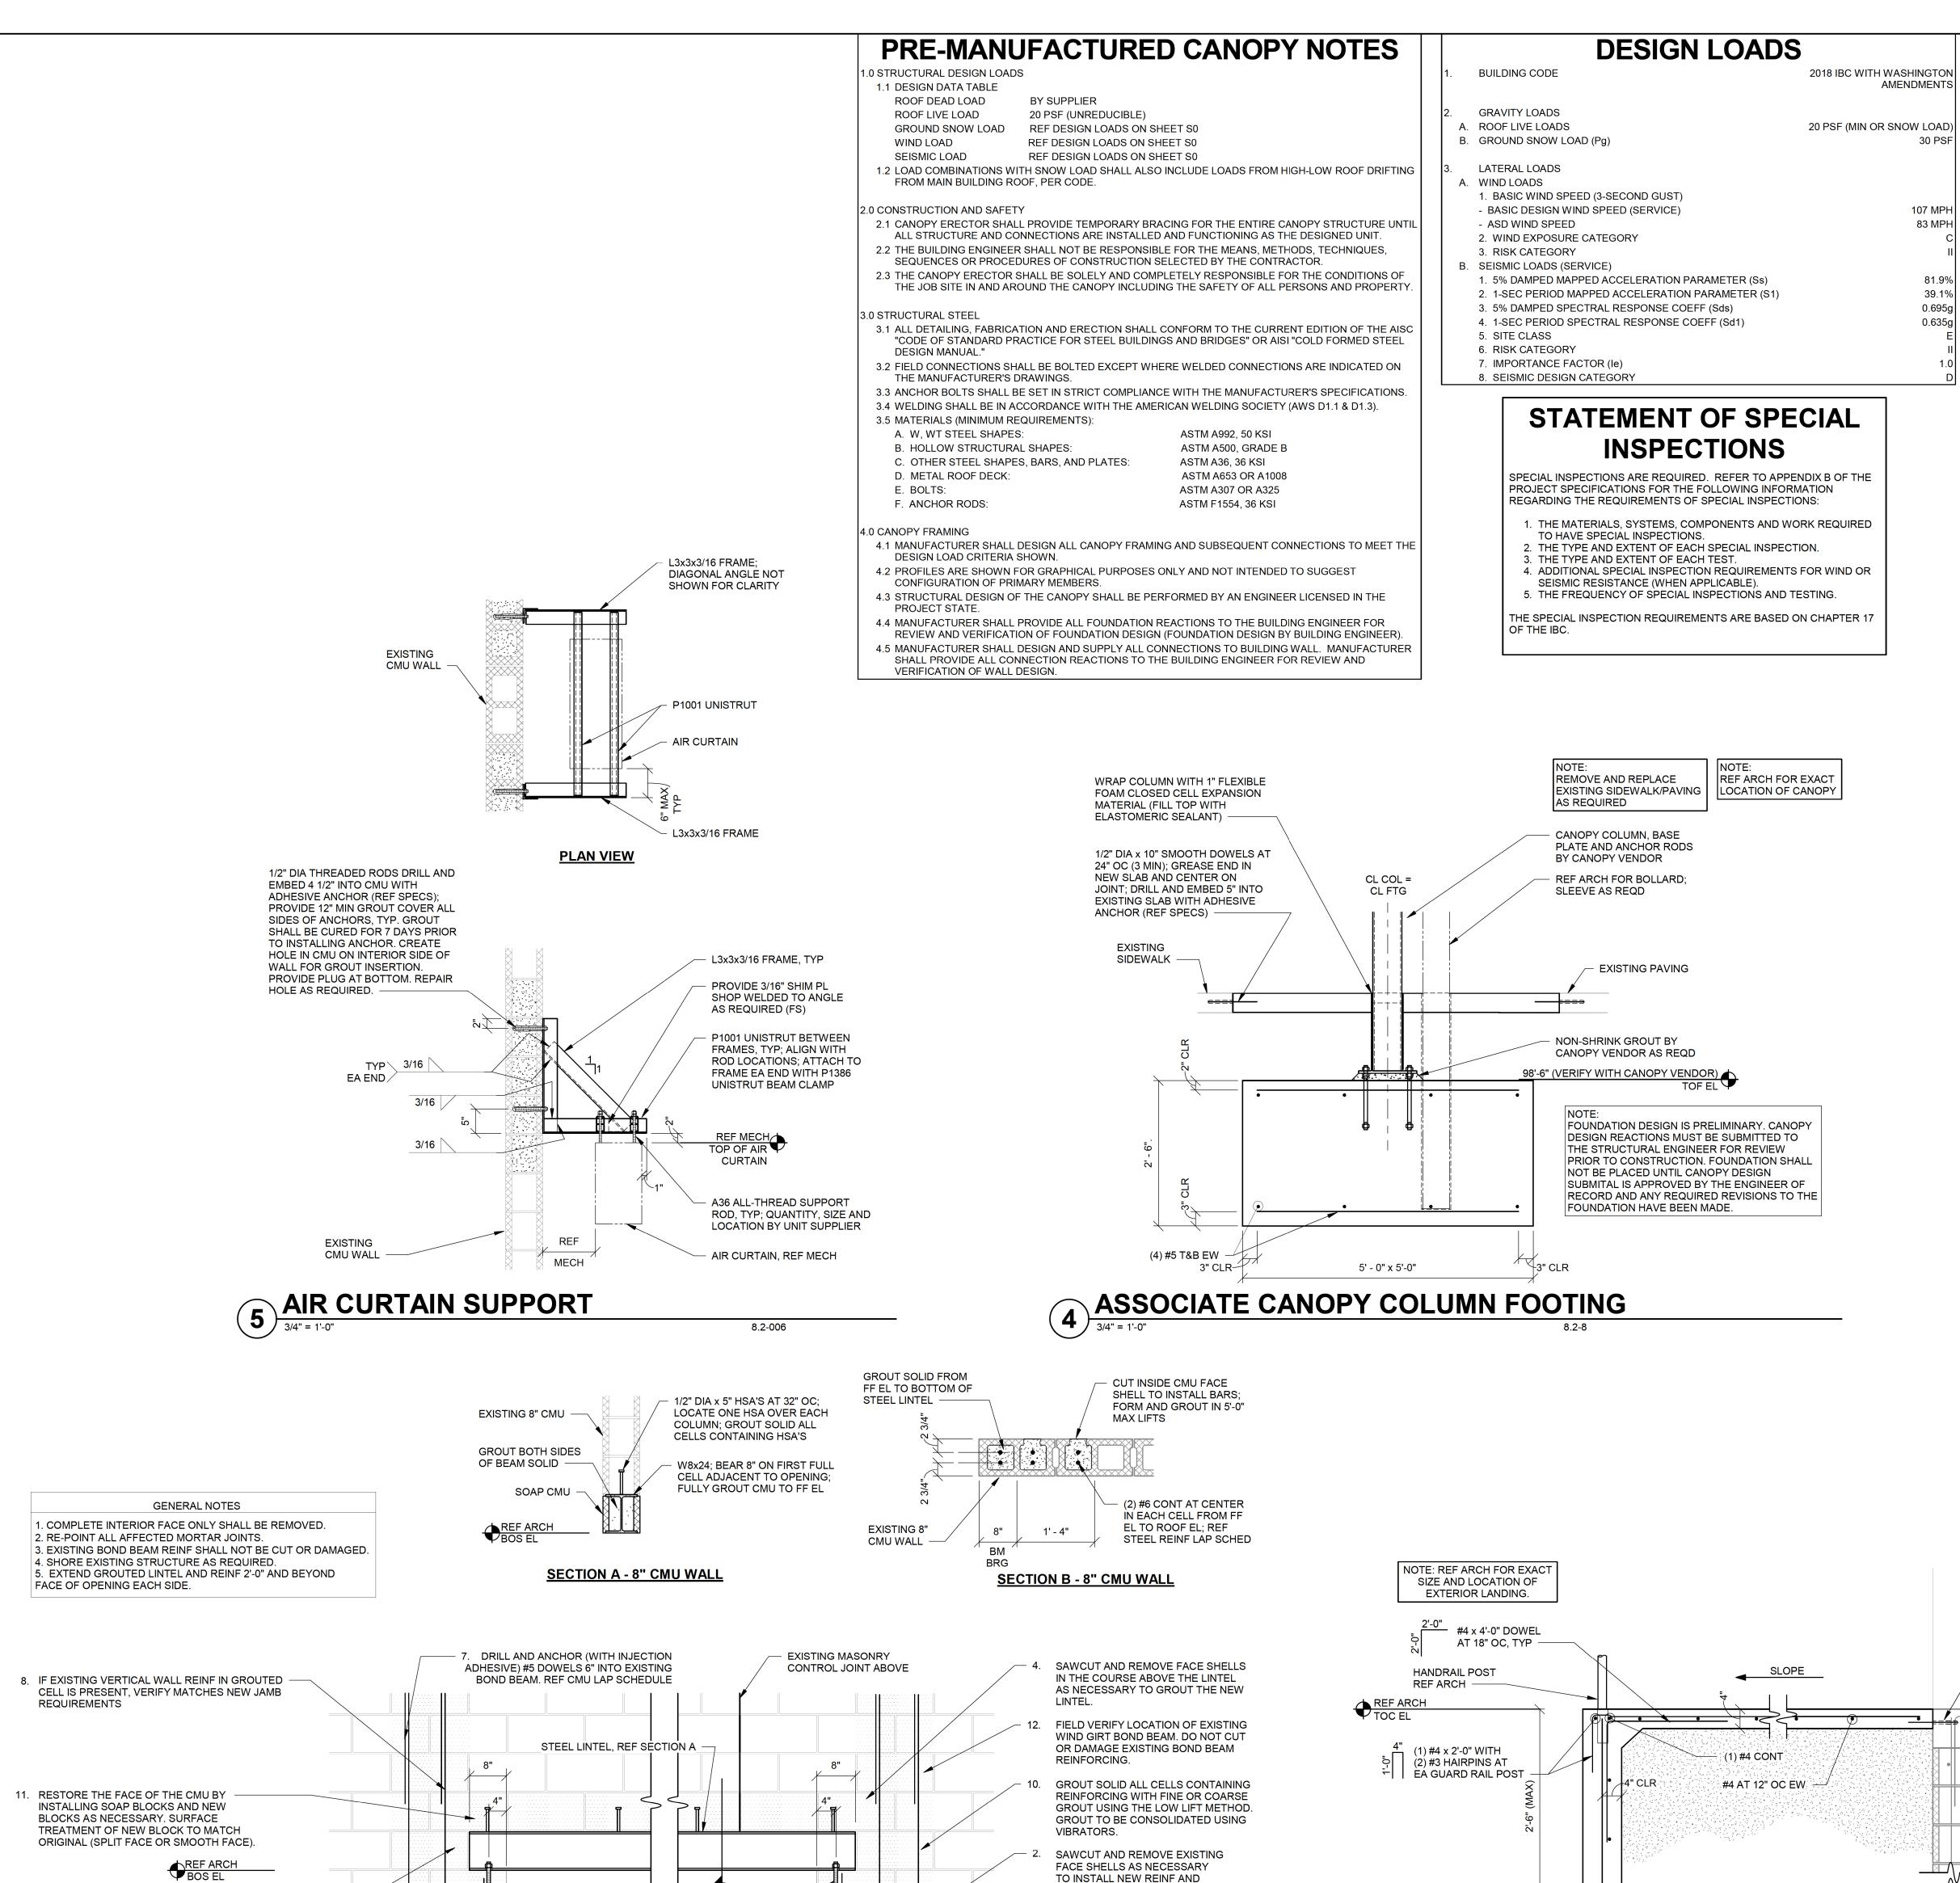

TO CLEAN OUT ALL VERTICAL

CLEAN OUT ALL CELLS TO RECEIVE NEW

LOOSE MORTAR AND MORTAR WHICH

REINF. REMOVE ALL DEBRIS, INSULATION,

OBSTRUCTS THE FLOW OF GROUT PRIOR TO INSTALLATION OF REINFORCEMENT.

(2) 3/4" DIA x 7" EMBED ABs

HOLES, TYP EA END -

(3" PROJ) IN SHORT SLOTTED

NEW CONCRETE SLAB

REF PLAN

REF CIVIL FINISHED GRADE

(3) #4 CONT

2 EXTERIOR LANDING
3/4" = 1'-0"

BÓTTOM -

9. REPLACE JAMB BLOCKS AND GROUT SOLID

WITH FINE OR COARSE GROUT. SURFACE TREATMENT OF NEW BLOCK TO MATCH

ORIGINAL (SPLIT FACE OR SMOOTH FACE)

DETAIL FOR SIZE AND REINFORCING. SPLICE

BARS IN 6'-0" TO 8'-0" LENGTHS. IF EXISTING

CELL IS PRESENT, THIS IS NOT REQUIRED.

6. INSTALL (2) #5 DOWELS IN EACH VERTICAL CELL

EMBED 6" INTO EXISTING CMU STEMWALL WITH INJECTION ADHESIVE. REF CMU LAP SCHEDULE -

3 STEEL LINTEL AT CMU OPENING IN EXISTING WALL

 SAWCUT AND REMOVE CMU WALL AS REQUIRED TO PROVIDE OPENING AND LINTEL. CONTRACTOR SHALL

PROVIDE SHORING PRIOR TO WALL

DEMOLITION.

VERTICAL WALL REINFORCEMENT IN GROUTED

5. INSTALL NEW REINFORCEMENT. REF JAMB

GENERAL NOTES

- 1. FURNISH ALL LABOR, MATERIALS AND EQUIPMENT NECESSARY TO COMPLETE THE WORK SHOWN OR IMPLIED BY THESE DRAWINGS. SHOP DRAWINGS SHALL BE SUBMITTED TO THE ARCHITECT AND ENGINEER FOR REVIEW AND APPROVAL PRIOR TO COMMENCING WORK. 2. EXISTING CONDITIONS SHOWN MAY NOT REFLECT EXACT "AS-BUILT" CONDITIONS. BIDDERS SHALL FIELD VERIFY EXISTING CONDITIONS PRIOR TO SUBMITTING FINAL BID. WITHIN
- ONE WEEK FROM THE START OF CONSTRUCTION DATE GENERAL CONTRACTOR SHALL FIELD VERIFY ALL EXISTING MATERIAL, MEASUREMENTS, AND ELEVATIONS AND SHALL NOTIFY THE ARCHITECT, STRUCTURAL ENGINEER OF RECORD AND THE OWNER'S CONSTRUCTION MANAGER OF ANY DISCREPANCIES OR FORESEEN PROBLEMS. GENERAL CONTRACTOR SHALL BE RESPONSIBLE FOR COORDINATING ALL FIELD MEASUREMENTS, EXISTING CONDITIONS, AND KNOWN COMPLICATIONS WITH THE MATERIAL SUPPLIERS. GENERAL CONTRACTOR SHALL CAREFULLY COORDINATE DEMOLITION AND NEW CONSTRUCTION WITH ALL OTHER DISCIPLINES AND EXISTING CONDITIONS.
- 4. GENERAL CONTRACTOR SHALL PROTECT EXISTING STRUCTURES, UTILITIES, PROPERTY, ETC DURING CONSTRUCTION. RESTORE ALL ITEMS DAMAGED, AS REQUIRED BY OWNER'S REPRESENTATIVE, TO THE OWNER'S SATISFACTION AT NO COST TO OWNER OR WITHOUT EXTENSION OF CONTRACT TIME. 5. BUILDING COMPONENTS ABANDONED BY THE SCOPE OF WORK SHALL BE SECURED TO PREVENT FALLING, LOOSENING OR CREATING DAMAGE OF ANY KIND IN THE FUTURE.
- 6. GENERAL CONTRACTOR IS RESPONSIBLE FOR PROVIDING TEMPORARY SUPPORT AND MAINTAINING STABILITY OF EXISTING STRUCTURE DURING ALL PHASES OF
- 7. BEFORE OR CONCURRENT WITH ANY EXCAVATIONS ADJACENT TO THE EXISTING BUILDING FOUNDATION OR SLAB. GENERAL CONTRACTOR IS RESPONSIBLE FOR PROVIDING
- TEMPORARY SUPPORT FOR THE BASE AND SUBGRADE OF THE EXISTING SLAB AND FOUNDATIONS TO PREVENT UNDERMINING. 8. GENERAL CONTRACTOR SHALL PROVIDE FIRE PROTECTION FOR THE EXISTING STRUCTURE AND BUILDING CONTENTS DURING WELDING OR ANY OTHER CONSTRUCTION
- 9. GENERAL CONTRACTOR SHALL COORDINATE THE SIZE AND LOCATION OF EQUIPMENT PADS AND PENETRATIONS THROUGH THE STRUCTURE FOR MECHANICAL, ELECTRICAL AND
- 1. FOOTING DESIGNS ARE BASED ON A NET ALLOWABLE SOIL BEARING PRESSURE OF 1500 PSF THE CONTRACTOR IS RESPONSIBLE FOR VERIFYING SOIL BEARING PRESSURE
- 2. EXTERIOR FOOTINGS SHALL BEAR AT OR BELOW MINIMUM BEARING DEPTH. MINIMUM BEARING DEPTH IS 24 INCHES BELOW ADJACENT FINISHED GRADE. THICKENED SLAB EDGES FOR STOOPS, CANOPIES, ETC. SHALL BE 16 INCHES (UNO).
- 3. STANDARD PROCEDURES OF FROST PROTECTION FOR FOUNDATIONS AND EXCAVATIONS SHALL BE EMPLOYED FOR WINTER CONSTRUCTION. BACKFILLING OF EXCAVATIONS SHALL BE DONE AS SOON AS POSSIBLE TO PROTECT FOUNDATIONS FROM FROST.
- CONCRETE AND REINFORCING STEEL 1. MINIMUM COMPRESSIVE STRENGTH (f'c) AT THE END OF 28 DAYS SHALL BE AS FOLLOWS:

ACTIVITY THAT GENERATES SPARKS OR INTENSE HEAT.

- SPECIFICATION SECTION 03314 A. INTERIOR CAST-IN-PLACE CONCRETE SLABS B. EXTERIOR CAST-IN-PLACE CONCRETE SLABS SPECIFICATION SECTION 03310 REF SPECS
- SPECIFICATION SECTION 03310 C. STRUCTURAL CAST-IN-PLACE CONCRETE FOOTINGS 3000 PSI
- D. STRUCTURAL FORMED CONCRETE WALLS REF SPECS SPECIFICATION SECTION 03310
- FOR ALL OTHER CONCRETE PROPERTIES REFER TO SPECIFICATIONS.

2. CONCRETE FREEZING AND THAWING EXPOSURE CLASS SHALL BE F2.

— EXISTING CMU

- 1/2" DIA x 10" SMOOTH DOWELS AT 24" OC

(3 MIN); GREASE END IN NEW SLAB AND

CENTER ON JOINT, DRILL AND EMBED 5"

INTO EXISTING SLAB WITH ADHESIVE

ANCHOR (REF SPECS)

BEYOND

#4 VERT AT 12" OC WITH HOOK

AT BOTTOM AS SHOWN

3" CLR

2' - 0"

- 3. REINFORCING STEEL SHALL MEET ASTM SPECIFICATION A 615, DEFORMED BAR, GRADE 60 OR ASTM SPECIFICATION A 706, DEFORMED BAR, GRADE 60. REF STEEL REINF LAP SCHEDULE FOR LAP LENGTHS, UNO ON DETAILS.
- 4. REFER TO ACI 315 FOR DETAILING PRACTICES AND FABRICATION, AND ACI 301 FOR STANDARD PRACTICE FOR MIXING AND PLACING CONCRETE AND CONCRETE COVER. 5. LEAN CONCRETE - MIN 2 1/2 SACKS PORTLAND CEMENT PER CUBIC YARD. STRUCTURAL STEEL
- 1. STRUCTURAL STEEL SHALL MEET THE FOLLOWING MINIMUM YIELD STRENGTH AND SPECIFICATIONS. FABRICATION AND ERECTION SHALL BE IN ACCORDANCE WITH THE LATEST EDITION OF THE "AISC CODE OF STANDARD PRACTICE".
- STRUCTURAL STEEL ASTM SPECIFICATION
- A. PLATES, CHANNELS, ANGLES, & ANCHOR BOLTS: 36 KSI A 36, UNO 50 KSI B. ROUND BARS FOR JOIST REINFORCEMENT: A 529
- 50 KSI A 992 C. WIDE FLANGE STEEL SHAPES: D. SQUARE AND RECTANGULAR HOLLOW STRUCTURAL SHAPES: A 500 GRADE C
- E. ROUND HOLLOW STRUCTURAL SHAPES: 46 KSI A 500 GRADE C
- F. HEADED STUD ANCHORS: 50 KSI A 108 (GRADE DESIGNATIONS 1010 TO 1020, INCLUSIVE) 2. ALL STRUCTURAL STEEL SHALL HAVE ONE SHOP COAT OF RUST INHIBITOR PRIMER PAINT CONFORMING TO THE SPECIFICATIONS. REF SPECS FOR PROTECTIVE FINISH FOR
- EXTERIOR STEEL. FIELD TOUCH UP ALL UNPAINTED, NICKED AND WELDED AREAS. PAINT ALL STEEL EXPOSED TO VIEW TO MATCH EXISTING. 3. WELDING SHALL MEET ANSI/AWS D1.1 STRUCTURAL WELDING CODE. ELECTRODES SHALL BE 70 KSI LOW HYDROGEN. 4. PROVIDE 1 1/2 INCH NON-SHRINK GROUT UNDER BASE PLATE AFTER ERECTION. NON-SHRINK GROUT, WHERE INDICATED ON PLANS, SHALL BE NON-METALLIC WITH A MINIMUM
- COMPRESSIVE STRENGTH OF 5,000 PSI AT 28 DAYS. 5. BOLTS FOR STEEL BEAM AND COLUMN CONNECTIONS SHALL BE 3/4" DIAMETER ASTM A 325-N HIGH-STRENGTH BOLTS, UNO. ALL BOLTED CONNECTIONS ARE BEARING TYPE. ALL BOLTS SHALL BE TIGHTENED SNUG TIGHT, UNO.
- 1. CONCRETE MASONRY UNITS SHALL MEET ASTM SPECIFICATION C 90. THE SPECIFIED DESIGN COMPRESSIVE STRENGTH OF CONCRETE MASONRY (f/m) SHALL BE 2000 PSI. THE NET AREA COMPRESSIVE STRENGTH OF THE CONCRETE MASONRY UNITS SHALL BE 2000 PSI.
- 2. MORTAR SHALL BE A PREBLENDED DRY MIX CONFORMING TO ASTM C 1714 AND MEETING THE PROPERY SPECIFICATIONS OF ASTM C 270 TYPE "S" MORTAR. REF SPECIFICATION 04200 FOR ADDITIONAL REQUIREMENTS.
- 3. GROUT SHALL MEET ASTM SPECIFICATION C 476 AND HAVE A MINIMUM 28 DAY COMPRESSIVE STRENGTH OF 2000 PSI. REF SPECIFICATION SECTION 04200 FOR ADDITIONAL REQUIREMENTS.
- 4. GROUT SHALL BE MECHANICALLY CONSOLIDATED USING A VIBRATOR WITH A MAXIMUM 3/4" DIAMETER HEAD. REF SPECIFICATION SECTION 04200.
- 5. WHERE NEW GROUT IS REQUIRED FOR CAST-IN-PLACE OR POST INSTALLED ANCHORS, PROVIDE 12" GROUT COVER ON ALL SIDES OF THE ANCHORS. CREATE A HOLE IN CMU ON INTERIOR SIDE OF WALL FOR GROUT INSERTION. PROVIDE PLUG AT BOTTOM. REPAIR HOLE AS REQUIRED.
- 6. HORIZONTAL JOINT REINFORCEMENT SHALL BE LADDER TYPE SPACED AT 16" OC VERTICALLY FOR THE ENTIRE HEIGHT OF THE WALL.
- 7. CONCRETE MASONRY SHALL BE LAID IN RUNNING (COMMON) BOND.
- 8. CONCRETE MASONRY BELOW FINISHED FLOOR SHALL BE NORMAL WEIGHT UNITS AND SHALL HAVE ALL CELLS FULLY GROUTED. CONCRETE MASONRY ABOVE FINISHED FLOOR SHALL BE LIGHT WEIGHT OR NORMAL WEIGHT AND SHALL BE GROUTED ONLY AT REINFORCED CELLS AND BOND BEAMS, UNO. 9. INSTALL EMBEDDED STEEL ITEMS FOR OVERHEAD DOORS IN GROUTED CELLS. COORDINATE LOCATIONS OF EMBEDDED ITEMS WITH OVERHEAD DOOR MANUFACTURER.
- POST-INSTALLED ANCHORS 1. POST-INSTALLED ANCHORS SHALL ONLY BE USED WHERE SPECIFIED ON THE DRAWINGS. CONTRACTOR SHALL OBTAIN APPROVAL FROM ENGINEER OF RECORD PRIOR TO USING
- POST-INSTALLED ANCHORS FOR MISSING OR MISPLACED CAST-IN-PLACE ANCHORS. REFER TO SPECIFICATION 05090 FOR ADDITIONAL INFORMATION. 2. WHERE THE DRAWINGS INDICATE GROUT TO BE ADDED TO MASONRY WALLS. 7 DAY CURED GROUT MUST BE PRESENT WHEN INSTALLING POST-INSTALLED ANCHORS.


STEEL REINF LAP SCHEDULE											
BAR SIZE	CONCRETE LAP SPLICE (CLASS B) (IN)										CMU
	f'c = 3,000psi		f'c = 3,500psi		f'c = 4,000psi		f'c = 4,500psi		f'c = 5,000psi		LAP SPLICE
	TOP	OTHER	TOP	OTHER	TOP	OTHER	TOP	OTHER	TOP	OTHER	(IN)
3	17	16	16	16	16	16	16	16	16	16	20
4	23	18	21	16	20	16	19	16	18	16	26
5	28	22	26	20	25	19	23	18	22	17	32
6	34	26	31	24	29	23	28	21	26	20	39
7	49	38	45	35	43	33	40	31	38	29	45
8	56	43	52	40	49	37	46	35	44	34	52

CHECKED BY: DRAWN BY: PROTO CYCLE: 09/24/2021 DOCUMENT DATE: 10/15/2021

0

SPECIAL PROJECT

ISSUE BLOCK

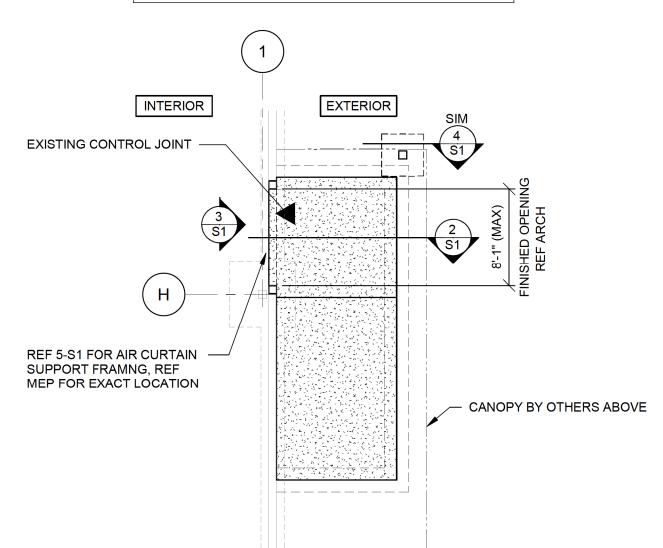

- COLUMN BY OTHERS

1. SHORE EXISTING STRUCTURE AS REQUIRED PRIOR TO

COMPLETE INTERIOR FACE ONLY SHALL BE REMOVED.

4. ALL WORK SHOWN IN THIS DETAIL SHALL BE DONE ON

5. IF A CMU CONTROL JOINT IS LOCATED WITHIN THE NEW

ENGINEER OF RECORD PRIOR TO CUTTING OF WALL.

MOISTURE, DUST, AND DEBRIS. INSTALL TEMPORARY DUST PARTITIONS AS REQUIRED TO PROHIBIT DUST FROM

THE EXISTING BUILDING SHALL BE PROTECTED FROM

ENTERING THE SALES AREA DURING DEMOLITION.


OPENING OR 2'-0" EITHER SIDE OF NEW OPENING. NOTIFY

INSIDE FACE OF WALL, UNLESS APPROVED BY

RE-POINT ALL AFFECTED MORTAR JOINTS

STARTING ANY NEW WORK.


ARCHITECT OF RECORD.

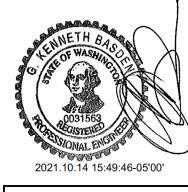

PLAN **GENERAL NOTES AND DETAILS**

FOUNDATION PLAN1/8" = 1'-0"

S1

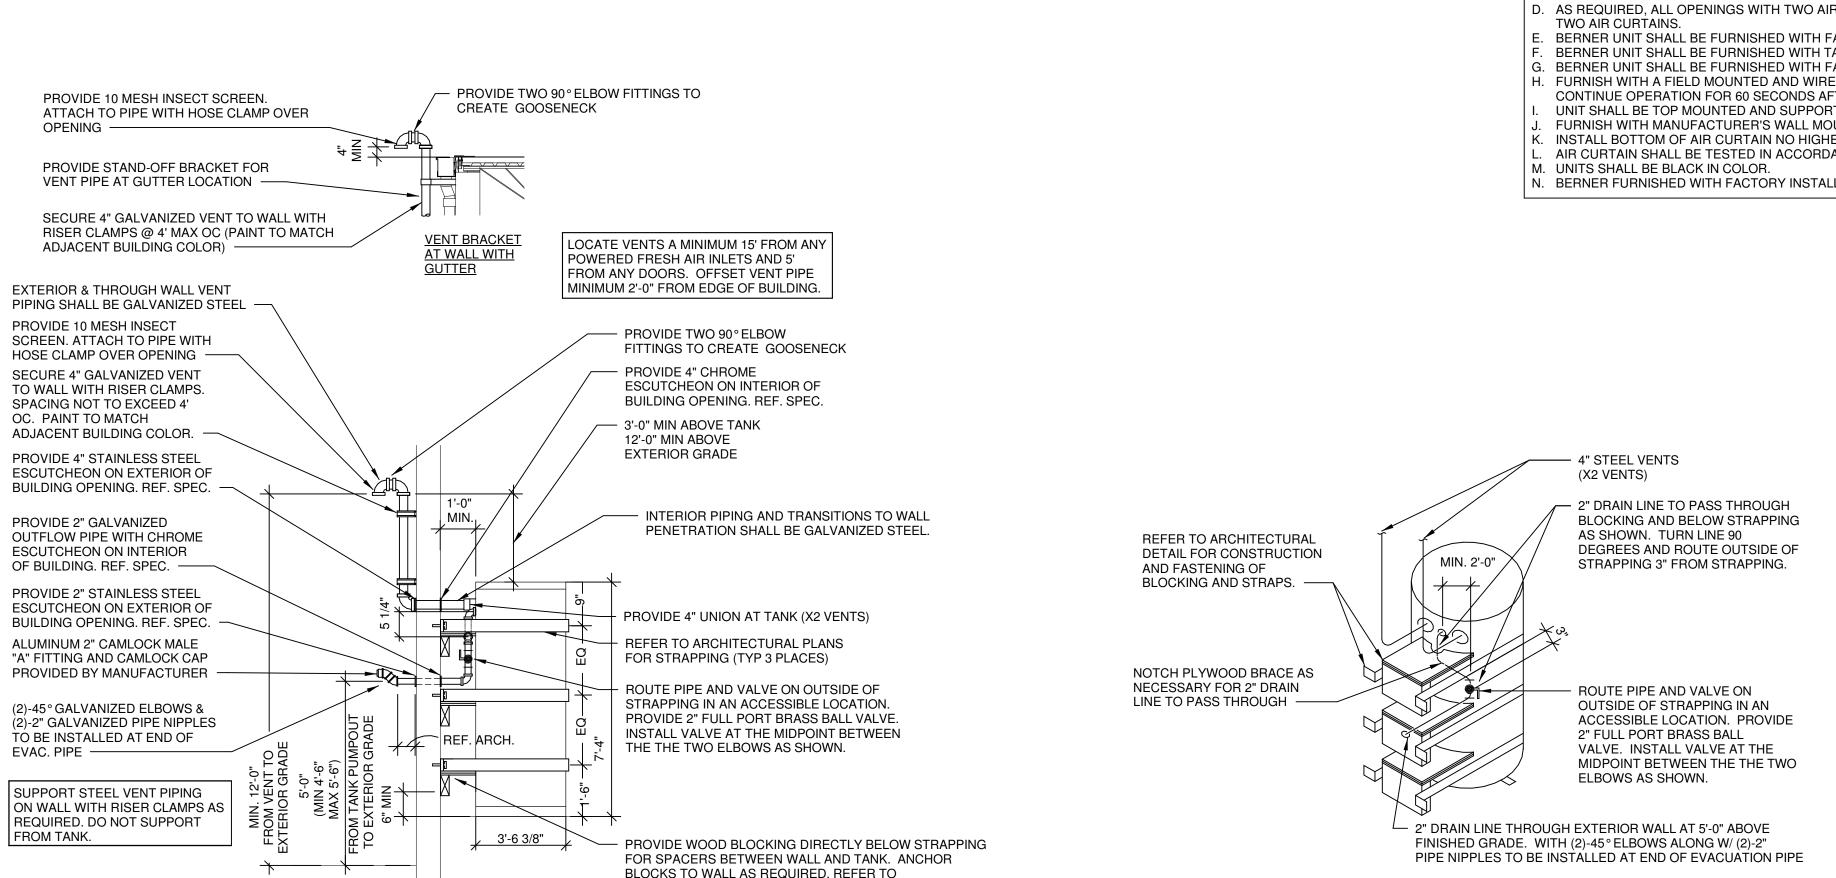

ARCHITECTURAL DETAIL FOR CONSTRUCTION.

X4" VENT

INSTALL OUTLET

PIPE CONNECTION

COMPACTOR PAD

WHERE APPLICABLE

LOCATION WITH THE STORE

MANAGER AND/OR WALMART

CONSTRUCTION MANAGER.

OUTSIDE

CONTRACTOR TO

COORDINATE FINAL

THROUGH

WALL WITH

GOOSENECK

WASTE COOKING OIL TANK VENTING DETAIL

1/8" = 1'-0"

DO NOT SUPPORT

TANK

VENT PIPING FROM

~ 2" EVACUATION

PORT 60"AFF

- FULL PORT BALL

VALVE IN RISER.

INSTALL LOAD OUT STATION

MP1

MP1

PUMP-OUT PIPING THROUGH

EXTERIOR WALL PER THE

LOCATE PUMP-OUT FITTING

ON THE OUTSIDE WALL AND COORDINATE THE LOCATION WITH STORE MANAGER AND/OR WALMART

CONSTRUCTION MANAGER.

RELOCATE EXISTING USED

EXISTING PIPING

(15.407)

RECEIVING PLUMBING PLAN

1/8" = 1'-0"

COOKING OIL TANK. DEMOLISH

PLUMBING WORK:

MANUFACTURER'S INSTRUCTIONS. FIELD

PREFERRED VENT PIPING

AIR CURTAIN SCHEDULE WEIGHT | FAN MOTORS | ELECTRICAL DATA **AREA** SERVED MANUFACTURER (LBS) HP VOLTS PH FLA MCA MOCP NOTES MARK **MODEL** OGP **BERNER** CHD10-1060A 0.75 1 8.0 10.0 POWERED AIRE ETA 1-60 GENERAL INFORMATION (ALL DEVICES): AIR CURTAINS FURNISHED AND INSTALLED BY CONTRACTOR. INSTALL BOTTOM OF WALL MOUNTED AIR CURTAIN AT ELEVATION INDICATED ON DRAWINGS UNLESS NOTED OTHERWISE. PROVIDE A DEDICATED ELECTRICAL CIRCUIT FOR EACH AIR CURTAIN WHEN MULTIPLE AIR CURTAINS ARE INSTALLED AT A SINGLE OPENING. . FURNISH WITH FACTORY MOUNTED NON-FUSED TOGGLE DISCONNECT SWITCH LOCATED ON TOP OF AIR CURTAIN. FURNISH WITH MANUFACTURER'S 120V PHOTOELECTRIC SENSOR SWITCH, SENSOR REFLECTOR, AND REQUIRED ACCESSORIES TO ENERGIZE ALL AIR CURTAINS AT EACH DOOR ON HIGH SPEED WHEN DOOR OPENS AND DE-ENERGIZE AIR CURTAINS WHEN DOOR CLOSES. . UNIT SHALL BE TOP MOUNTED. FOR CURTAIN INSTALLATIONS NOT DETAILED ON ARCHITECTURAL DRAWINGS, SUSPEND CURTAINS FROM UNISTRUT INSTALLED BELOW DOOR TRACK AND SPANNING ENTIRE DOOR OPENING AS REQUIRED. SUPPORT UNISTRUT FROM STRUCTURE. AS REQUIRED, ALL OPENINGS WITH TWO AIR CURTAINS TO BE FURNISHED WITH A FIELD MOUNTED AND WIRED RELAY TO ALLOW FOR ONE SWITCH TO ACTIVATE BERNER UNIT SHALL BE FURNISHED WITH FACTORY INSTALLED SINGLE PHASE CONTROL PANEL, LEFT END. BERNER UNIT SHALL BE FURNISHED WITH TANDEM PERFORMANCE KITS. i. BERNER UNIT SHALL BE FURNISHED WITH FACTORY INSTALLED INTELLISWITCH DIGITAL CONTROLLER. I. FURNISH WITH A FIELD MOUNTED AND WIRED 24V MAGNETIC LIMIT DOOR SWITCH AND TIME DELAY TO ENERGIZE AIR CURTAIN WHEN DOOR OPENS AND CONTINUE OPERATION FOR 60 SECONDS AFTER DOOR CLOSES. UNIT SHALL BE TOP MOUNTED AND SUPPORTED FROM STRUCTURE. REFERENCE MECHANICAL AND STRUCTURAL DRAWINGS FURNISH WITH MANUFACTURER'S WALL MOUNTING PLATE FOR INSTALLATION ABOVE DOOR OPENING WITH BOTTOM OF UNIT FLUSH WITH TOP OF DOOR. ... INSTALL BOTTOM OF AIR CURTAIN NO HIGHER THAN 8'-0" AFF. INSTALL PER MANUFACTURER'S INSTRUCTIONS. AIR CURTAIN SHALL BE TESTED IN ACCORDANCE WITH ANSI/AMCA 220. I. BERNER FURNISHED WITH FACTORY INSTALLED FAN SPEED CONTROL WITH TAMPER PROOF COVER.

15.407 REMOVE ALL EQUIPMENT, COMPONENTS, PIPING AND RETAINING HARDWARE SERVING DELI OR REPLACED. REF. ARCHITECTURAL. DELI WASTE OIL TANK'S PIPING COMPONENTS AND INSTALLATION HARDWARE SHALL BE REUSED

RECTANGULAR DUCT 18" WIDE > 18"x12" < BY 12" DEEP 12" DIAMETER ROUND DUCT - 12"Ø < SUPPLY DUCT IN SECTION RETURN OR EXHAUST DUCT IN SECTION **ELBOW WITH TURNING VANES** TEE WITH TURNING VANES ROUND (OR OVAL) ELBOW VOLUME/BALANCE DAMPER SUPPLY AIR DIFFUSER WITH ROUND SUPPLY DUCT WITH ROUND DUCT BRANCH DUCT AND/OR NECK SIZE 24"x24" CD DIFFUSER OR GRILLE TYPE 450 **THERMOSTAT** TIMER (S#) TEMP SENSOR CONNECT TO EXISTING EXISTING TO REMAIN

KEYNOTES

WASTE OIL TANK BEING RELOCATED, REMOVED WHENEVER POSSIBLE.

MECHANICAL SYMBOLS RETURN OR EXHAUST AIR DIFFUSER

TO OR MODIFIED, AND TO VERIFY THAT PROPER SLOPES AND ELEVATIONS ARE AVAILABLE. MAINTAIN

FIRE DAMPER

GENERAL NOTES ARE APPLICABLE TO ALL PLUMBING PROVIDE ALL MATERIALS FOR A COMPLETE INSTALLATION IN ALL RESPECTS AND READY FOR INTENDED USE AND IN STRICT ACCORDANCE WITH STATE AND LOCAL CODES AND MANUFACTURERS RECOMMENDATIONS. STORE MUST BE KEPT IN OPERATION. ARRANGE ALL WORK TO KEEP DISRUPTIONS TO STORE OPERATIONS TO A MINIMUM. COORDINATE WITH EXISTING AND NEW CONSTRUCTION. PAY ALL NECESSARY FEES AND PERMITS. IF NEW CONSTRUCTION DISRUPTS EXISTING UNDERGROUND SERVICES (GAS, SEWER, DOMESTIC WATER, FIRE SPRINKLER, ETC.), PROVIDE ALL MATERIALS AND LABOR AS REQUIRED TO MAINTAIN THEIR PROPER OPERATION. CONTRACTOR IS RESPONSIBLE FOR UTILIZING OWNER APPROVED ROOFING CONTRACTORS FOR CUTTING AND PATCHING ROOF. EXISTING PIPE SIZES AND LOCATIONS HAVE NOT BEEN FIELD VERIFIED. CONTRACTOR IS RESPONSIBLE TO FIELD VERIFY LOCATION AND SIZES OF ALL EXISTING PIPING THAT IS BEING CONNECTED

GENERAL NOTES

MINIMUM SLOPE OF 1/8" PER FOOT FOR SAN SEWER PIPING 3" OR LARGER. MAINTAIN MINIMUM SLOPE OF 1/4" PER FOOT FOR SAN SEWER PIPING SMALLER THAN 3". REF ARCH. FOR TRENCHING REQUIREMENTS. PLUMBING CONTRACTOR SHALL VERIFY EXISTING SEWER AND VENT PIPE SIZE AND ELEVATION AND SHALL VERIFY THAT PROPER SLOPES ARE AVAILABLE BEFORE CUTTING FLOOR SLAB FOR NEW SEWER PROVIDE ACCESS DOORS TO NEW WATER VALVES

+engineering

2809 Ajax Avenue Suite 100

Rogers Arkansas 72758

Phone: 479.636.3545

Fax: 479.636.1209

Engineer of Record

Joshua Dale McCall, P.E.

Washington License No. 53144

ĞŢ

SPECIAL PROJECT

ISSUE BLOCK

CHECKED BY:

PROTO CYCLE:

DOCUMENT DATE:10-15-2021

DRAWN BY:

AND CLEANOUTS AS NECESSARY WHEN INSTALLED IN INACCESSIBLE AREAS. PLUMBING CONTRACTOR SHALL PROVIDE ONE YEAR WARRANTY FOR PROPER SEWER SYSTEM

OPERATION.). SANITARY DRAINAGE LINES AND FITTINGS (DRAIN, WASTE AND VENT) SHALL BE CAST IRON, COATED

INSIDE AND OUTSIDE. WHERE PERMITTED BY LOCAL CODES, PVC-DWV PLASTIC SCHEDULE 40 MAY BE USED IN LIEU OF CAST IRON. ALL PHOTOLAB PLUMBING SHALL BE PVC. . WATER PIPING ABOVE GRADE SHALL BE TYPE "L" HARD DRAWN COPPER JOINED WITH WROUGHT

COPPER FITTINGS. MAKE JOINTS USING LEAD-FREE SOLDER AND A NON-CORROSIVE, PASTE-TYPE FLUX. MAKE PIPING CONNECTIONS TO A FIXTURE WITH CHROME-PLATED SEAMLESS BRASS TUBE. INSULATE HOT & COLD WATER PIPING WITH RIGID GLASS FIBER A MINIMUM OF 1/2" THICK WITH WHITE ALL-SERVICE JACKET (VAPOR RETARDER). 2. PROVIDE AUTOMATIC TRAP PRIMERS ON FLOOR

DRAINS IF REQUIRED BY LOCAL PLUMBING CODES. 13. ALL FLOOR CLEANOUTS SHALL BE INSTALLED FLUSH

WITH FLOOR FINISH MATERIAL OR FLUSH WITH CONCRETE SLAB IF NO FLOOR FINISH MATERIAL IS CALLED OUT FOR ON ARCHITECTURAL DRAWINGS. 14. LOCATE ALL FLOOR CLEAN-OUTS OUT OF TRAFFIC

WAYS, WHILE MAINTAINING ACCESSIBILITY. LOCATE PER DIMENSIONS IF SHOWN ON PLANS. 15. FLOOR CUTS SHALL BE STRAIGHT AND CLEAN. REPLACE REMOVED SLAB WITH CONCRETE FLUSH AND SMOOTH WITH ADJACENT FLOOR SLAB.

WITH GENERAL CONTRACTOR. 16. CAP ALL PIPING OPENINGS DURING CONSTRUCTION UNTIL FINAL CONNECTIONS TO EQUIPMENT AND

REFERENCE ARCHITECTURAL SHEETS. COORDINATE

ACCESSORIES ARE MADE. 17. CUT AND PATCH EXISTING CONCRETE FLOOR SLAB FOR INSTALLATION OF NEW UNDERGROUND

PLUMBING PIPE. MATCH EXISTING CONSTRUCTION. 18. DO NOT INSTALL PIPING WITHIN COOLER PANELS. INSTALL EXPOSED PIPING IN PREP AREAS A MINIMUM OF 1" FROM PANEL WALL AND 6" ABOVE FINISHED FLOOR TO ALLOW FOR CLEANING. USE ONLY NON-CORROSIVE MATERIALS FOR SPACERS AND

19. PROVIDE ESCUTCHEON PLATES FOR PLUMBING PENETRATIONS THROUGH GROCERY CEILINGS AND

ANCHORS.

20. PROVIDE AIR TIGHT SEAL AROUND PIPING PENETRATIONS THROUGH COOLER/FREEZER WALLS AND CEILINGS. FINISH WITH ESCUTCHEON PLATE.

21. PROVIDE HEAT TAPE AND INSULATION ON ALL WATER AND DRAIN PIPING EXPOSED TO FREEZING.

22. INSTALL CONTINUOUS SEALANT JOINT AT ALL EXTERIOR WALL PENETRATIONS.

23. AT CONTRACTOR'S OPTION (U.N.O), IN LIEU OF COPPER WATER PIPING, PEX OR AQUATHERM PIPING MAY BE USED. REFER TO EQUIVALENT NOMINAL PIPE SIZES SCHEDULE AND SPECIFICATIONS.


24. PROVIDE SEISMIC BRACING BASED ON APPROPRIATE SEISMIC ZONE REQUIREMENTS PER SMACNA PUBLISHED SEISMIC DETAILS, LOCAL AND NATIONAL CODES. CONTRACTOR'S RESPONSIBILITY INCLUDES STRUCTURAL ENGINEER'S CERTIFICATION ON DETAILS SUBMITTED FOR PERMITTING.

25. BUILDING COMPONENTS ABANDONED BY THE SCOPE OF WORK SHALL BE SECURED TO PREVENT FALLING, LOOSENING, OR CREATING DAMAGE OF ANY KIND IN THE FUTURE.

SEISMIC NOTES

REFER TO SEISMIC RESTRAINT SHEET SR1 FOR INSTALLATION DETAILS. REFER TO THE SPECIFICATIONS

FOR FURTHER INFORMATION.

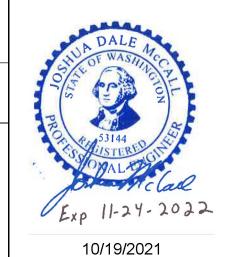

DOCUMENTS THAT DO NOT HAVE THE ARCHITECT OR ENGINEER OF RECORD SEAL

CONSTRUCTION **MECHANICAL**


AND SIGNATURE SHALL BE


CONSIDERED NOT FOR

PLUMBING PLANS

EXISTING CONDITIONS WERE TAKEN FROM ORIGINAL DRAWINGS AND MAY NOT REFLECT EXACT "AS-BUILT" CONDITIONS. CONTRACTOR SHALL FIELD VERIFY ALL EXISTING CONDITIONS PRIOR TO SUBMITTING FINAL BIDS. CONTRACTOR SHALL CAREFULLY COORDINATE NEW WORK AND DEMOLITION WITH ALL OTHER DISCIPLINES AND EXISTING CONDITIONS.

EACH SUBCONTRACTOR IS RESPONSIBLE FOR HAVING A THOROUGH KNOWLEDGE OF ALL DRAWINGS AND SPECIFICATIONS IN THEIR RELATED FIELD. THE FAILURE TO ACQUAINT THEMSELF WITH THIS KNOWLEDGE DOES NOT RELIEVE THE RESPONSIBILITY OF PERFORMING THE WORK PROPERLY. NO ADDITIONAL COMPENSATION SHALL BE ALLOWED BECAUSE OF CONDITIONS THAT OCCUR DUE TO FAILURE TO FAMILIARIZE WORKERS WITH THIS KNOWLEDGE.

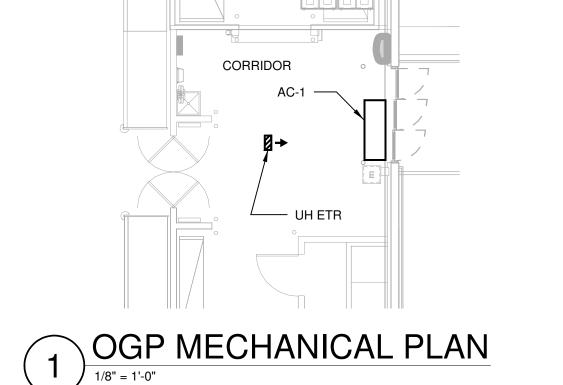

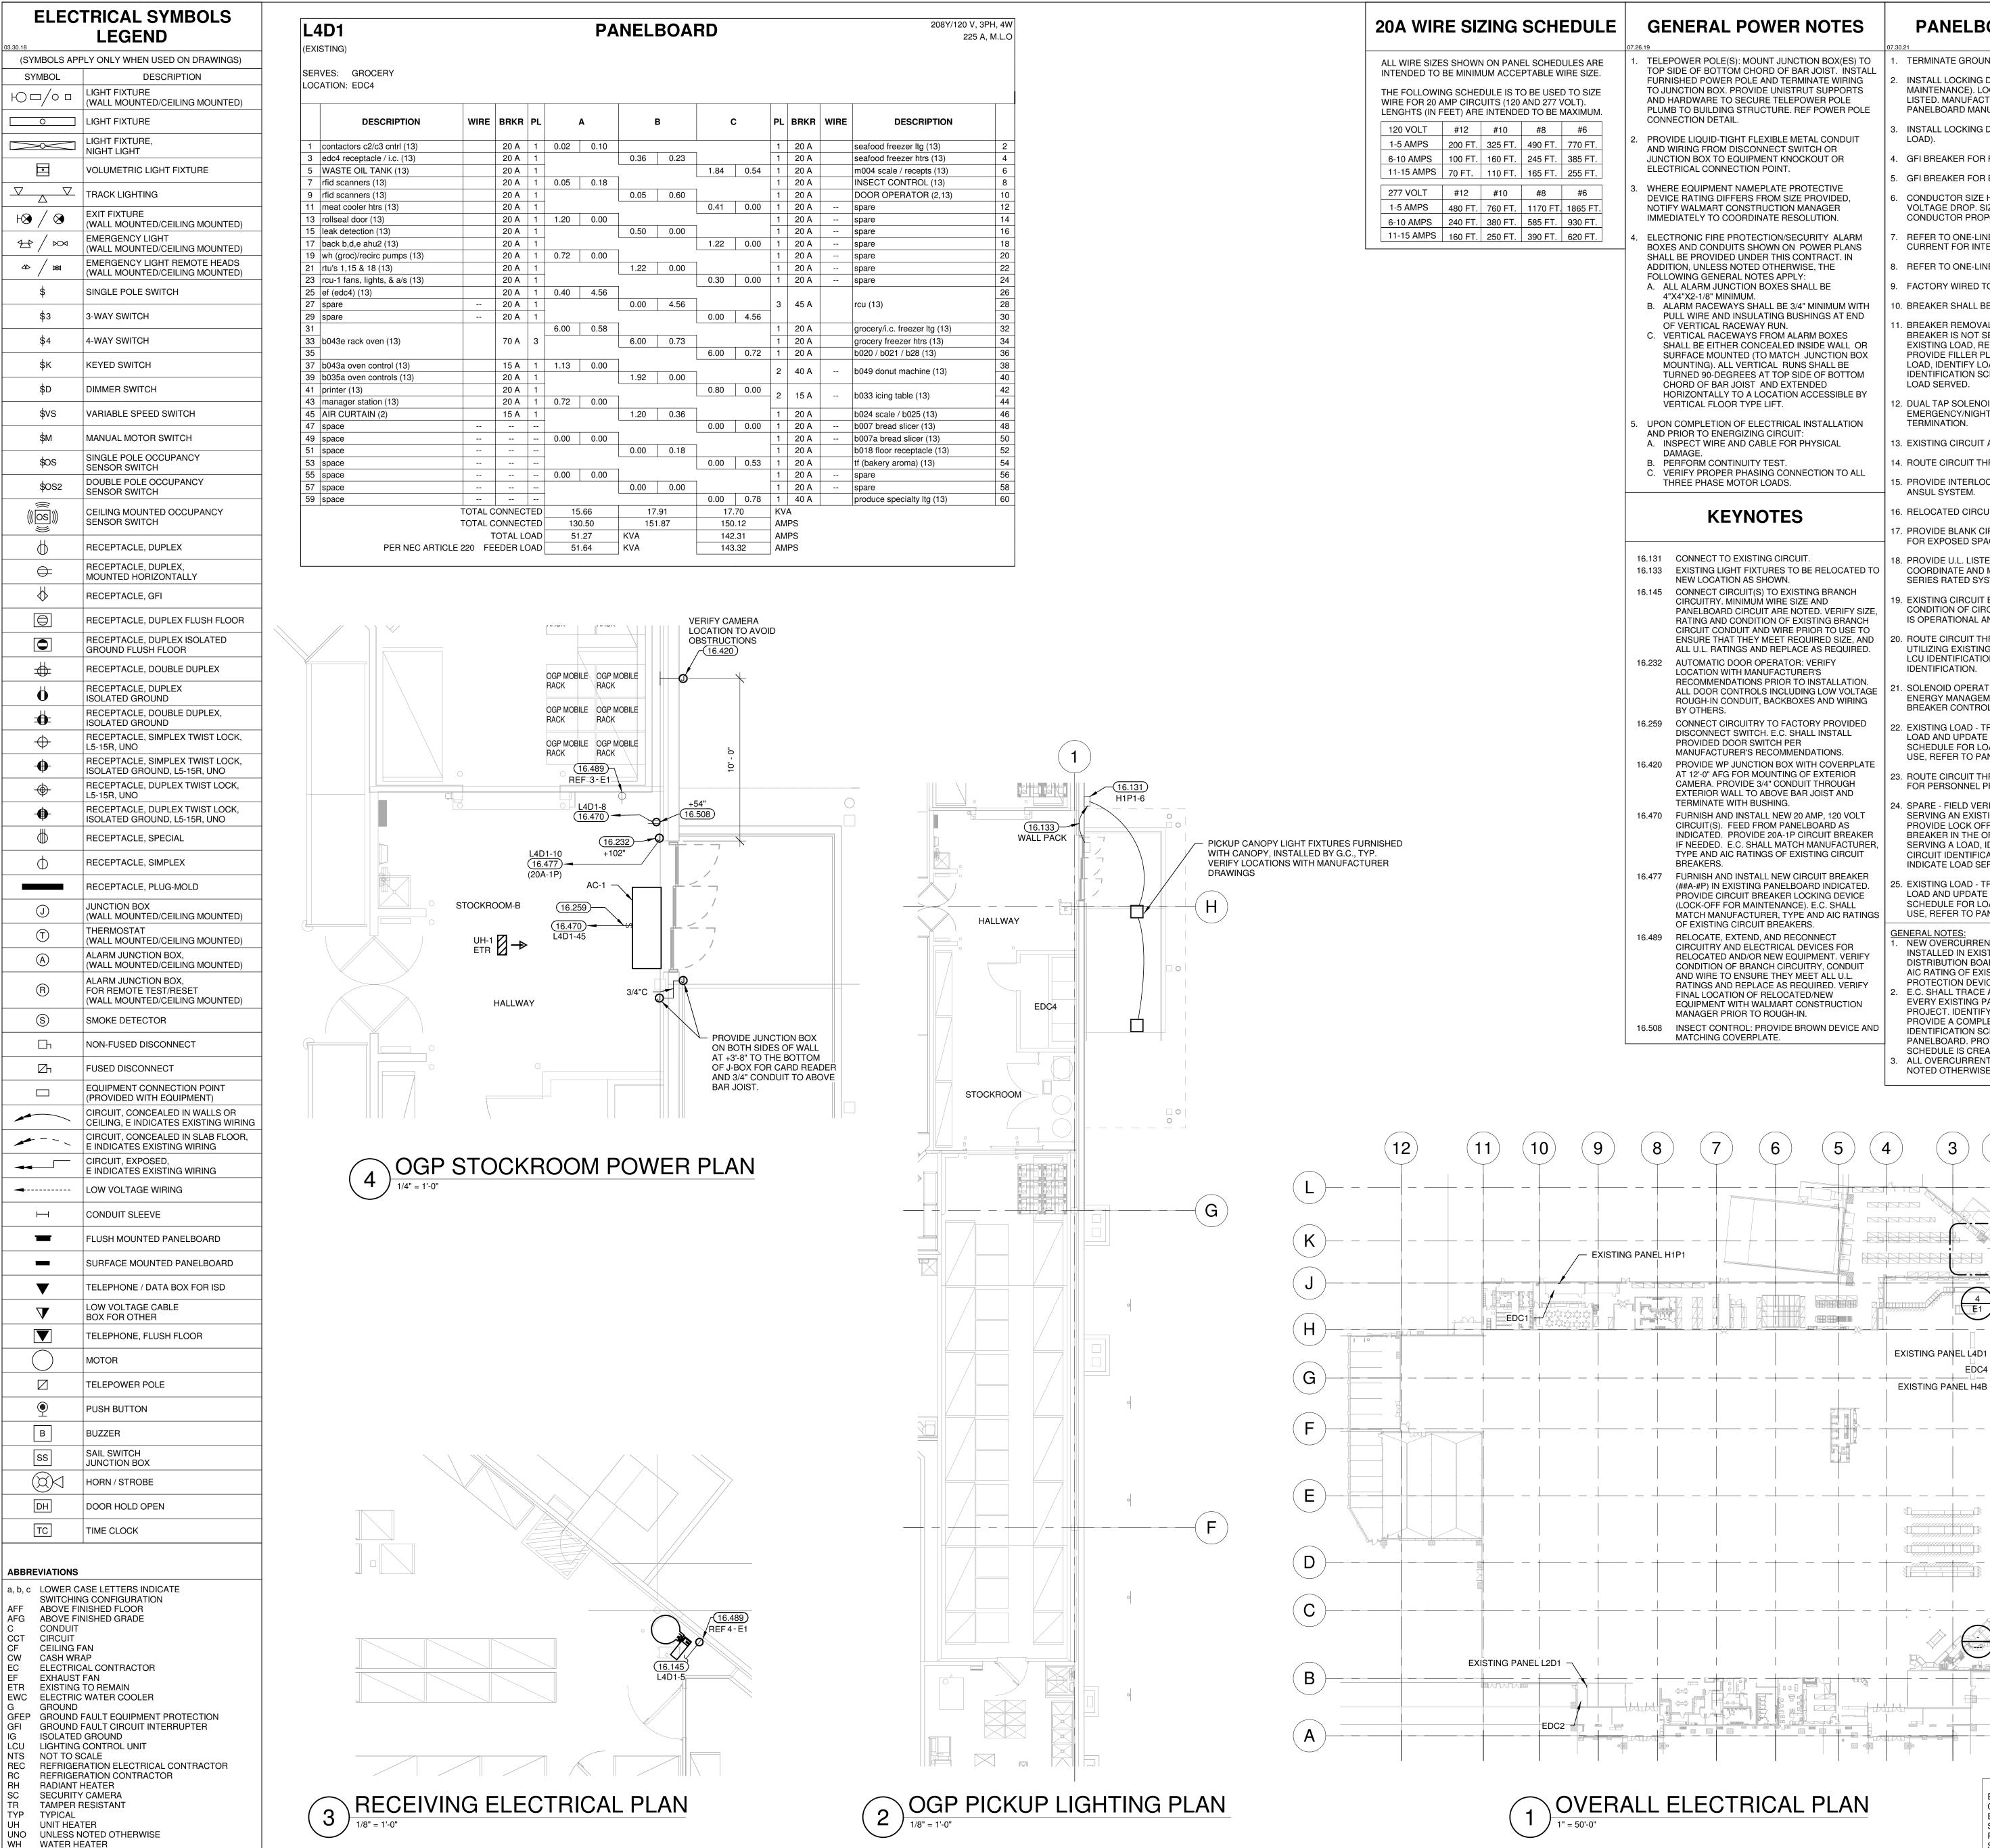

WP WEATHER PROOF

WR WEATHER RESISTANT

PANELBOARD NOTES ()

INSTALL LOCKING DEVICE (LOCK-ON FOR CRITICAL

GFI BREAKER FOR PERSONNEL PROTECTION (5MA)

GFI BREAKER FOR EQUIPMENT PROTECTION (30MA)

REFER TO ONE-LINE DIAGRAM FOR AVAILABLE FAULT

BREAKER IS NOT SERVING AN EXISTING LOAD. IF NO

IDENTIFICATION SCHEDULE AS "SPACE" OR INDICATE

. DUAL TAP SOLENOID OPERATED BREAKER. CONNECT

EMERGENCY/NIGHT LIGHTING TO UNSWITCHED

EXISTING LOAD, REMOVE CIRCUIT BREAKER AND

LOAD, IDENTIFY LOAD SERVED, UPDATE CIRCUIT

PROVIDE FILLER PLATE. IF BREAKER IS SERVING A

CONDUCTOR SIZE HAS BEEN INCREASED FOR

VOLTAGE DROP. SIZE EQUIPMENT GROUNDING

CONDUCTOR PROPORTIONATELY PER NEC.

CURRENT FOR INTERRUPT RATINGS.

BREAKER SHALL BE HIGH MAGNETIC TYPE.

BREAKER REMOVAL - FIELD VERIFY CIRCUIT

FACTORY WIRED TO LOAD.

LOAD SERVED.

TERMINATION.

PANELBOARD MANUFACTURER.

TERMINATE GROUND ON ISOLATED GROUND BUS. FURNISH AND INSTALL ALL MATERIALS, EQUIPMENT, AND LABOR, FOR A COMPLETE INSTALLATION IN ALL RESPECTS, READY FOR INSTALL LOCKING DEVICE (LOCK-OFF FOR INTENDED USE AND IN STRICT ACCORDANCE WITH NEC, NESC, MAINTENANCE). LOCKING DEVICE SHALL BE UL LISTED. MANUFACTURER SHALL MATCH EXISTING

STATE, AND LOCAL CODES, AND MANUFACTURER'S RECOMMENDATIONS. PAY ALL NECESSARY FEES AND PERMITS.

GENERAL NOTES

A. NO CIRCUITRY SHALL BE ALLOWED TO BE ROUTED ACROSS THE ROOF OR THE EXTERIOR SIDE OF THE EXTERIOR WALLS. B. ALL EQUIPMENT SHALL BE UL LISTED WHERE APPLICABLE.

CONSTRUCTION MANAGER AND STORE MANAGER. CONTRACTOR SHALL VERIFY ALL WALL FINISH THICKNESS

PROPERLY COVERED AND THAT ALL TRIM IS IN GOOD CONDITION, ALLOWING NO ACCESS TO LIVE PARTS.

REFER TO ONE-LINE DIAGRAMS FOR WIRE SIZES.

B. NEUTRALIZATION AREA: SEAL PER MECHANICAL DETAIL SEALANT.

SHALL BE SIZED PER NEC BASED ON THWN 600 VOLT COPPER SINGLE CONDUCTORS, PLUS THE EQUIPMENT GROUNDING

MASONRY:

3. EXISTING CIRCUIT AND/OR CIRCUIT BREAKER. 4. ROUTE CIRCUIT THROUGH CONTACTOR. B. RECEPTACLES +20'

C. VOICE/DATA +20"

5. PROVIDE INTERLOCK WIRING WITH EXHAUST HOOD ANSUL SYSTEM.

16. RELOCATED CIRCUIT FROM EXISTING PANELBOARD.

FOR EXPOSED SPACE IN PANELBOARD. 8. PROVIDE U.L. LISTED OVERCURRENT DEVICE TO COORDINATE AND MAINTAIN MANUFACTURER'S

IS OPERATIONAL AND MEETS ALL U.L. RATINGS.

. PROVIDE BLANK CIRCUIT BREAKER FILLER PLATE

SERIES RATED SYSTEM. EXISTING CIRCUIT BREAKER TO REMAIN. VERIFY CONDITION OF CIRCUIT BREAKER TO ENSURE THAT I

. ROUTE CIRCUIT THROUGH EXISTING LCU CABINET UTILIZING EXISTING RELAY AND CONTROLS. UPDATE LCU IDENTIFICATION SCHEDULE WITH LOAD IDENTIFICATION.

SOLENOID OPERATED CIRCUIT BREAKER. REFER TO ENERGY MANAGEMENT PLANS FOR CIRCUIT BREAKER CONTROL.

 EXISTING LOAD - TRACE EXISTING CIRCUIT, IDENTIFY LOAD AND UPDATE CIRCUIT IDENTIFICATION SCHEDULE FOR LOAD SERVED. IF CIRCUIT IS NOT IN USE, REFER TO PANELBOARD NOTE (11).

3. ROUTE CIRCUIT THROUGH ENCLOSED GFI BREAKER FOR PERSONNEL PROTECTION (5MA).

4. SPARE - FIELD VERIFY CIRCUIT BREAKER IS NOT SERVING AN EXISTING LOAD. IF NO EXISTING LOAD, PROVIDE LOCK OFF DEVICE TO LOCK SPARE BREAKER IN THE OFF POSITION. IF BREAKER IS SERVING A LOAD, IDENTIFY LOAD SERVED. UPDATE CIRCUIT IDENTIFICATION SCHEDULE AS "SPARE" OR INDICATE LOAD SERVED.

EXISTING LOAD - TRACE EXISTING CIRCUIT, IDENTIFY LOAD AND UPDATE CIRCUIT IDENTIFICATION SCHEDULE FOR LOAD SERVED. IF CIRCUIT IS NOT IN USE, REFER TO PANELBOARD NOTE (24).

NEW OVERCURRENT PROTECTIVE DEVICES INSTALLED IN EXISTING PANELBOARDS OR DISTRIBUTION BOARDS SHALL MATCH THE TYPE AND AIC RATING OF EXISTING OVERCURRENT PROTECTION DEVICES IN SAID BOARD.

E.C. SHALL TRACE ALL ELECTRICAL CIRCUITS FOR EVERY EXISTING PANELBOARD AFFECTED BY THIS PROJECT, IDENTIFY LOADS ON EACH CIRCUIT. PROVIDE A COMPLETE TYPEWRITTEN CIRCUIT IDENTIFICATION SCHEDULE FOR EVERY AFFECTED PANELBOARD. PROVIDE THE DATE THAT THE SCHEDULE IS CREATED.

ALL OVERCURRENT DEVICES ARE NEW UNLESS NOTED OTHERWISE.

EDC4 -

EXISTING CONDITIONS WERE TAKEN FROM

ORIGINAL DRAWINGS AND MAY NOT REFLECT

EXISTING PANEL H4B

2809 Ajax Avenue Suite 100 Rogers Arkansas 72758 . ARRANGE ALL WORK TO MINIMIZE DISRUPTIONS TO STORE Phone: 479.636.3545 OPERATIONS. COORDINATE ALL DISRUPTIONS WITH WALMART Fax: 479.636.1209 Engineer of Record Keith Allen Williams, P.E BEFORE INSTALLING BOXES. FURNISH AND INSTALL EXTENDED Washington License No. 43345

BOXES OR BOX EXTENDERS WHERE REQUIRED. CONTRACTOR SHALL VERIFY THAT ALL AFFECTED PANELBOARDS HAVE CIRCUIT BREAKER KNOCKOUTS

PROVIDE SEALS AT RACEWAY PENETRATIONS AS FOLLOWS: A. FIRE RATED WALLS: SEAL PER SPECIFICATIONS FOR FIRE

C. FREEZER/COOLER BOXES: SEAL WITH EXPANDING FOAM D. EXTERIOR: REFER TO ARCHITECTURAL DOCUMENTS FOR SEALING REQUIREMENTS AT ALL EXTERIOR MOUNTED DEVICES FIXTURES, ENCLOSURES, AND RACEWAY PENETRATIONS.

PROVIDE A SEPARATE EQUIPMENT GROUNDING CONDUCTOR (SIZE PER NEC) IN PVC TYPE CONDUIT, POWER AND LIGHTING CIRCUITS, ISOLATED GROUND CIRCUITS, OR AS SHOWN ON PLANS. CONDUIT CONDUCTOR.

WIRING DEVICES: DEVICE MOUNTING HEIGHTS ARE FROM FINISHED FLOOR TO CENTER OF OUTLET BOX UNLESS NOTED OTHERWISE ON PLANS. COORDINATE THE STANDARD MOUNTING HEIGHTS WITH A. SWITCHES +44"

WIRING SHALL INCLUDE FINAL CONNECTION TO ALL EQUIPMENT IN CONFORMANCE WITH EQUIPMENT SUPPLIER WIRING DIAGRAMS.

CONTRACTOR IS RESPONSIBLE FOR PROVIDING AN UPDATED AND COMPLETE TYPEWRITTEN CIRCUIT IDENTIFICATION SCHEDULE FOR EVERY PANELBOARD AFFECTED BY THIS PROJECT.

NEW OVERCURRENT PROTECTIVE DEVICES INSTALLED IN EXISTING PANELBOARDS OR DISTRIBUTION BOARDS SHALL MATCH THE TYPE AND AIC RATING OF EXISTING OVERCURRENT PROTECTIVE

BRANCH CIRCUIT CONDUCTORS SHALL BE MINIMUM #12 AWG UNLESS NOTED OTHERWISE IN SCHEDULES. WHERE 20A BRANCH CIRCUITS HAVE #8 AND LARGER WIRE SPECIFIED, #10 AWG WIRE SHALL BE USED FOR THE FINAL CONNECTION (15-FT MAXIMUM).

WHERE BRANCH CIRCUITS ARE GROUPED, SIZE CONDUIT AND DERATE CURRENT CARRYING CONDUCTORS PER NEC.

0. PROVIDE UL LISTED HANDLE TIES ON ALL MULTIWIRE BRANCH CIRCUITS PER NEC REQUIREMENTS.

SHALL BE MADE TO BRIDGING OR JOIST WEB MEMBERS. UTILIZE

. SUPPORTS FROM STRUCTURE: NO ATTACHMENT OF ANY TYPE

ONLY THE TOP AND BOTTOM CHORDS FOR SUPPORTING THE ELECTRICAL SYSTEM INSTALLATIONS. 12. DEVICES SHOWN ON COOLER/FREEZER PANELS SHALL BE SURFACE MOUNTED UNLESS NOTED OTHERWISE. SEAL DEVICES TO

COOLER/FREEZER PANELS WITH SILICONE SEALANT.

SURFACE MOUNTED CONDUIT ON COOLER/FREEZER PANELS OR IN FOOD PREP AREAS SHALL BE INSTALLED WITH GALVANIZED 1/2" STANDOFF CONDUIT HANGERS TO ALLOW FOR CLEANING. 4. ONLY FEEDER CIRCUITS NOTED ON THE ONE LINE DIAGRAM AND

SLAB. PROVIDE EXTERIOR COATED GRC BENDS ON ALL CONDUIT RUNS THAT HAVE 45 DEGREE BENDS OR GREATER. REFER TO SPECIFICATION SECTION 16.100 FOR UNDER SLAB. 5. SEISMIC ZONE REQUIREMENTS: PROVIDE EXPANSION COUPLINGS

BRANCH CIRCUITS NOTED BY LEGEND SHALL BE INSTALLED UNDER

AND BRACING FOR ELECTRICAL EQUIPMENT AS REQUIRED BY LOCAL CODES.

16. EXISTING ELECTRICAL AND ALARM: A. WHERE DEMOLITION OR NEW CONSTRUCTION INTERRUPTS EXISTING ELECTRICAL CIRCUITS FEEDING EXISTING EQUIPMENT

DEVICES, OR LIGHTING TO REMAIN, BUT NOT SHOWN ON DRAWINGS, PROVIDE LABOR AND MATERIALS TO REWORK CIRCUITRY, AS REQUIRED, TO MAINTAIN EXISTING OPERATION. B. IF DEMOLITION OR NEW CONSTRUCTION WILL DISRUPT EXISTING UNDERGROUND SERVICES (ELECTRICAL, TELEPHONE PARKING LOTLIGHTING CIRCUITRY, ETC.) PROVIDE ALL MATERIALS AND LABOR AS REQUIRED TO REROUTE, SLEEVE, OR OTHERWISE REWORK THESE SERVICES TO MAINTAIN THEIR EXISTING OPERATION. C. EXERCISE CAUTION AROUND ALARM AND SECURITY CABLES

DURING DEMOLITION AND CONSTRUCTION. PROTECT ALARM AND SECURITY CABLES FROM ACCIDENTAL DAMAGE SO THAT SYSTEMS REMAIN OPERATIONAL AT ALL TIMES. D. DISPOSE OF ALL REMOVED MATERIALS, UNLESS OTHERWISE

7. EXISTING ELECTRICAL DEMOLITION: A. GENERAL: REMOVE OR RELOCATE EXISTING ELECTRICAL EQUIPMENT, CONDUIT AND CONDUCTORS AS INDICATED ON THE DRAWINGS, OR ONLY AS REQUIRED BY DEMOLITION. REMOVE ALL PANELBOARDS, DISCONNECT SWITCHES, BOXES, RELAYS, TIME SWITCHES, LIGHTS, DEVICES, ETC., WHICH WILL NOT BE REUSED. SALES FLOOR: REMOVE UNUSED POWER DROP CONDUIT, CONDUCTORS AND RELATED DEVICES SERVING SALES AREA GONDOLAS BEING RELOCATED OR REMOVED. EXISTING CONDUIT AND CONDUCTORS MAY BE REUSED FOR NEW POWER DROPS WHERE SIZE, RATING, AND CONDITION MEET

REQUIREMENTS INDICATED ON PLANS AND ALL U.L. RATINGS REMOVE ALL UNUSED CONDUIT AND CONDUCTORS BACK TO POINT OF ORIGIN WHENEVER FEASIBLE. IF CIRCUIT IS NOT REUSED, REMOVE CIRCUIT BREAKER AND REPLACE WITH FILLER PLATE. EXCEPTION: DISTRIBUTION AND POWER SWITCH BREAKERS SHALL BE ETR AS "SPARE". PROVIDE HANDLE LOCK OFF DEVICE TO LOCK "SPARE" CIRCUIT BREAKER IN THE "OFF" POSITION. UPDATE TYPEWRITTEN CIRCUIT IDENTIFICATION SCHEDULE AS "SPACE" OR "SPARE" CONDUIT AND WIRING TO BE ABANDONED IN CEILING SPACES AND OTHER NON-PUBLIC AREAS (I.E., THROUGH STOCKROOM AREA): CUT WIRING LOOSE AND REMOVE FROM RACEWAY(S), LEAVING RACEWAY(S) IN PLACE. CONDUIT TO BE ABANDONED IN WALLS OR FLOORS SHALL BE REMOVED BACK TO FINISHED SURFACE AND CAPPED INSIDE. REPAIR SURFACE(S) TO MATCH

ADJACENT. ALL CIRCUIT BREAKERS SERVING BRANCH CIRCUITS TO BE REMOVED SHALL ALSO BE REMOVED. REMOVE CIRCUIT BREAKER AND REPLACE WITH FILLER PLATE. EXCEPTION: DISTRIBUTION AND POWER SWITCH BREAKERS SHALL BE ETR AS "SPARE". PROVIDE HANDLE LOCK OFF DEVICE TO LOCK "SPARE" CIRCUIT BREAKER IN THE "OFF" POSITION. UPDATE TYPEWRITTEN CIRCUIT IDENTIFICATION SCHEDULE AS "SPACE"

E. DEMOLISHED FLUORESCENT LIGHT FIXTURES: REFER TO SELECTIVE SITE DEMOLITION SPECIFICATION FOR DISPOSAL OF LIGHT FIXTURE. F. BUILDING COMPONENTS ABANDONED BY THE SCOPE OF WORK SHALL BE SECURED TO PREVENT FALLING, LOOSENING, OR CREATING DAMAGE OF ANY KIND IN THE FUTURE.

8. DATA AND PHONE CONDUIT INSTALLATION MILESTONE DATE ALL RACEWAY AND CONDUIT SLEEVES FOR DATA AND PHONE CABLING TO BE INSTALLED 3 WEEKS PRIOR TO CONTRACT SUBSTANTIAL COMPLETION DATE.


19. ETHERNET CABLE: A. FURNISH AND INSTALL JUNCTION BOXES AS SHOWN ON PLANS. PROVIDE CONDUIT AS REQUIRED BY LOCAL CODES AND/OR

ORDINANCES. B. ETHERNET CABLE IS FURNISHED BY OTHERS. C. ELECTRICAL CONTRACTOR SHALL INSTALL CABLE IN POWER

D. ELECTRICAL CONTRACTOR SHALL INSTALL OTHER CABLE AS DIRECTED BY WALMART CONSTRUCTION MANAGER.

EACH SUBCONTRACTOR IS RESPONSIBLE FOR HAVING A THOROUGH KNOWLEDGE OF ALL DRAWINGS AND SPECIFICATIONS IN THEIR RELATED FIELD. THE FAILURE EXACT "AS-BUILT" CONDITIONS. CONTRACTOR TO ACQUAINT THEMSELF WITH THIS KNOWLEDGE DOES NOT RELIEVE THE RESPONSIBILITY OF PERFORMING SHALL FIELD VERIFY ALL EXISTING CONDITIONS PRIOR TO SUBMITTING FINAL BIDS. CONTRACTOR THE WORK PROPERLY. NO ADDITIONAL SHALL CAREFULLY COORDINATE NEW WORK AND COMPENSATION SHALL BE ALLOWED BECAUSE OF DEMOLITION WITH ALL OTHER DISCIPLINES AND CONDITIONS THAT OCCUR DUE TO FAILURE TO EXISTING CONDITIONS. TYPICAL OF ALL ELECTRICAL | FAMILIARIZE WORKERS WITH THIS KNOWLEDGE.

TYPICAL OF ALL ELECTRICAL SHEETS.

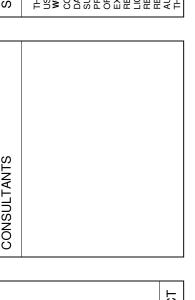


+engineering

GT Ō

ISSUE BLOCK

CHECKED BY: DRAWN BY: PROTO CYCLE: 09-24-2021 DOCUMENT DATE: 10-15-2021

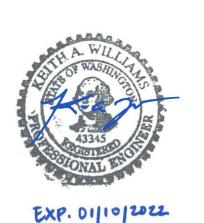

10/19/2021

DOCUMENTS THAT DO NOT HAVE THE ARCHITECT OR ENGINEER OF RECORD SEAL AND SIGNATURE SHALL BE CONSIDERED NOT FOR CONSTRUCTION

ELECTRICAL PLANS AND **SCHEDULES**

SHEET: E