

ATLAS PLUMBING SHOP

PRELIMINARY SITE PLAN REVIEW (TYPE II)

PORTION OF THE SOLOMON STRONG D.L.C. IN THE SW 1/4 OF SECTION 13, TOWNSHIP 5 NORTH, RANGE I WEST, W.M. COWLITZ COUNTY, WA
 PARCEL NO. 50739, 50740, AND 50741
 3.69 ACRES (159,865.2 SF)




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ABBREVIATIONS

A	AGENCY HAVING JURISDICTION	M	MAXIMUM
AHJ		MIN	MINIMUM
B	BUILDING	MPWSS	MT PUBLIC WORKS STANDARD SPECIFICATIONS
BVCE	BEGIN VERTICAL CURVE ELEVATION	N	NORTH
BVCS	BEGIN VERTICAL CURVE STATION	NT	NOT IN CONTRACT
C	CABLE TV	NTS	NOT TO SCALE
CATV		O	OPPOSITE
COS	CERTIFICATE OF SURVEY	OPP	OVERHEAD POWER
CI	CONSTRUCTION JOINT	P	POINT OF VERTICAL INTERSECTION
D	DETAIL	PVI	PROPERTY
DTL	DIAMETER	PROP	
DIA	DIMENSION	R	REFERENCE
DIM	DIVISION	REQ'D	REQUIRED
DWG	DRAWING	REV	REVISION
E	EAST	ROW	RIGHT-OF-WAY
EA	EDGE OF ASPHALT	S	SCHEDULE
ELEC	ELECTRIC	SCH	SIMILAR
ELEV	ELEVATION	SIM	SOUTH
EQ	EQUAL	SPEC	SPECIFICATION
EQUIP	EQUIPMENT	STD	STANDARD
EVCE	END VERTICAL CURVE ELEVATION	T	TYPICAL
EVCS	END VERTICAL CURVE STATION	TYP	TOP BACK OF CURB
EXIST	EXISTING	TBC	UNDERGROUND POWER
F	FIBER OPTIC	UT	UNDERGROUND TELEPHONE
FO		UNO	UNLESS NOTED OTHERWISE
G	GAS	V	VERTICAL
GI		VERT	
H	HEIGHT	W	WEST
HORIZ	HORIZONTAL	w/	WITH
HR	HOUR		
I	INTERNATIONAL BUILDING CODE		
IIBC			

VICINITY MAP



INDEX OF DRAWINGS

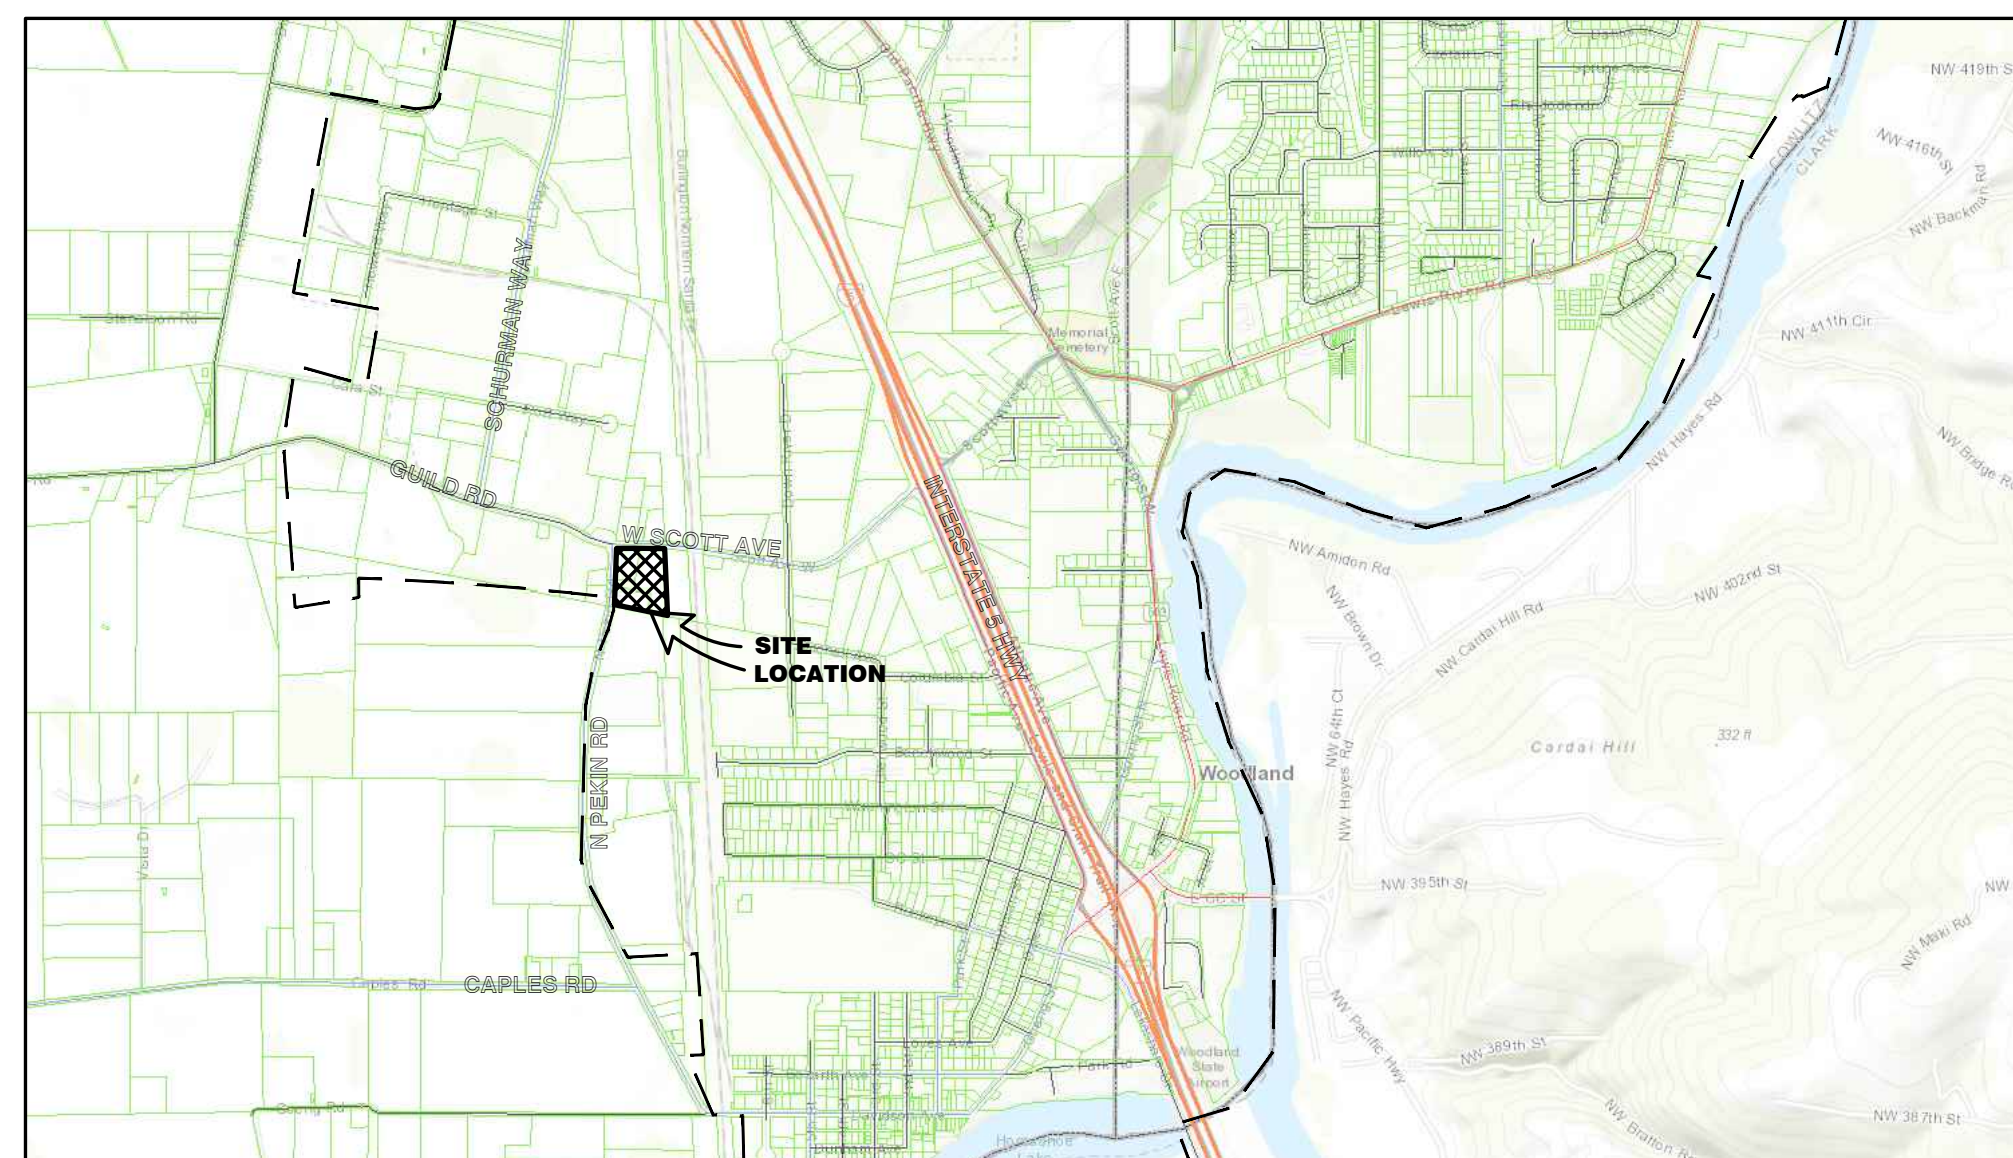SHEET #	SHEET TITLE	RELEASE DATE	LATEST REVISION
T0.00	TITLE SHEET	TBD	
C0.10	EXISTING SITE PLAN	TBD	
C0.20	SITE DEMO PLAN	TBD	
C0.30	EROSION CONTROL PLAN	TBD	
C0.40	NEW BOUNDARY LINE LAYOUT	TBD	
C1.10	SITE PLAN	TBD	
C1.20	SITE UTILITY PLAN	TBD	
C1.21	STORMWATER PLAN	TBD	
C1.30	SITE GRADING PLAN	TBD	
C1.40	SITE LANDSCAPING PLAN	TBD	
C1.41	SITE LANDSCAPING DETAIL	TBD	
C1.42	LANDSCAPING NOTES AND DETAILS	TBD	
C2.00	GENERAL NOTES AND DETAILS	TBD	
C2.10	DRY UTILITY NOTES AND DETAILS	TBD	
C2.20	WATER NOTES AND DETAILS	TBD	
C2.30	SEWER NOTES AND DETAILS	TBD	
C2.40	STORM NOTES AND DETAILS	TBD	
C2.50	EROSION CONTROL NOTES AND DETAILS	TBD	
E0.11	ELECTRICAL PHOTOMETRIC PLAN	TBD	

LEGEND

<ul style="list-style-type: none"> ■ PROPERTY FOUND AS NOTED ◆ ANGLE POINT AND/OR INTERSECTING POINT (NOT SET) ▲ TRAFFIC SIGN □ LIGHT POLE ○ UTILITY POLE ⊕ POWER POLE ⊞ TRANSFORMER ⊞ ELECTRIC METER ⊞ CABLE PEDESTAL ⊞ TELEPHONE PEDESTAL ○ GAS METER ○ BOLLARD ⊞ WATER METER PIT ⊞ WATER GATE VALVE ⊞ WATER CURB STOP ⊞ CAP ⊞ FIRE HYDRANT ⊞ YARD HYDRANT ⊞ WATER TEE ⊞ SANITARY SEWER CLEAN-OUT ⊞ SANITARY SEWER MANHOLE ⊞ STORM DRYWELL ⊞ STORM MANHOLE ⊞ STORM CATCH BASIN ⊞ STORM CURB INLET 3005.00(4) ■ EXISTING SPOT GRADE 3008.00 ■ PROPOSED SPOT GRADE (3007.50) ■ PROPOSED TOP BACK OF CURB GRADE 	<ul style="list-style-type: none"> — EXISTING FENCE (AS NOTED) — G — EXISTING GAS — (OHP) — EXISTING OVERHEAD POWER AND/OR TELEPHONE — (UP) — EXISTING UNDERGROUND POWER — (UT) — EXISTING UNDERGROUND PHONE OR CABLE — EXISTING WATER LINE — (SS) — EXISTING SANITARY SEWER MAIN — (SD) — EXISTING STORM DRAIN — 92 — EXISTING CONTOUR — — PROPERTY LINE
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GENERAL INFORMATION

APPLICANT:
 428 PEKIN, LLC
 428 PEKIN ROAD, WOODLAND, WA 98674
 SARAH@ATLASPLUMBINGCONTRACTORS.COM
 360-887-8054

OWNER:
 428 PEKIN, LLC
 428 PEKIN ROAD, WOODLAND, WA 98674
 SARAH@ATLASPLUMBINGCONTRACTORS.COM
 360-887-8054

CONTACT:
 SAM DUGUAY
 JACKOLA ENGINEERING AND ARCHITECTURE
 702 JEFFERSON STREET, VANCOUVER, WA 98660
 SDUGUAY@JACKOLA.COM
 360-852-8746

ATLAS PLUMBING SHOP
 428 NORTH PEKIN ROAD
 WOODLAND, WA 98674

DRAWN: EMS CHECKED: SLD

DATE: 01/07/2021

REVISIONS:

TITLE SHEET

T0.00

PROJECT #: 200810

GENERAL NOTES:
1. SURVEY PERFORMED BY OTHERS.



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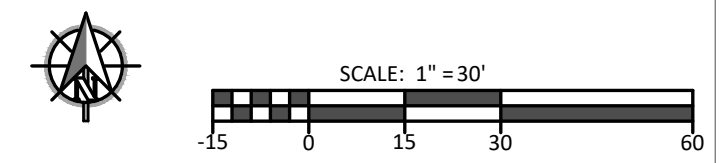
REVISIONS:

EXISTING SITE LAYOUT

C0.10



1 EXISTING SITE LAYOUT
1" = 30'



PROJECT #: 200810
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KEYNOTES:
 1. KEYNOTE ABOUT SITE ITEMS.
GENERAL NOTES:
 1. GENERAL NOTE ABOUT THE SITE.



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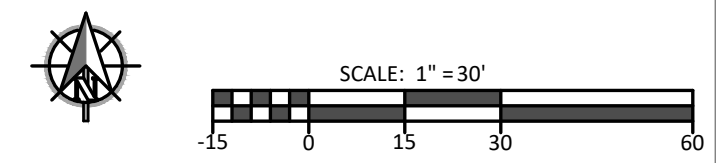
REVISIONS:

SITE DEMO PLAN

C0.20

PROJECT #: 200810
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1 SITE DEMO PLAN
 1" = 30'



GENERAL NOTES:
 1. 3-FOOT DEDICATION OF PROPERTY TO MEET 33-FOOT HALF-WIDTH ROW.



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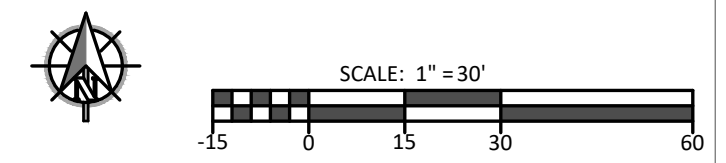
REVISIONS:

NEW BOUNDARY LINE LAYOUT

C0.40



1 NEW BOUNDARY LINE LAYOUT
 1" = 30'



PROJECT #: 200810 F:\client\2020\atlas plumbing\200810 preliminary\atlas_plumbing\atlas_plumbing_C0.40.dwg




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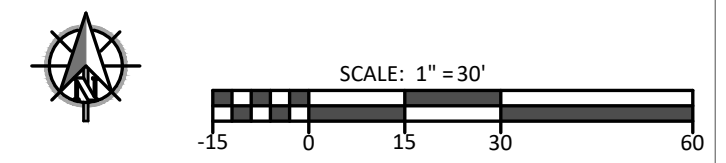
LOT SUMMARY:
 ZONING: I-2 - HEAVY INDUSTRIAL DISTRICT
 BUILDING SETBACKS:
 FRONT - 30 FT
 SIDE CORNER - 30 FT
 SIDE - 10 FT
 REAR - 10 FT
 LANDSCAPING REQUIRED:
 MIN 10% OF ENTIRE SITE -
 LOT AREA = 128,618 SF
 LANDSCAPED AREA = 14,524 = 11%
 MIN 10% OF PARKING AREA -
 PARKING AREA = 13,640 SF
 LANDSCAPED AREA = 1,372 SF = 10%
 SEE THE C1.40 SHEETS FOR AREAS

PARKING SUMMARY:
 PARKING REQUIRED:
 EMPLOYEE PARKING - 20 STALLS
 VISITOR PARKING - 5 STALLS
 TOTAL REQUIRED - 25 STALLS
 PARKING PROVIDED:
 FRONT PARKING LOT - 22 STALLS
 REAR PARKING LOT - 13 STALLS
 TOTAL PARKING PROVIDED - 35 STALLS
 ADA PARKING REQUIRED - 2 STALLS
 ADA PARKING PROVIDED - 2 STALLS

- KEYNOTES:**
1. PAVEMENT SECTION PER DTL.
 2. GRAVEL SECTION PER DTL.
 3. SIDEWALK PER DTL.
 4. CURB AND GUTTER PER DTL.
 5. EXTEND STAND-UP/LANDSCAPE CURB TO SIDEWALK. MATCH EXISTING STYLE.
 6. CONCRETE APRON, REFER TO STRUCTURAL DRAWINGS.
 7. DRIVEWAY APPROACH PER DTL.
 8. ADA RAMP PER DTL.
 9. STRIPING PER DTL.
 10. 6' SLATTED CHAIN-LINK FENCE PER DTL.
 11. AUTOMATIC ROLLER GATE PER DTL.
 12. 22' X 7.5' ROLL-OFF DUMPSTER
 13. ADA PARKING SIGN PER DTL.
 14. 12" BY 12" LIT MONUMENT SIGN AT NORTHWEST CORNER OF SITE (DESIGN BY OTHERS).
 15. COORDINATE WITH CLARK COUNTY FIRE AND RESCUE (CCFR) FOR INSTALLATION OF KNOX BOX ON ACCESS GATES.
 16. 28" WIDE ACCESS INGRESS AND EGRESS.
 17. 40" WIDE ACCESS EGRESS ONLY.



1 SITE PLAN
 1" = 30'

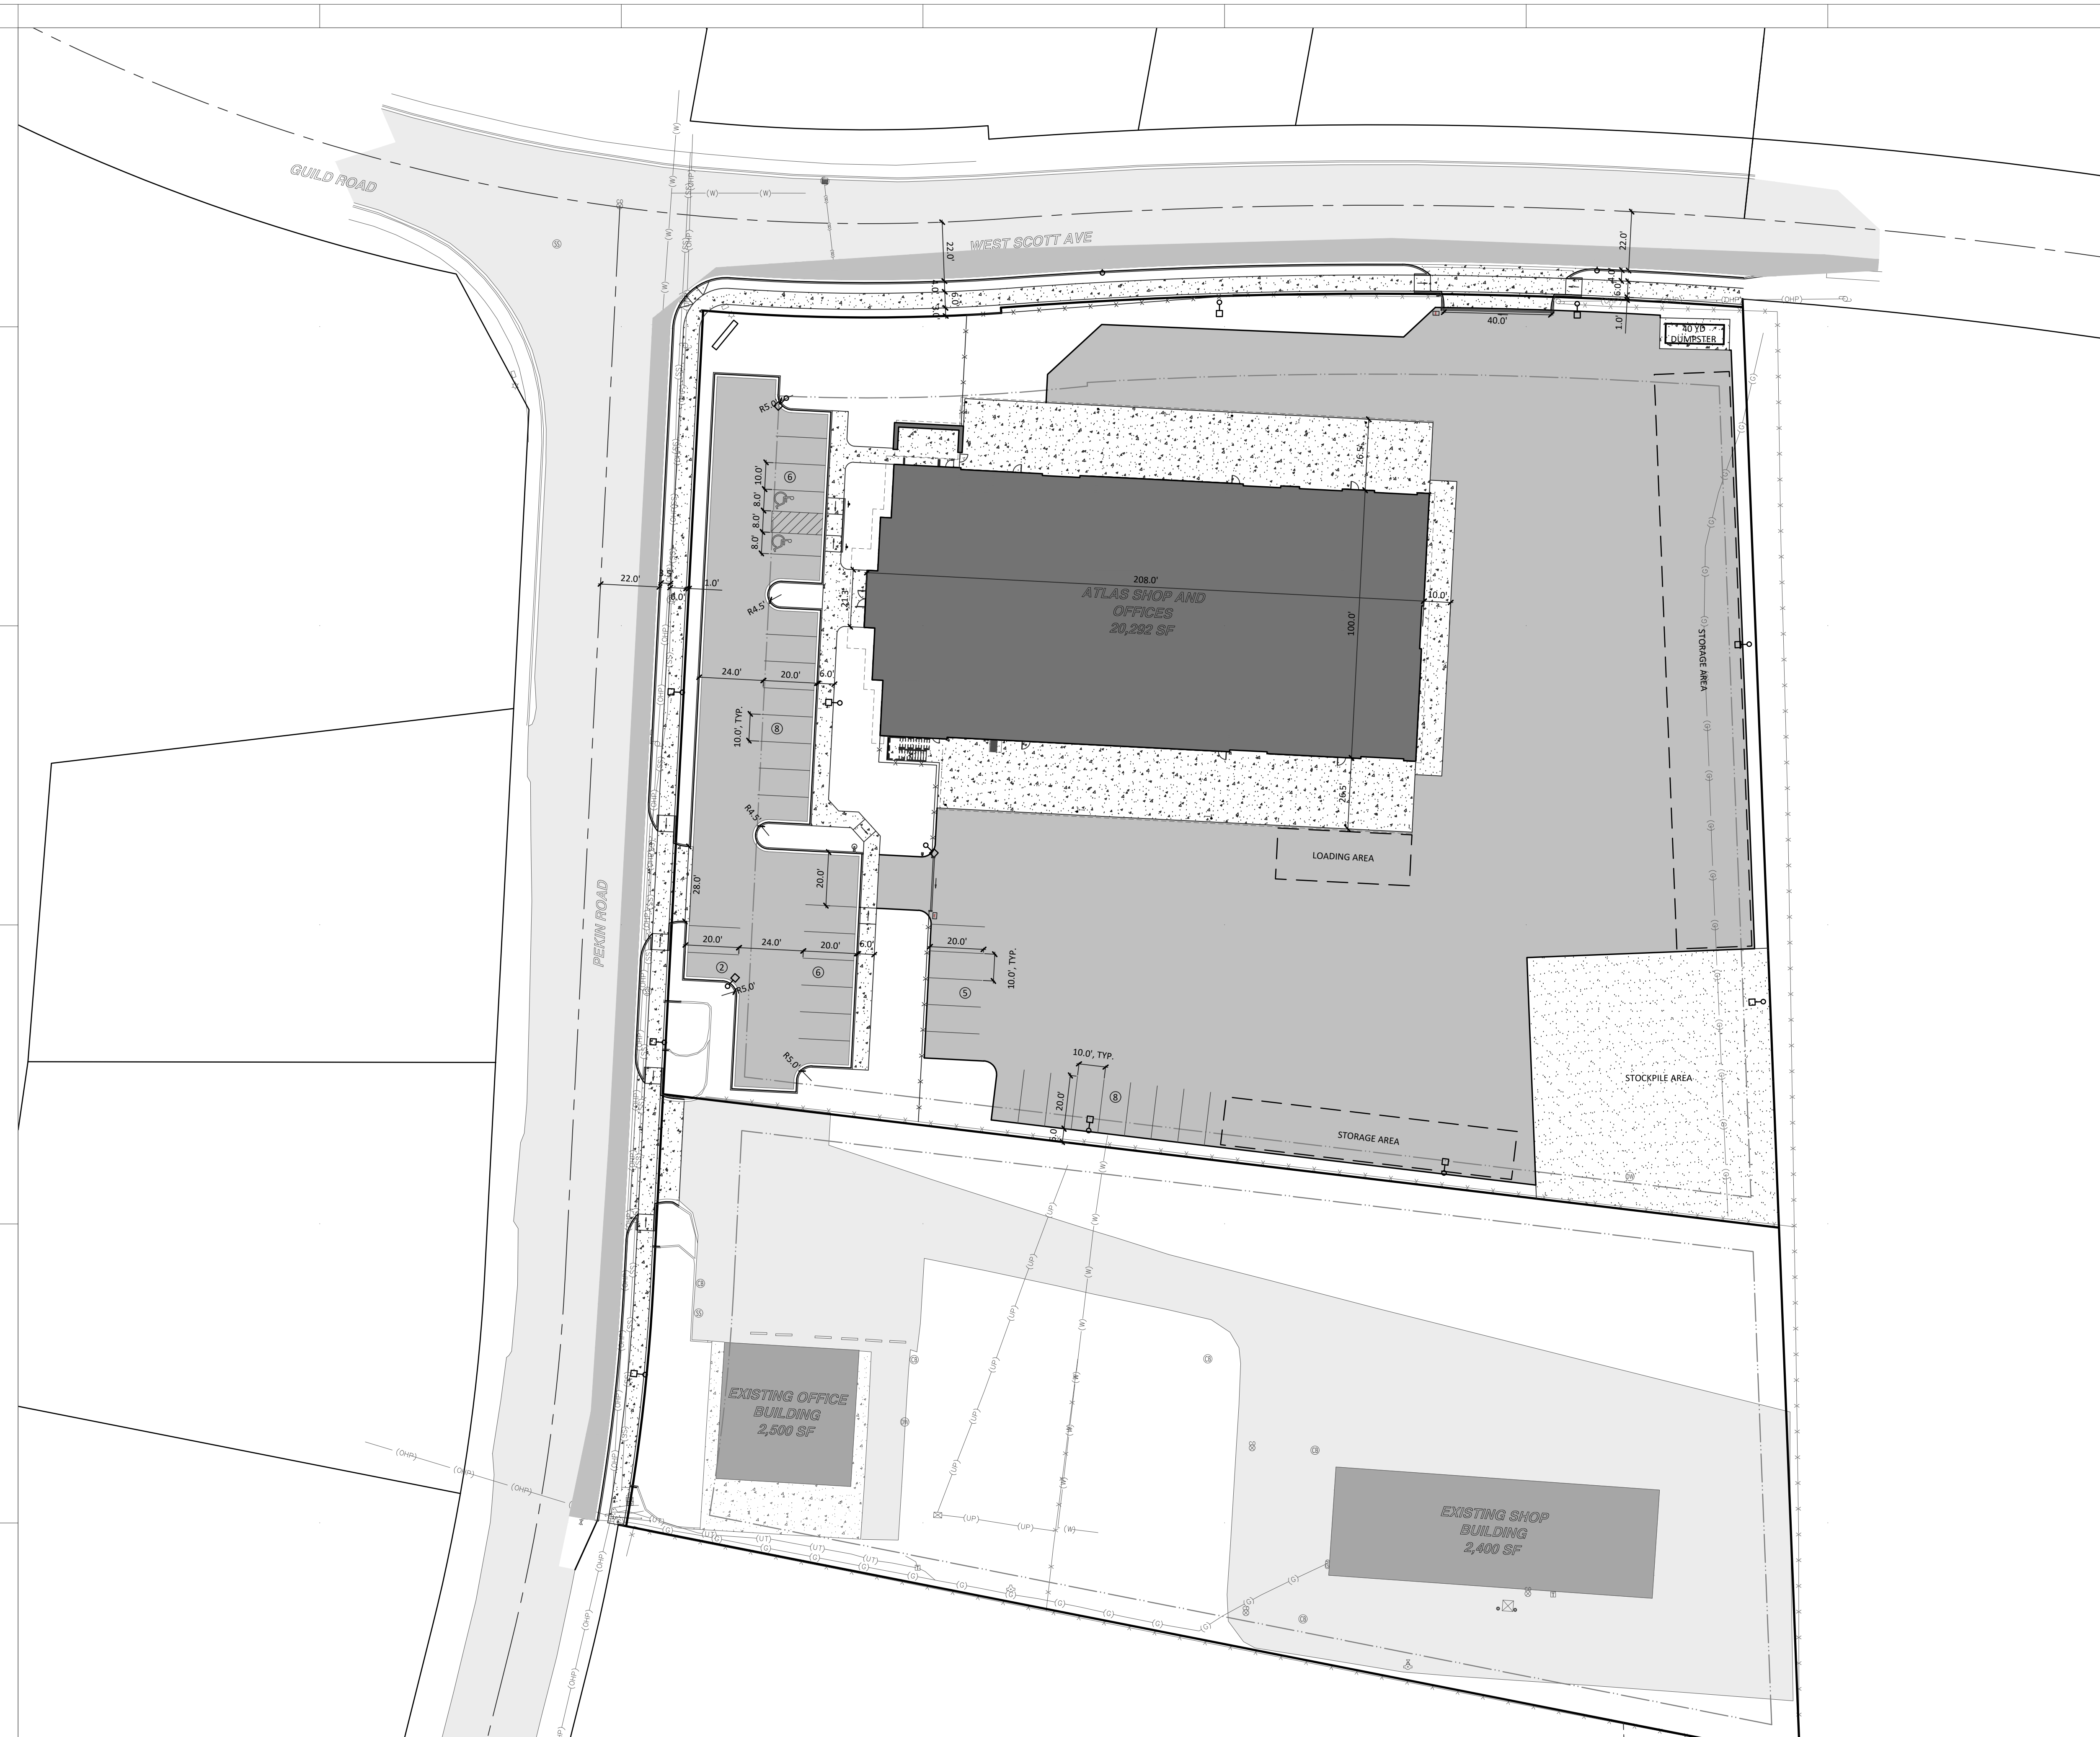

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DRAWN: EMS CHECKED: SLD

DATE: 01/07/2021

REVISIONS:

NO.	DESCRIPTION

SITE PLAN

C1.10

ATLAS PLUMBING SHOP
 428 NORTH PEKIN ROAD
 WOODLAND, WA 98674



- KEYNOTES:**
1. CUT AND CAP EXISTING WATER MAIN.
 2. NEW 12" WATER MAIN.
 3. INSTALL FIRE HYDRANT.
 4. 12" TO 2" WATER REDUCER.
 5. 2" BLOW-OFF HYDRANT IN CITY ROW.
 6. 2" DOMESTIC WATER TAP, SERVICE AND METER PER DTL.X/C2.XX.
 7. 6" FIRE SUPPRESSION SERVICE.
 8. IRRIGATION SLEEVE. DESIGN BY OTHERS.
 9. NEW 8" SANITARY SEWER MAIN.
 10. MANHOLE PER DTL. X/C2.XX.
 11. 4" SANITARY SEWER SERVICE PER DTL. X/C2.XX.
 12. 4" SANITARY CLEANOUT PER DTL. X/C2.XX.
 13. 12" STORM PIPE PER DTL. X/C2.XX.
 14. 12" PERFORATED STORM PIPE WITH WASHED ROCK AND DRAIN FABRIC PER DTL. X/C2.XX.
 15. 6" ROOF DRAIN.
 16. CATCH BASIN PER DTL. X/C2.XX.
 17. FLOW SPLITTER PER DTL. X/C2.XX.
 18. PRETREATMENT PER DTL. X/C2.XX.
 19. TREATMENT PER DTL. X/C2.XX.
 20. UNDERGROUND INFILTRATION PER DTL. X/C2.XX.
 21. INSTALL UNDERGROUND POWER. COORDINATE WITH UTILITY COMPANY.
 22. RELOCATED TRANSFORMER PER UTILITY COMPANY. SEE ELECTRICAL DESIGN FOR MORE DETAIL.
 23. NEW 1.5" GAS SERVICE. COORDINATE WITH UTILITY COMPANY.
 24. NEW GAS METER, COORDINATE WITH UTILITY COMPANY.
- GENERAL NOTES:**
- 1.



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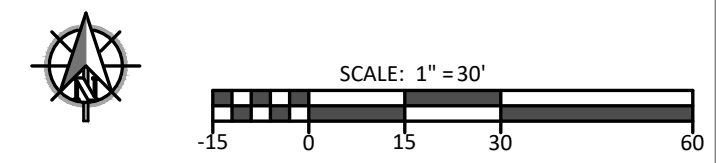
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SITE UTILITY PLAN


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1 SITE UTILITY PLAN
 1" = 30'



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LEGEND:
 502.79(e) EXISTING SPOT GRADE
 500.13 DESIGN SPOT GRADE
 500.13 DESIGN TBC GRADE



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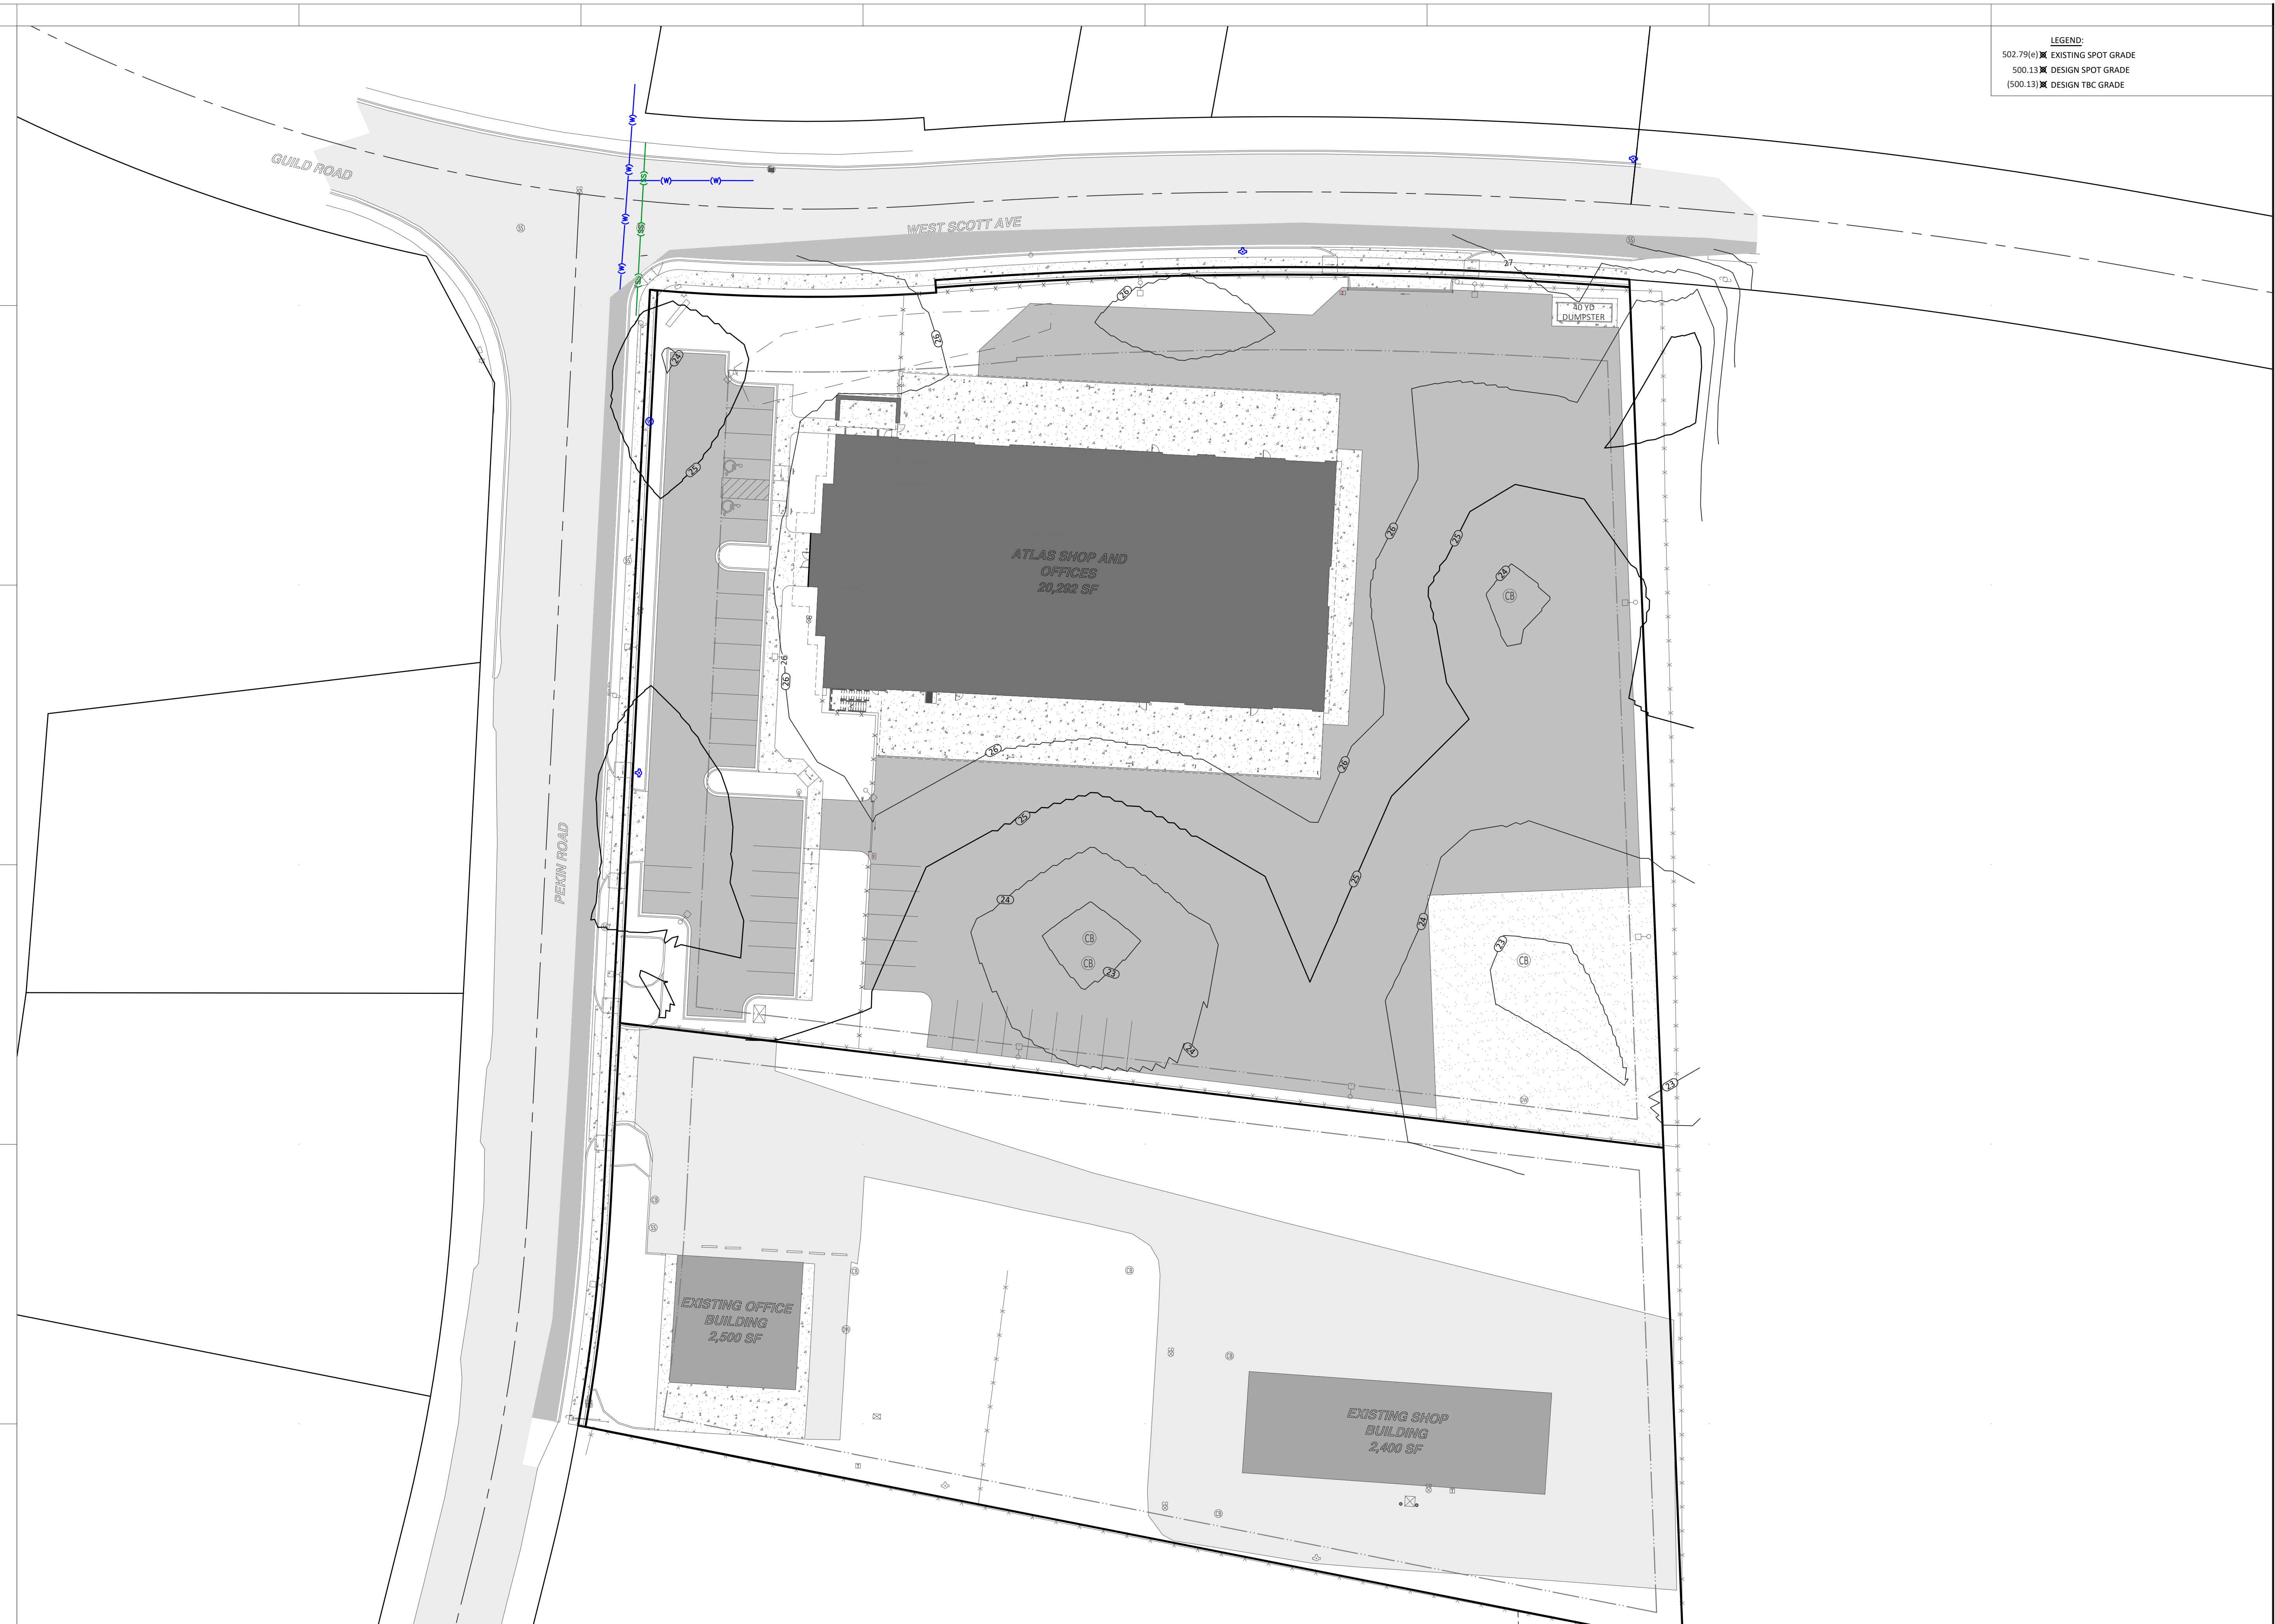
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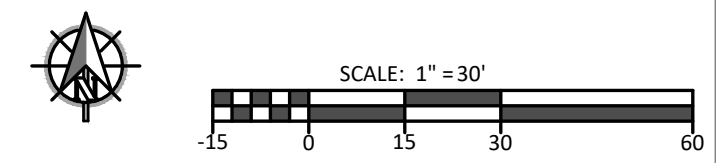
REVISIONS:

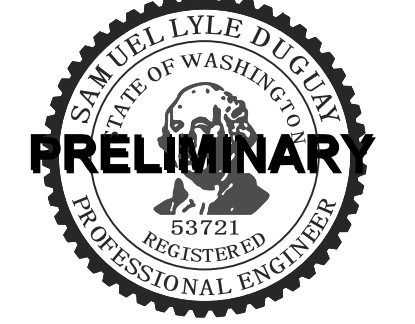SITE GRADING PLAN

C1.30



1 SITE GRADING PLAN
 1" = 30'



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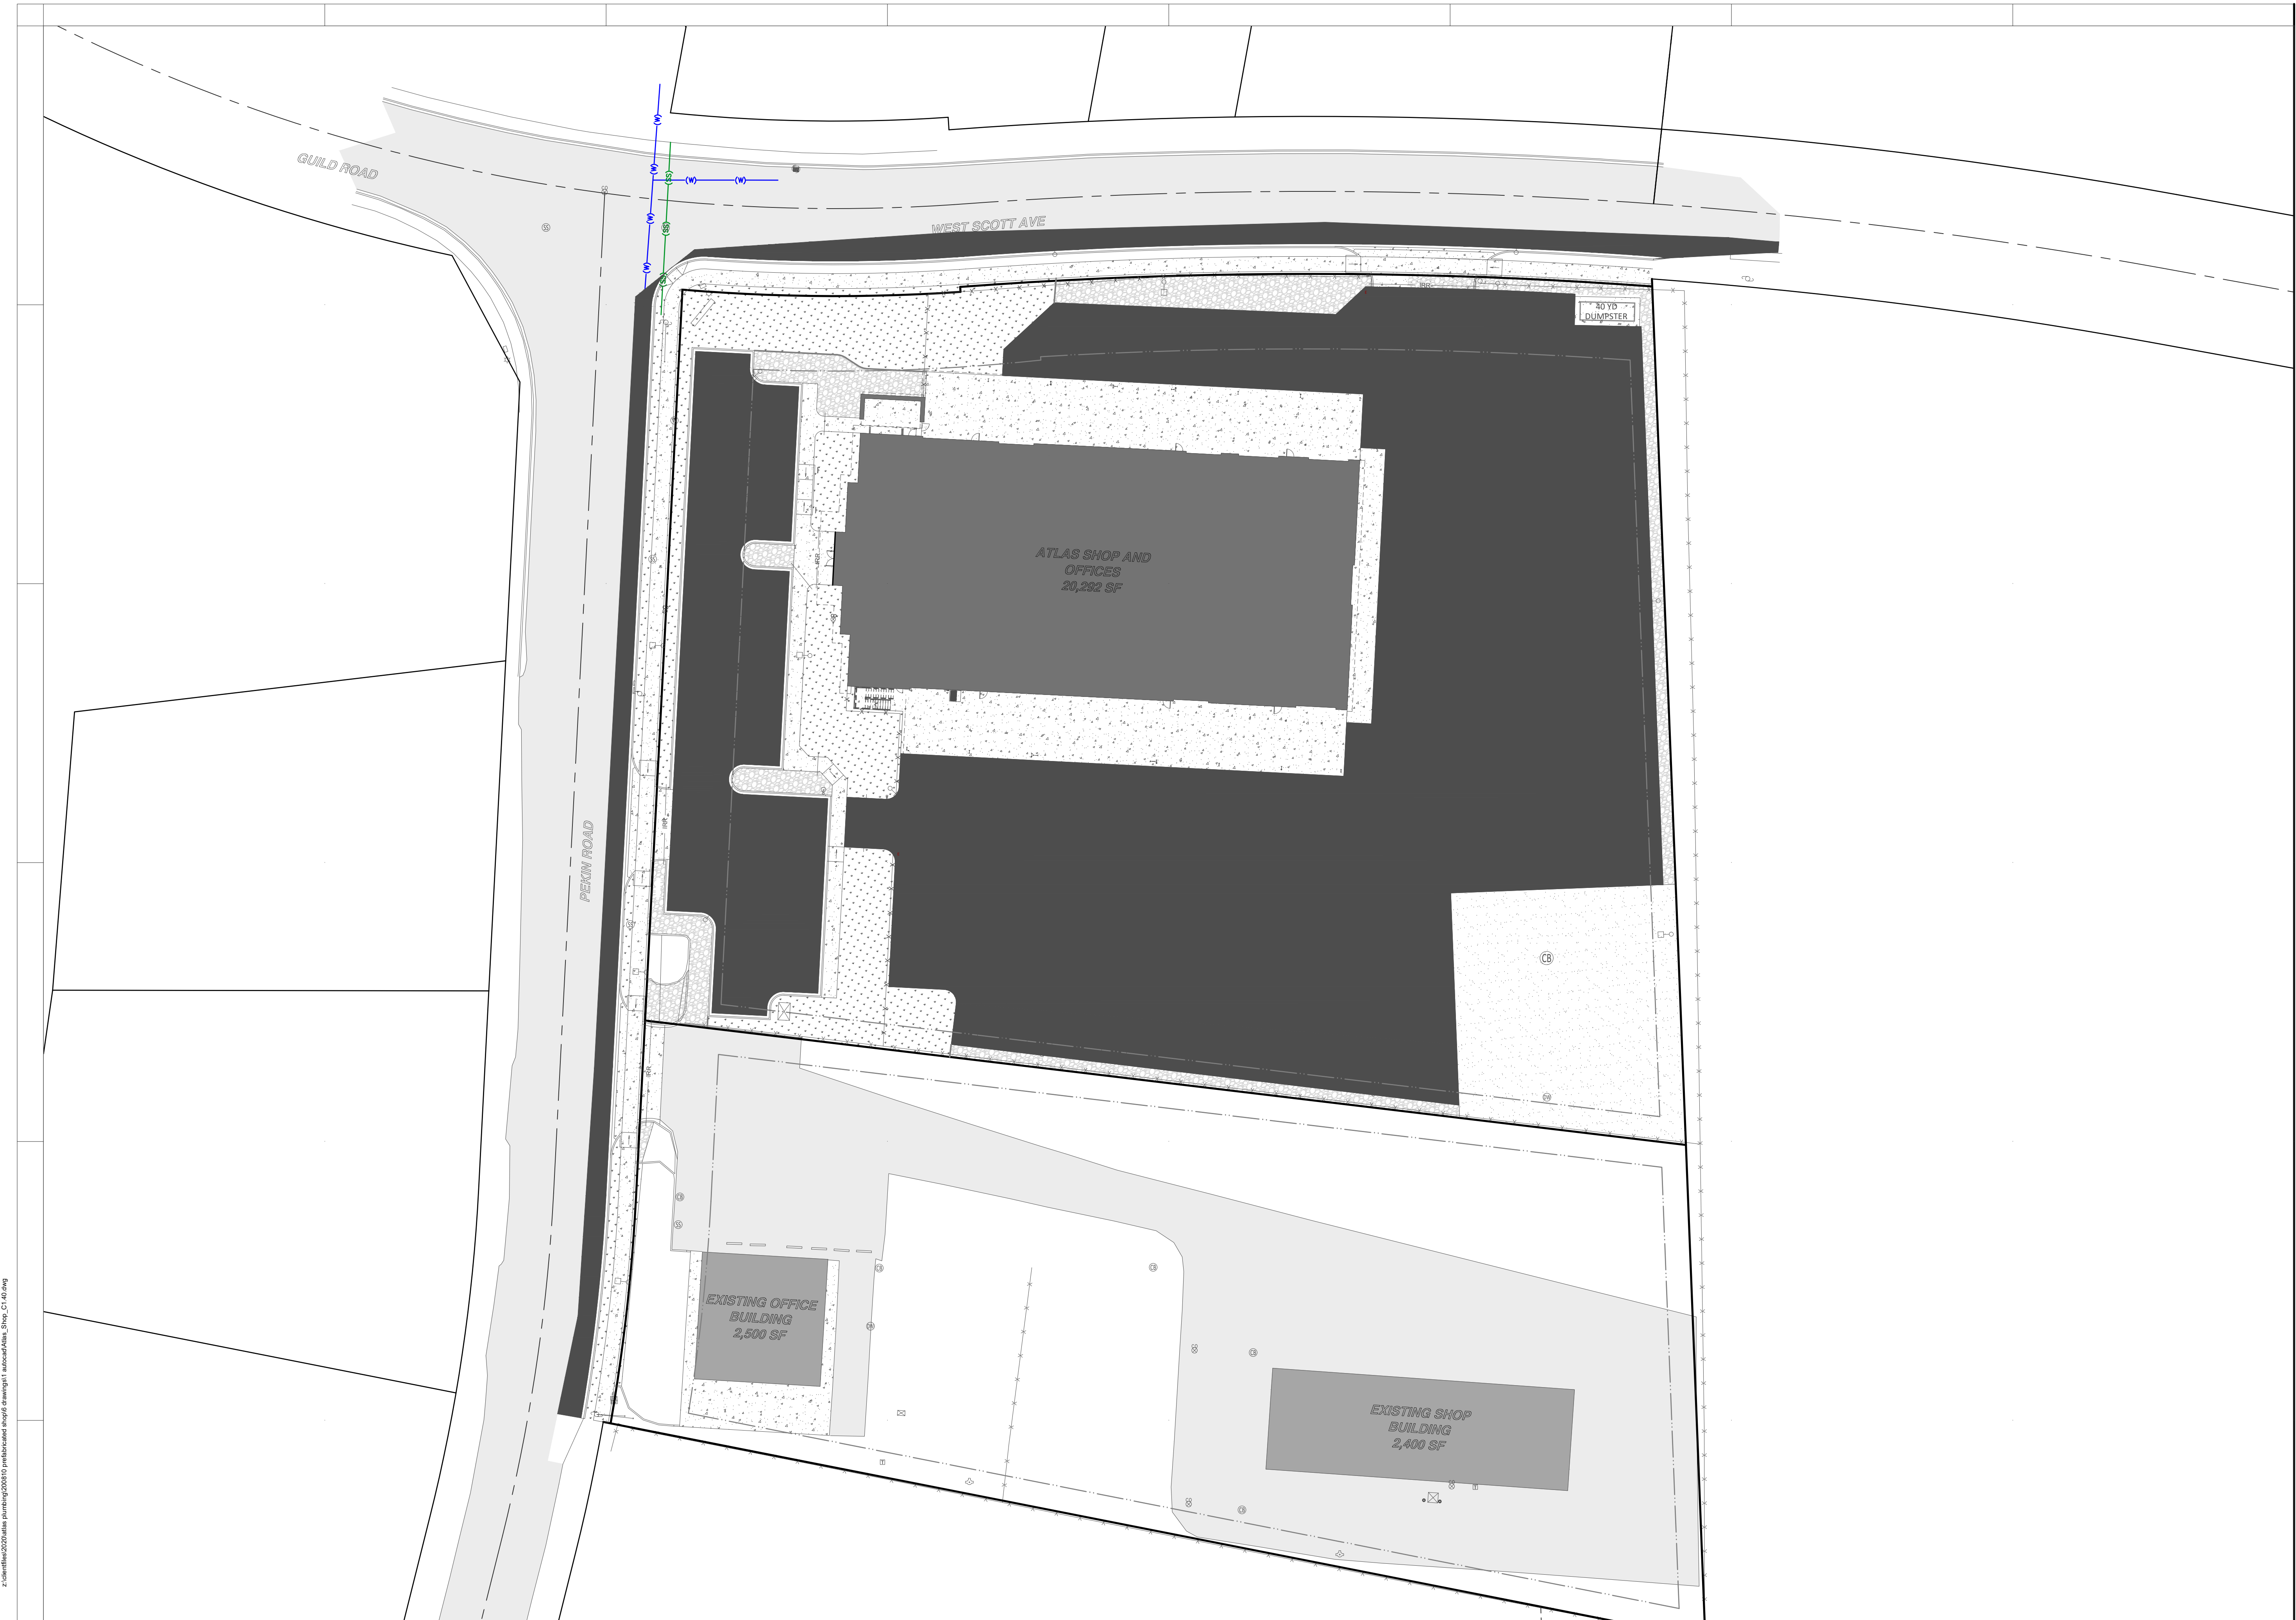
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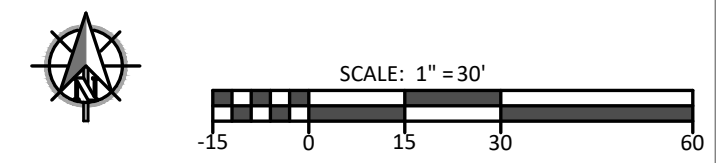
REVISIONS:

**SITE
 LANDSCAPING
 PLAN**

C1.40



1 SITE LANDSCAPING PLAN
1" = 30'



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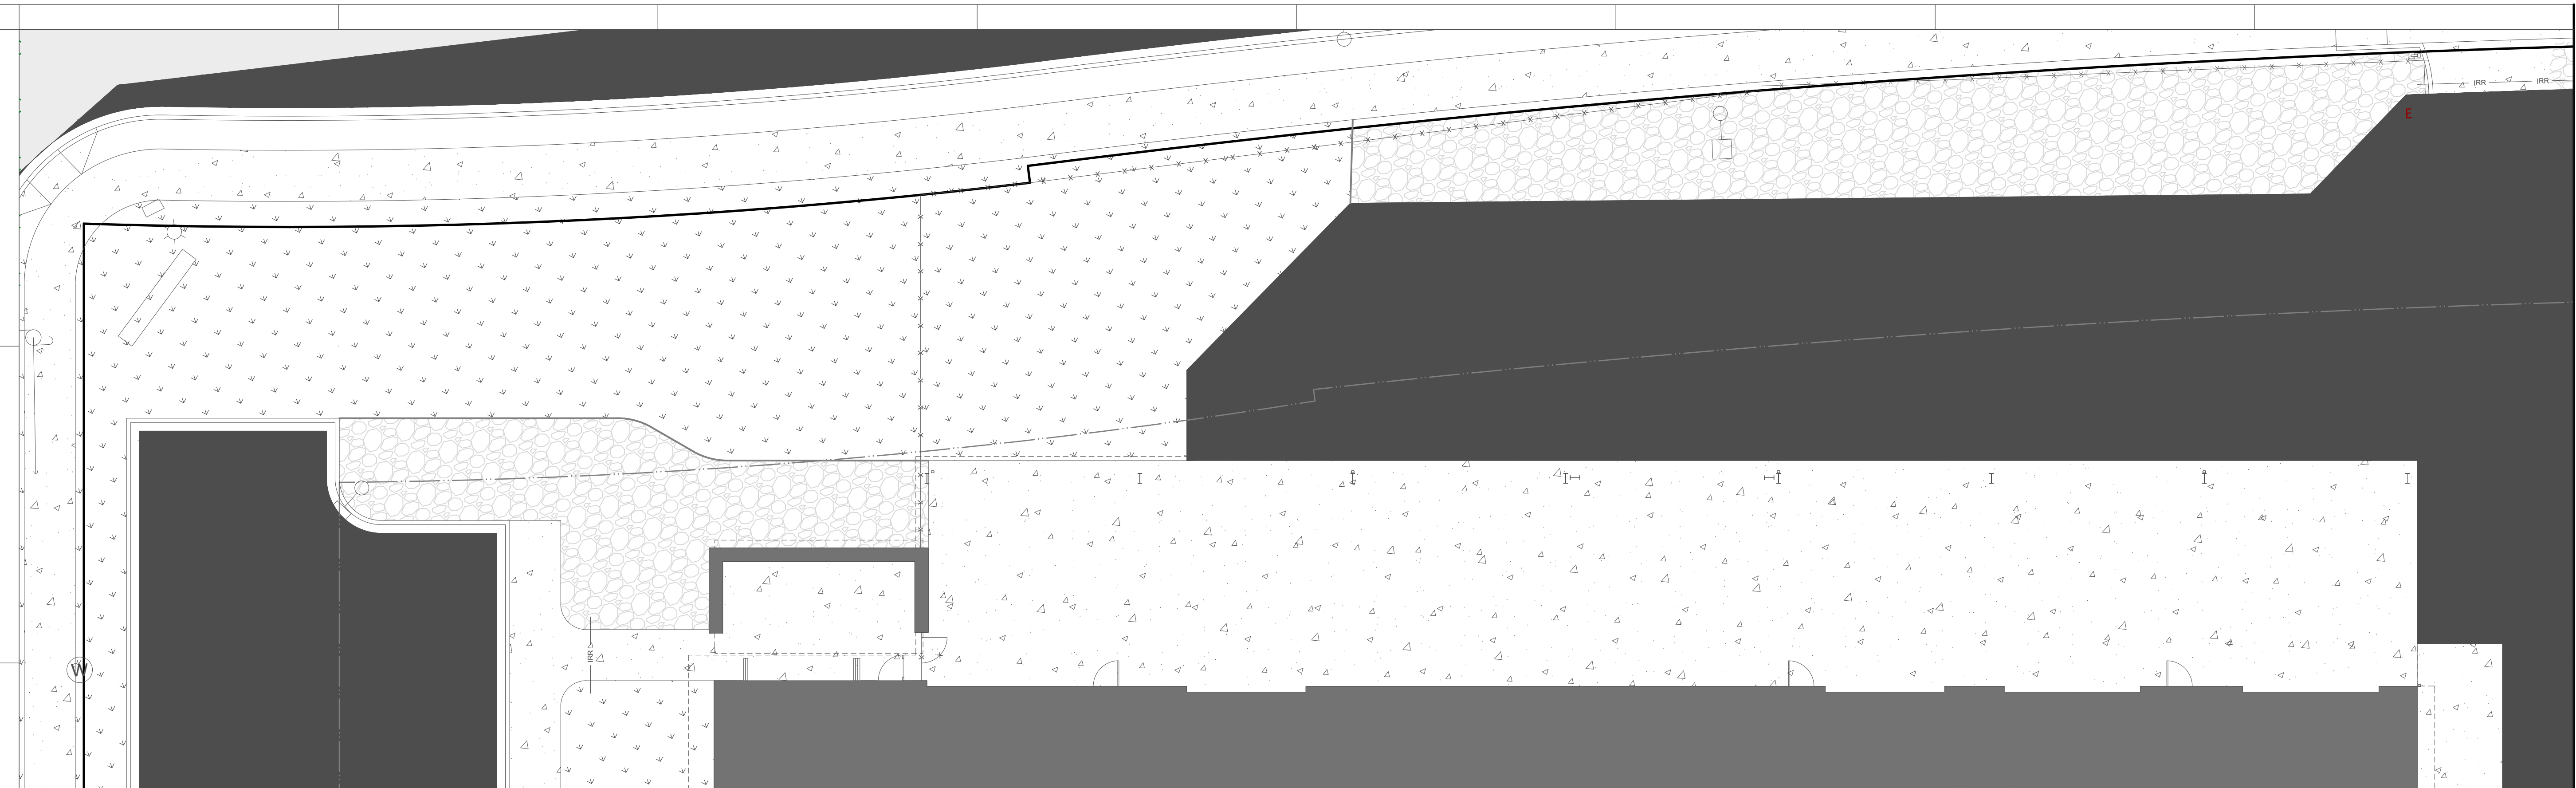
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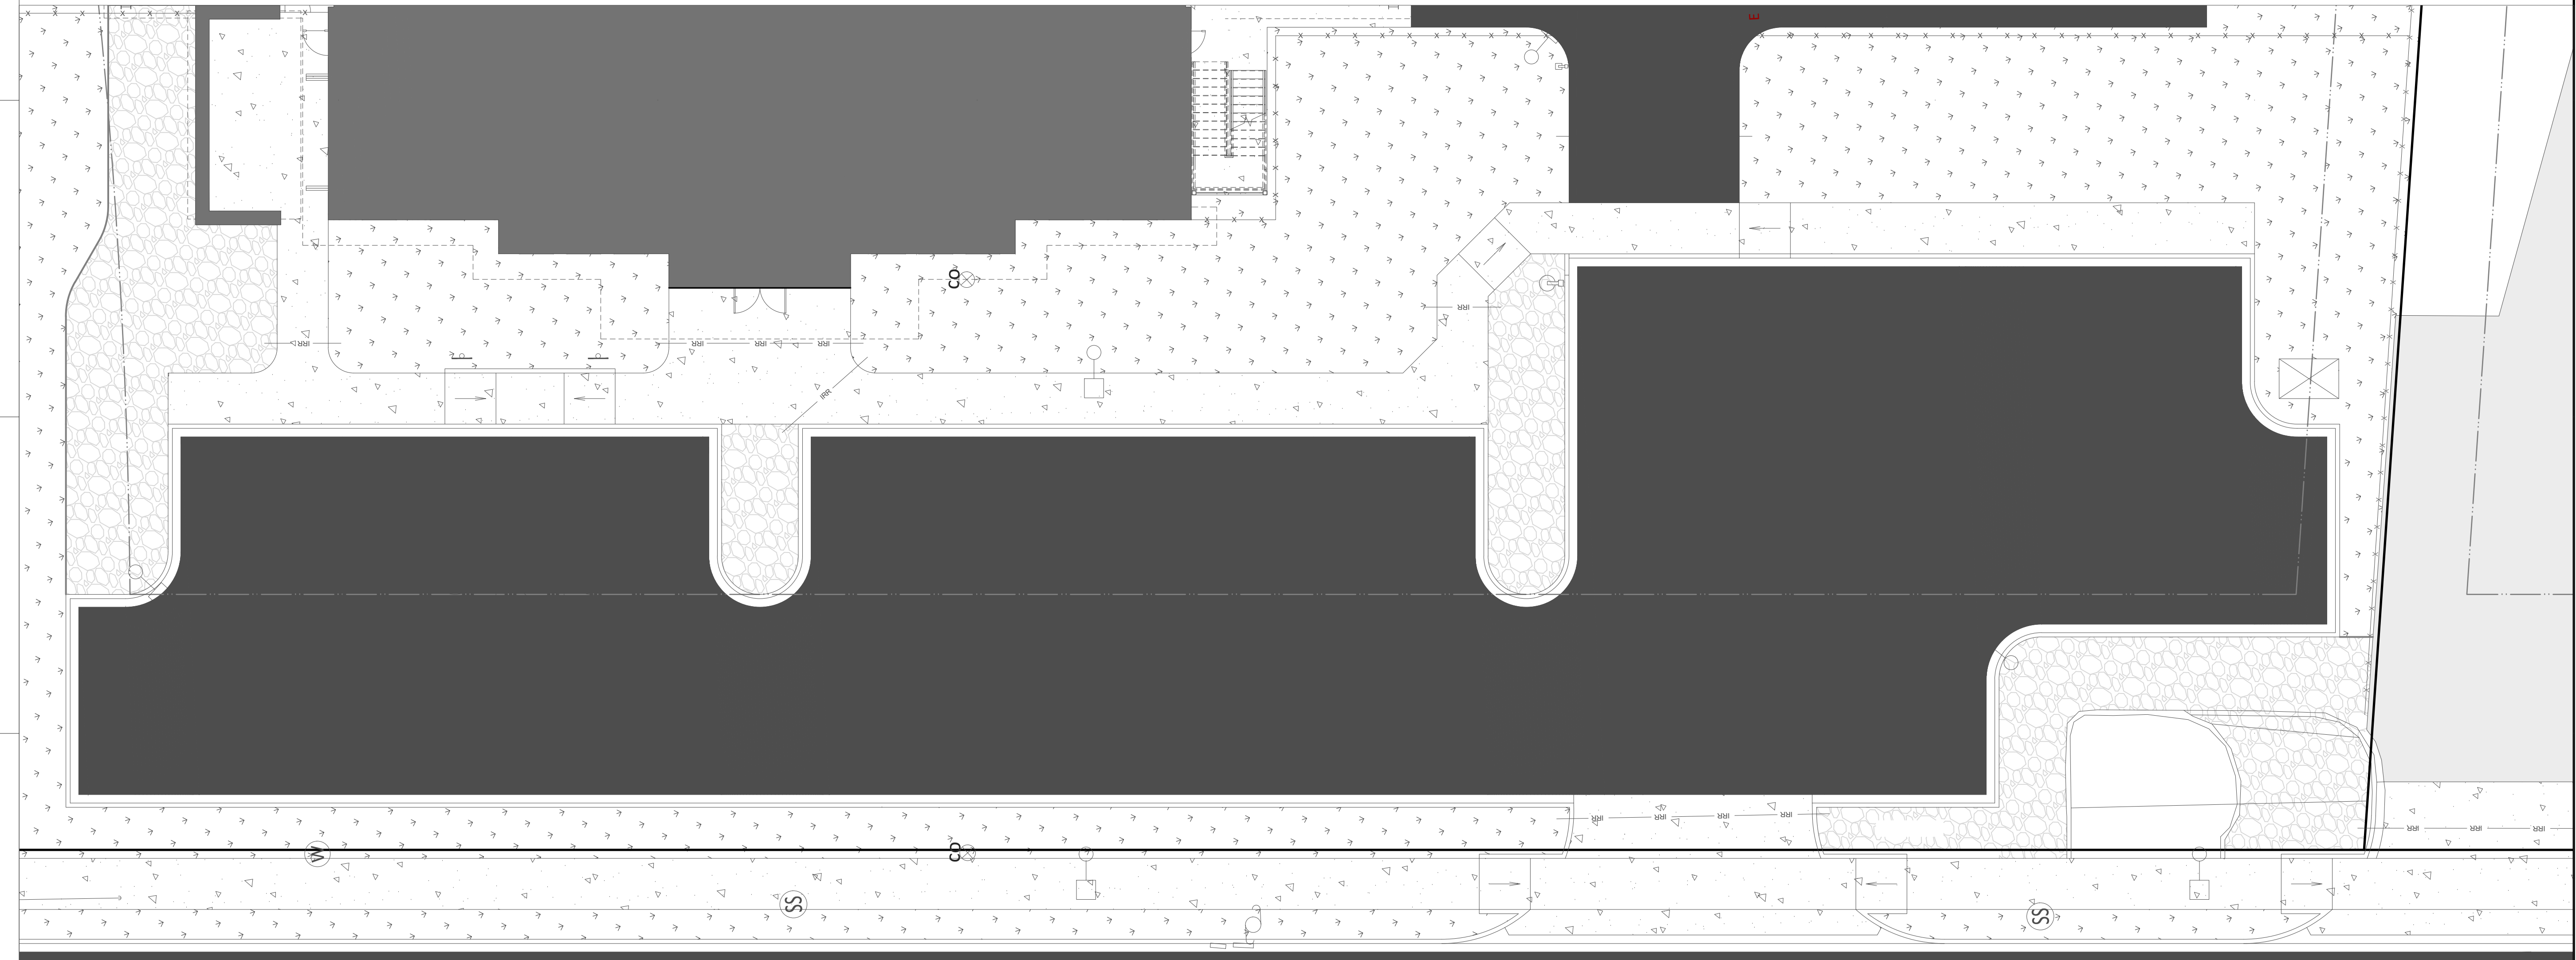
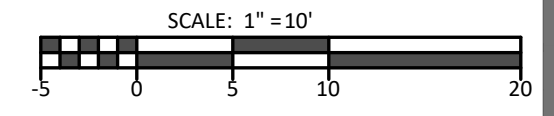
REVISIONS:

**SITE
LANDSCAPING
DETAIL**


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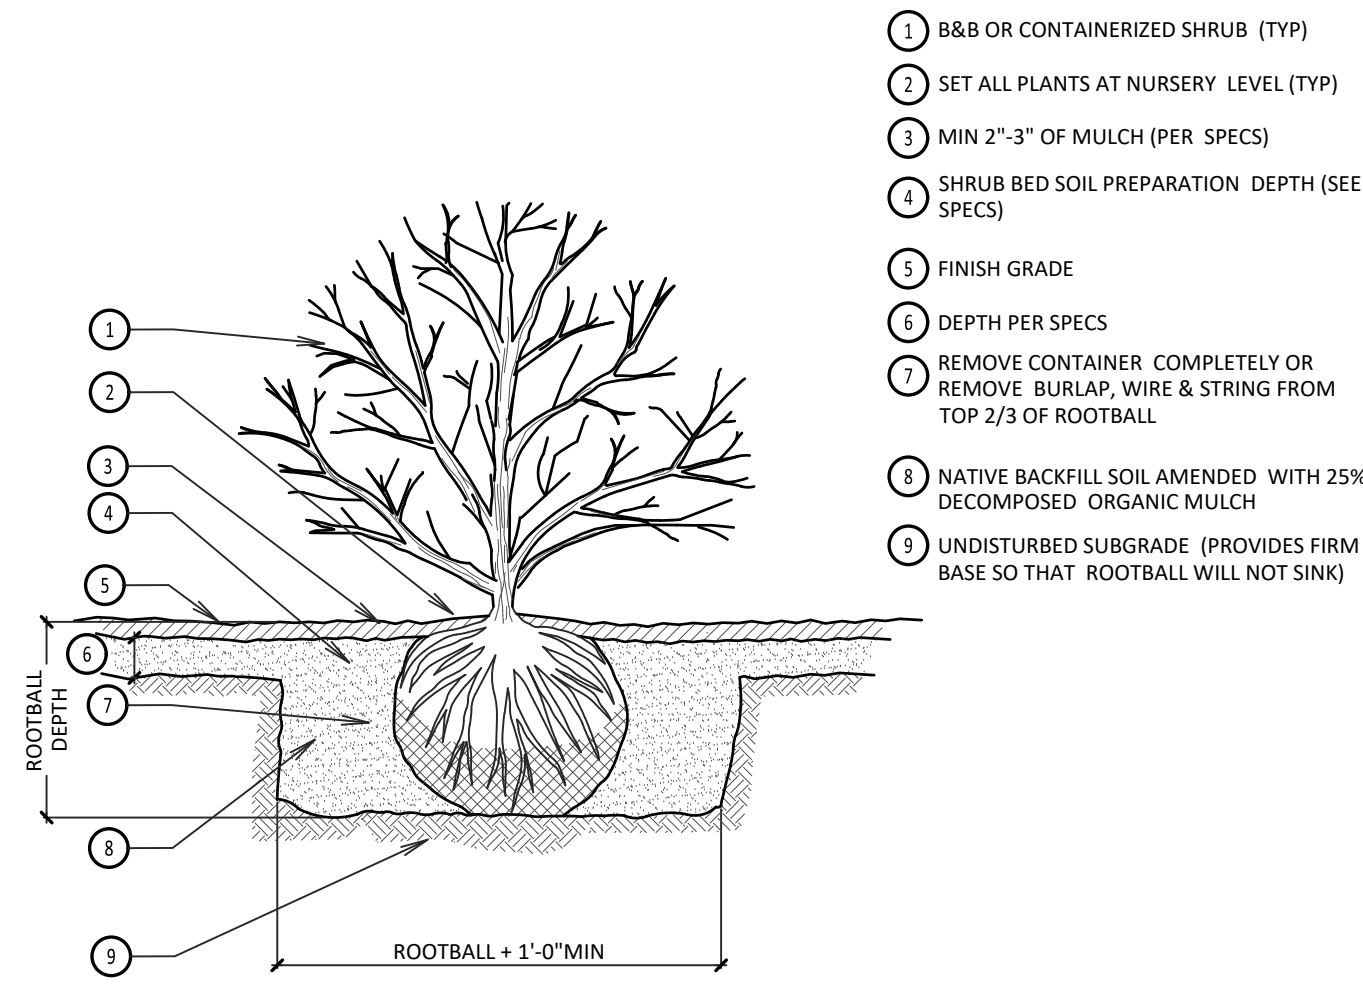
1 NORTH LANDSCAPING DETAIL
1" = 10'



2 WEST LANDSCAPING DETAIL
1" = 10'




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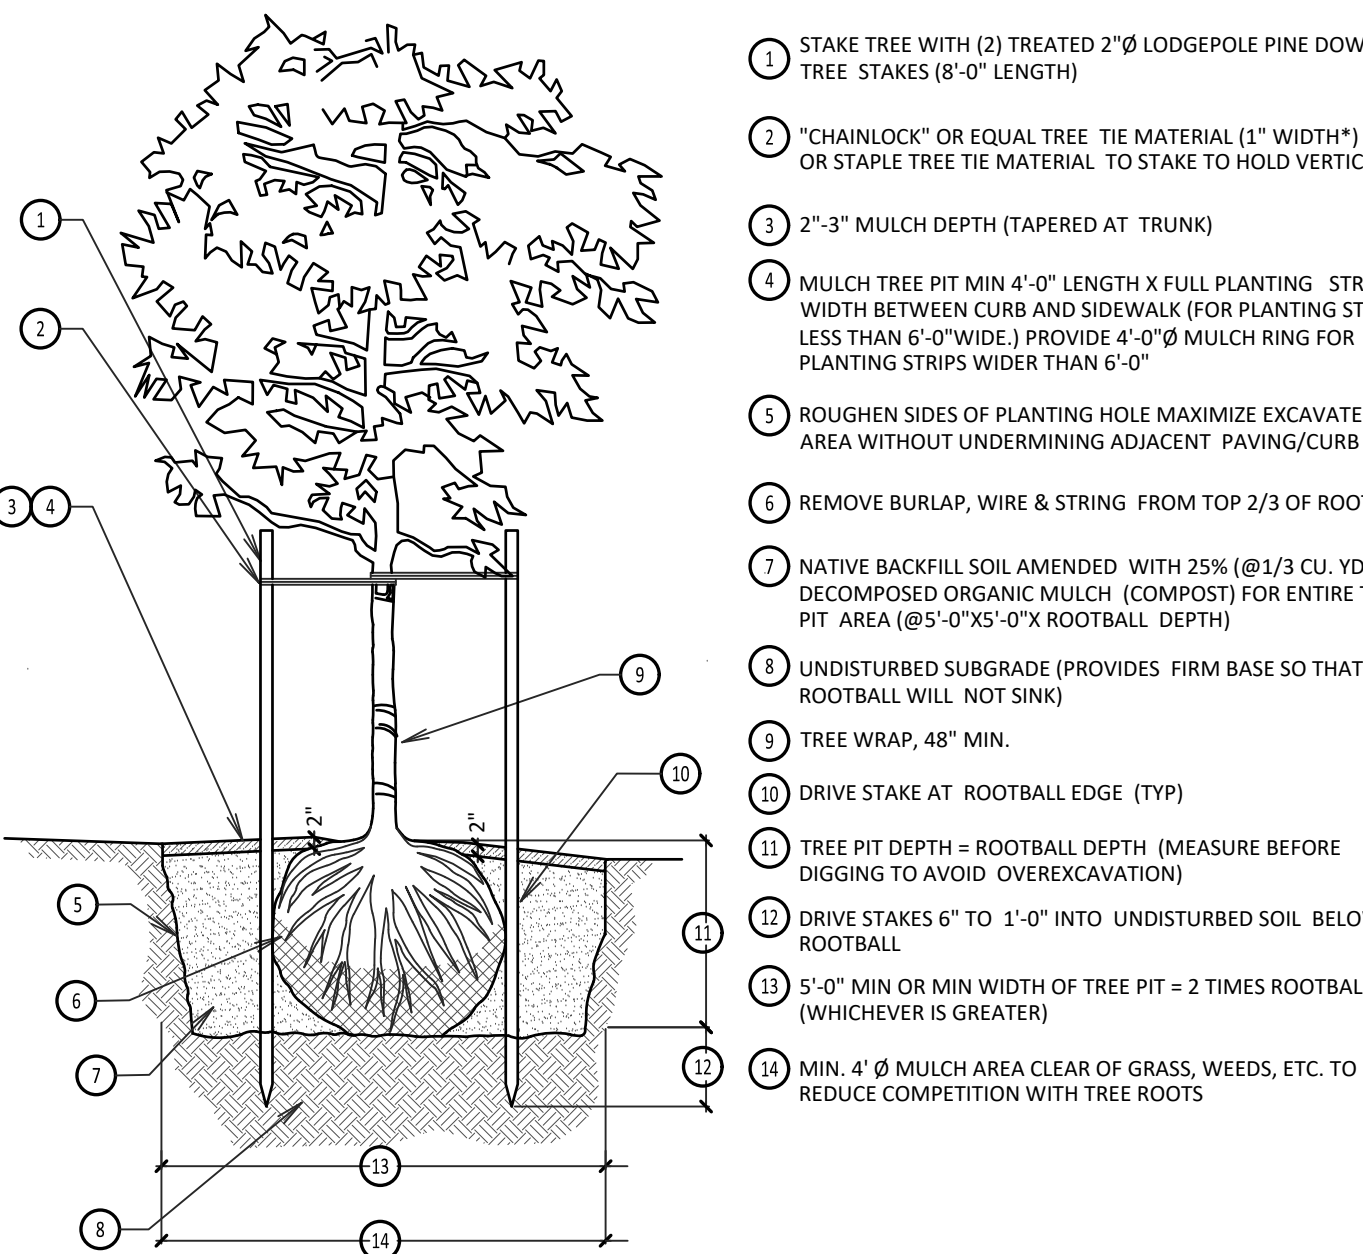


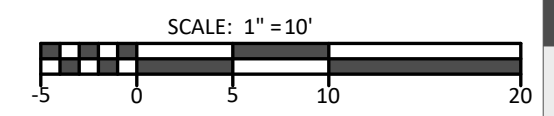- 1 B&B OR CONTAINERIZED SHRUB (TYP)
- 2 SET ALL PLANTS AT NURSERY LEVEL (TYP)
- 3 MIN 2"-3" OF MULCH (PER SPECS)
- 4 SHRUB BED SOIL PREPARATION DEPTH (SEE SPECS)
- 5 FINISH GRADE
- 6 DEPTH PER SPECS
- 7 REMOVE CONTAINER COMPLETELY OR REMOVE BURLAP, WIRE & STRING FROM TOP 2/3 OF ROOTBALL
- 8 NATIVE BACKFILL SOIL AMENDED WITH 25% DECOMPOSED ORGANIC MULCH
- 9 UNDISTURBED SUBGRADE (PROVIDES FIRM BASE SO THAT ROOTBALL WILL NOT SINK)

1 SHRUB PLANTING DETAIL
1/4" = 1'-0"

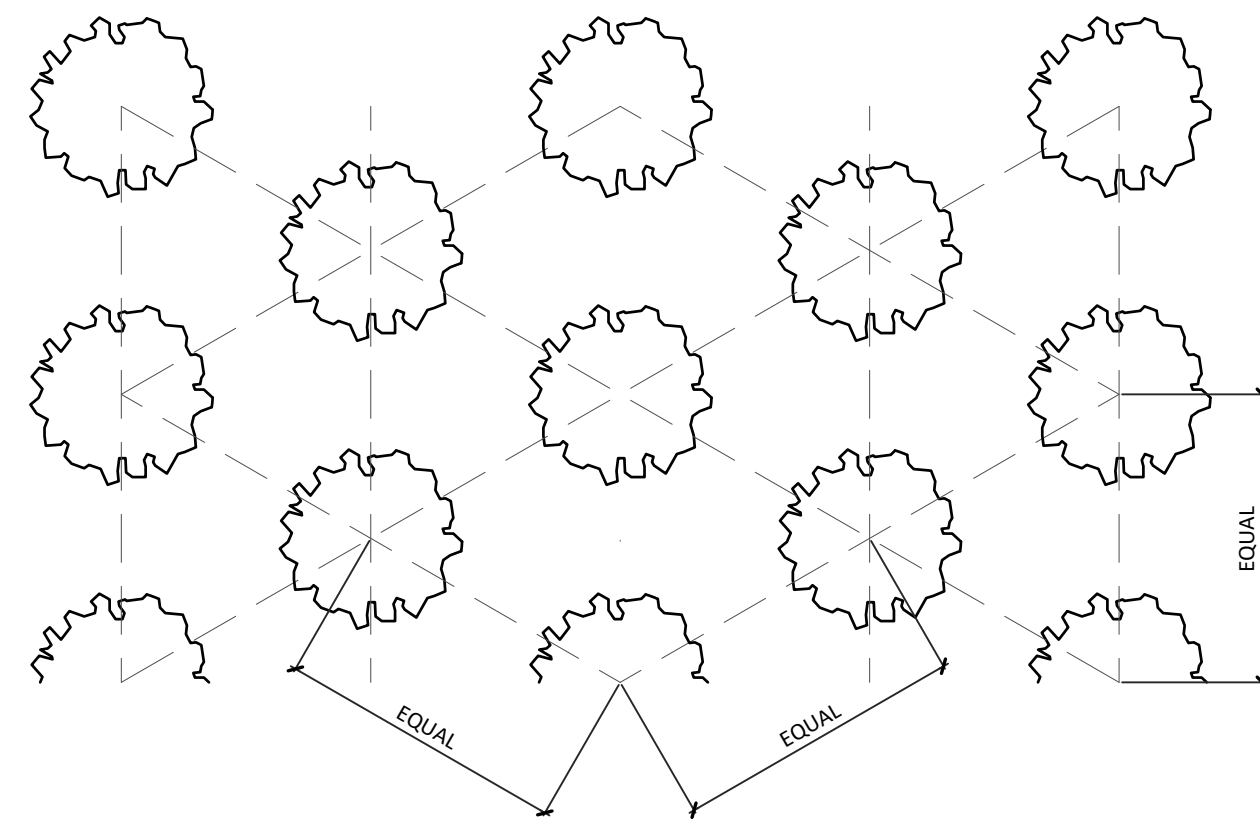


4 GROUNDCOVER PLANTING DETAIL
1/4" = 1'-0"



- 1 STAKE TREE WITH (2) TREATED 2"Ø LODGEPOLE PINE DOWELED TREE STAKES (8'-0" LENGTH)
- 2 "CHAINLOCK" OR EQUAL TREE TIE MATERIAL (1" WIDTH) NAIL OR STAPLE TREE TIE MATERIAL TO STAKE TO HOLD VERTICALLY
- 3 2"-3" MULCH DEPTH (TAPERED AT TRUNK)
- 4 MULCH TREE PIT MIN 4'-0" LENGTH X FULL PLANTING STRIP WIDTH BETWEEN CURB AND SIDEWALK (FOR PLANTING STRIPS LESS THAN 6'-0" WIDE.) PROVIDE 4'-0"Ø MULCH RING FOR PLANTING STRIPS WIDER THAN 6'-0"
- 5 ROUGHEN SIDES OF PLANTING HOLE MAXIMIZE EXCAVATED AREA WITHOUT UNDERMINING ADJACENT PAVING/CURB
- 6 REMOVE BURLAP, WIRE & STRING FROM TOP 2/3 OF ROOTBALL
- 7 NATIVE BACKFILL SOIL AMENDED WITH 25% (@1/3 CU YD.) DECOMPOSED ORGANIC MULCH (COMPOST) FOR ENTIRE TREE PIT AREA (@6'-0"Ø X ROOTBALL DEPTH)
- 8 UNDISTURBED SUBGRADE (PROVIDES FIRM BASE SO THAT ROOTBALL WILL NOT SINK)
- 9 TREE WRAP, 48" MIN.
- 10 DRIVE STAKE AT ROOTBALL EDGE (TYP)
- 11 TREE PIT DEPTH = ROOTBALL DEPTH (MEASURE BEFORE DIGGING TO AVOID OVEREXCAVATION)
- 12 DRIVE STAKES 6" TO 1'-0" INTO UNDISTURBED SOIL BELOW ROOTBALL
- 13 5'-0" MIN OR MIN WIDTH OF TREE PIT = 2 TIMES ROOTBALL (WHICHEVER IS GREATER)
- 14 MIN. 4" Ø MULCH AREA CLEAR OF GRASS, WEEDS, ETC. TO REDUCE COMPETITION WITH TREE ROOTS

2 DECIDUOUS TREE PLANTING DETAIL
1/4" = 1'-0"

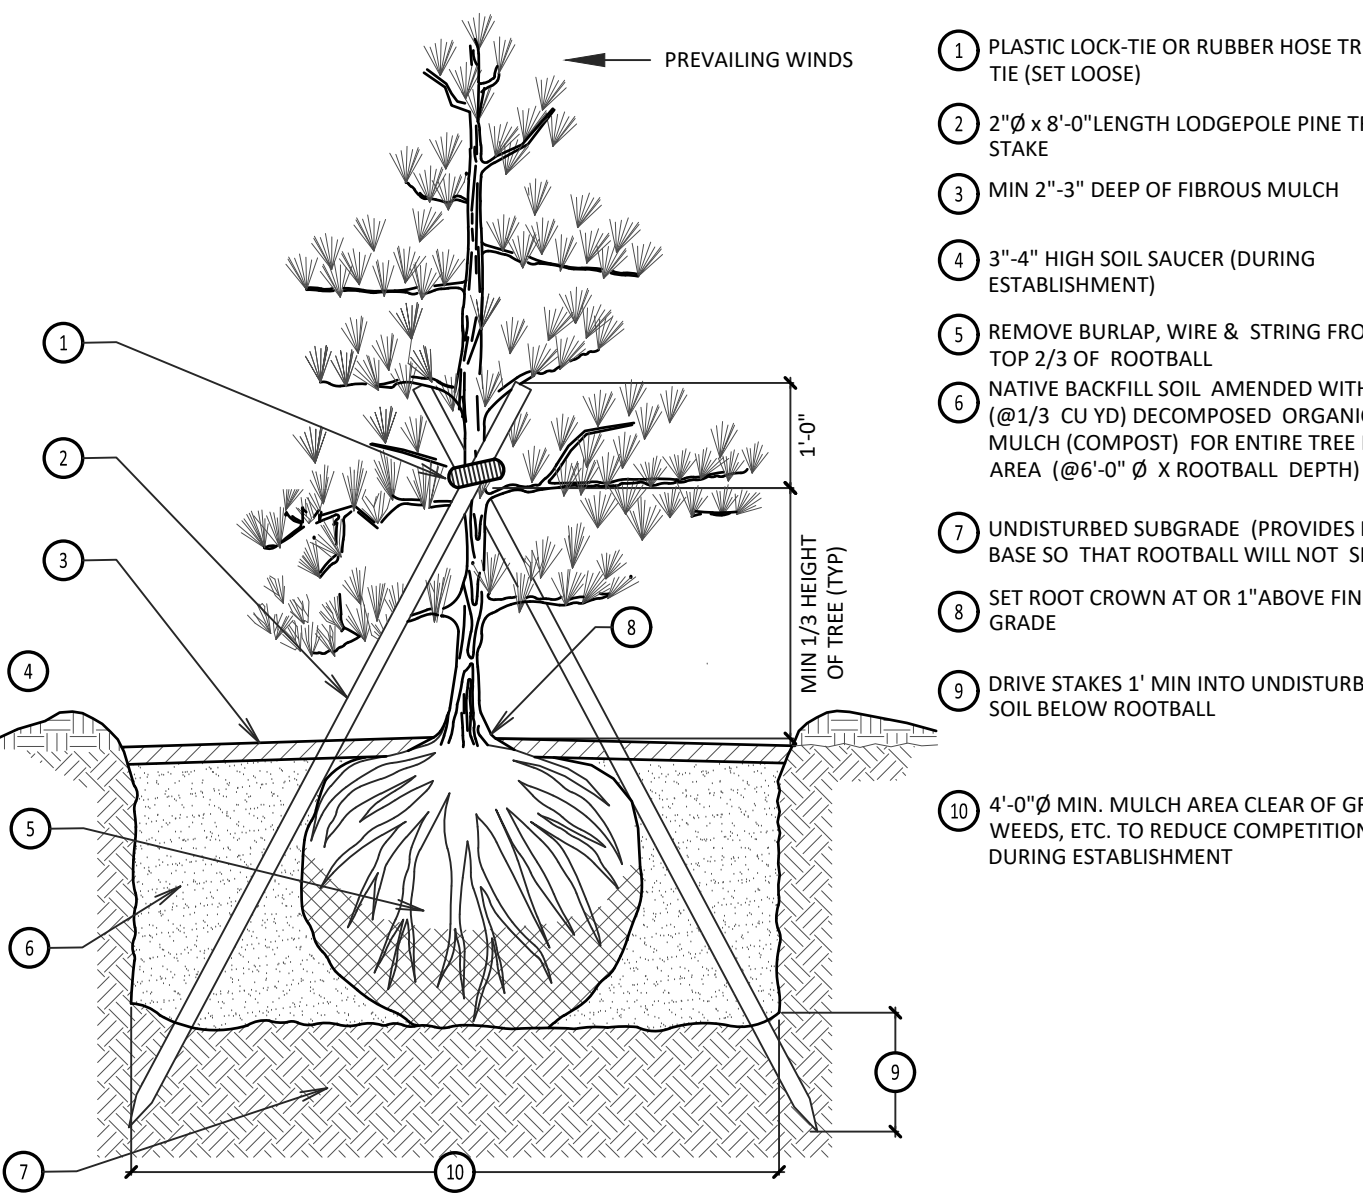

- 1 PLASTIC LOCK TIE OR RUBBER HOSE TREE TIE (SET LOOSE)
- 2 2"Ø x 8'-0" LENGTH LODGEPOLE PINE TREE STAKE
- 3 MIN 2"-3" DEEP OF FIBROUS MULCH
- 4 3"-4" HIGH SOIL SAUCER (DURING ESTABLISHMENT)
- 5 REMOVE BURLAP, WIRE & STRING FROM TOP 2/3 OF ROOTBALL
- 6 NATIVE BACKFILL SOIL AMENDED WITH 25% (@1/3 CU YD.) DECOMPOSED ORGANIC MULCH (COMPOST) FOR ENTIRE TREE PIT AREA (@6'-0"Ø X ROOTBALL DEPTH)
- 7 UNDISTURBED SUBGRADE (PROVIDES FIRM BASE SO THAT ROOTBALL WILL NOT SINK)
- 8 SET ROOT CROWN AT OR 1" ABOVE FINISH GRADE
- 9 DRIVE STAKES 1' MIN INTO UNDISTURBED SOIL BELOW ROOTBALL
- 10 4'-0"Ø MIN. MULCH AREA CLEAR OF GRASS, WEEDS, ETC. TO REDUCE COMPETITION DURING ESTABLISHMENT

3 CONIFEROUS PLANTING DETAIL
1/4" = 1'-0"

KEYNOTES:

- 1 SHRUB PLANTING PER DTL.
 - 2 DECIDUOUS TREE PLANTING PER DTL.
 - 3 CONIFEROUS PLANTING PER DTL.
 - 4 INFILL ALTERED LANDSCAPE BED WITH MATCHING MATERIALS.
 - 5 CONCRETE EDGING.
 - 6 TREE AND SHRUB PLANTERS TO CONTAIN 12" MIN. TOPSOIL, WEED BARRIER, AND ROCK OR MULCH PER PLAN. PROVIDE 1" IRRIGATION LINE FROM ZONE VALVE AND DRIP IRRIGATE.
- LANDSCAPE ROCK - MATCH EXISTING
 HYDROSEED
 SOD

GENERAL NOTES:

- 1 CONTRACTOR SHALL VERIFY PLANT QUANTITIES. IF THERE IS A DISCREPANCY BETWEEN THE QUANTITIES LISTED IN THE PLAN LEGEND AND THE QUANTITIES SHOWN ON THE PLAN, THE PLAN SHALL PREVAIL.
- 2 STAKE ALL PROPOSED TREE LOCATIONS FOR REVIEW AND APPROVAL BY OWNER'S REPRESENTATIVE PRIOR TO DIGGING TREE PITS. THE OWNER RESERVES THE RIGHT TO ADJUST LOCATION AND SPACING OF PLANTS.
- 3 PLANT SUBSTITUTIONS PROPOSED BY THE CONTRACTOR SHALL BE SIMILAR IN SIZE, SHAPE, AND FOLIAGE TYPE TO THE PLANT BEING REPLACED AND MUST BE APPROVED BY THE OWNER'S REPRESENTATIVE.
- 4 ALL PLANTS SHALL MEET OR EXCEED INDUSTRY STANDARDS FOR SIZE AND QUALITY. SUBSTANDARD PLANT MATERIAL WILL BE REJECTED BY THE OWNER'S REPRESENTATIVE.
- 5 REPLACE AND RESTORE DISTURBED AREAS TO THEIR ORIGINAL CONDITION OR TO THE OWNER'S SATISFACTION.
- 6 VERIFY BELOW GRADE CONDITIONS AND UTILITY LOCATIONS (EXISTING AND PROPOSED) PRIOR TO DIGGING.
- 7 COORDINATE ALL PLANTING WITH LOCATIONS OF UTILITY POLES, STORMWATER STRUCTURES, CLEANOUTS, ELECTRICAL TRANSFORMERS, WATER METERS, FIRE HYDRANTS, AND ANY OTHER ABOVE OR BELOW GROUND UTILITIES AND STRUCTURES. CONTRACTOR MAY FIELD ADJUST OR ELIMINATE PLANTS THAT CONFLICT WITH UTILITIES WITH THE APPROVAL OF THE OWNER'S REPRESENTATIVE. LOCAL CODE REQUIREMENTS AND BEST INDUSTRY PRACTICES SHALL GOVERN THE DISTANCE BETWEEN PLANTINGS AND VARIOUS UTILITIES.
- 8 ALL PLANTINGS SHALL BE IRRIGATED BY A PERMANENT AUTOMATIC UNDERGROUND SYSTEM TO BE DESIGNED AND INSTALLED BY OTHERS. THE IRRIGATION SYSTEM SHALL INCLUDE; A RAIN SENSOR SHUTOFF DEVICE AND/OR A DRIP IRRIGATION SYSTEM FOR THE NEW LANDSCAPING.
- 9 REMOVE ALL CONSTRUCTION DEBRIS FROM THE SITE TO THE SATISFACTION OF THE OWNER'S REPRESENTATIVE PRIOR TO BEGINNING ANY LANDSCAPE WORK. CONSTRUCTION DEBRIS DISCOVERED BURIED IN PLANTING BEDS SHALL BE REMOVED PRIOR TO COMPLETING LANDSCAPE WORK.
- 10 ALL PLANTING AREAS SHALL BE PROVIDED WITH AT LEAST 12" OF NON-COMPACTED TOPSOIL OR COMPOST AMENDED NATIVE SOIL.
- 11 BLACK COMPOST MATERIAL SHALL BE INCORPORATED INTO THE TOP LAYER OF SOIL IN SEEDED AREAS. ADD ONE SHOVEL FULL OF COMPOST PER GALLON POT SIZE TO THE PLANTING PIT FOR EACH TREE, SHRUB, OR GROUNDCOVER PLANT.
- 12 IDENTIFY ALL PLANTING BEDS AND LAWN EDGES IN THE FIELD FOR REVIEW AND APPROVAL BY OWNER'S REPRESENTATIVE PRIOR TO PLANTING AND SEEDING OPERATIONS.
- 13 IF THE CONTRACTOR PROPOSED ANY DEVIATIONS FROM THE PLANTING PLANS, THOSE DEVIATIONS SHALL NOT CAUSE THE PLAN TO FALL BELOW MINIMUM CODE REQUIREMENTS.
- 14 TREES PLANTED CLOSER THAN 5' FROM PAVING SHALL BE INSTALLED WITH 12" DEEPROOT ROOT BARRIERS, OR AN APPROVED EQUAL, ACCORDING TO MANUFACTURER'S SPECIFICATIONS.
- 15 ALL AREAS SUBJECT TO CLEARING AND GRADING THAT HAVE NOT BEEN COVERED BY IMPERVIOUS SURFACE INCORPORATED INTO A DRAINAGE FACILITY, OR ENGINEERED AS STRUCTURAL FILL OR SLOPE SHALL MAINTAIN SOIL QUALITY AND DEPTH IN ACCORDANCE WITH BMP TS.13 PER THE 2019 SWMMWW, V-5.



NOT FOR CONSTRUCTION

THE INFORMATION CONTAINED HEREIN IS PROPRIETARY. THIS DOCUMENT MAY NOT BE REPRODUCED OR TRANSMITTED IN ANY FORM OR BY ANY MEANS WITHOUT THE WRITTEN CONSENT OF JACKOLA ENGR. & ARCH., P.C.

ATLAS PLUMBING SHOP

428 NORTH PEKIN ROAD
WOODLAND, WA 98674

DRAWN: EMS CHECKED: SLD

DATE: 01/07/2021

REVISIONS:

LANDSCAPING
NOTES AND
DETAILS

C1.42

PHOTOMETRIC STATISTICS					
CALCULATION ZONE	AVERAGE	MAXIMUM	MINIMUM	MAX/MIN	AVERAGE/MIN
ROADWAY	2.0 FC	3.8 FC	0.9 FC	4.2:1	2.3:1
PARKING LOT WEST	2.1 FC	5.3 FC	0.7 FC	7.6:1	3.0:1
PARKING LOT SOUTH/EAST	1.6 FC	10.6 FC	0.1 FC	106.0:1	16.0:1
OVERHANG N	2.9 FC	7.4 FC	0.7 FC	10.6:1	4.1:1
OVERHANG S	3.1 FC	7.6 FC	0.3 FC	25.3:1	10.3:1

ATLAS PLUMBING WAREHOUSE

428 NORTH PEKIN ROAD
WOODLAND, WA 98674


DRAWN: Author CHECKED: Checker

DATE: 12/02/2020

REVISIONS:

**ELECTRICAL
PHOTOMETRIC
PLAN**

E0.11

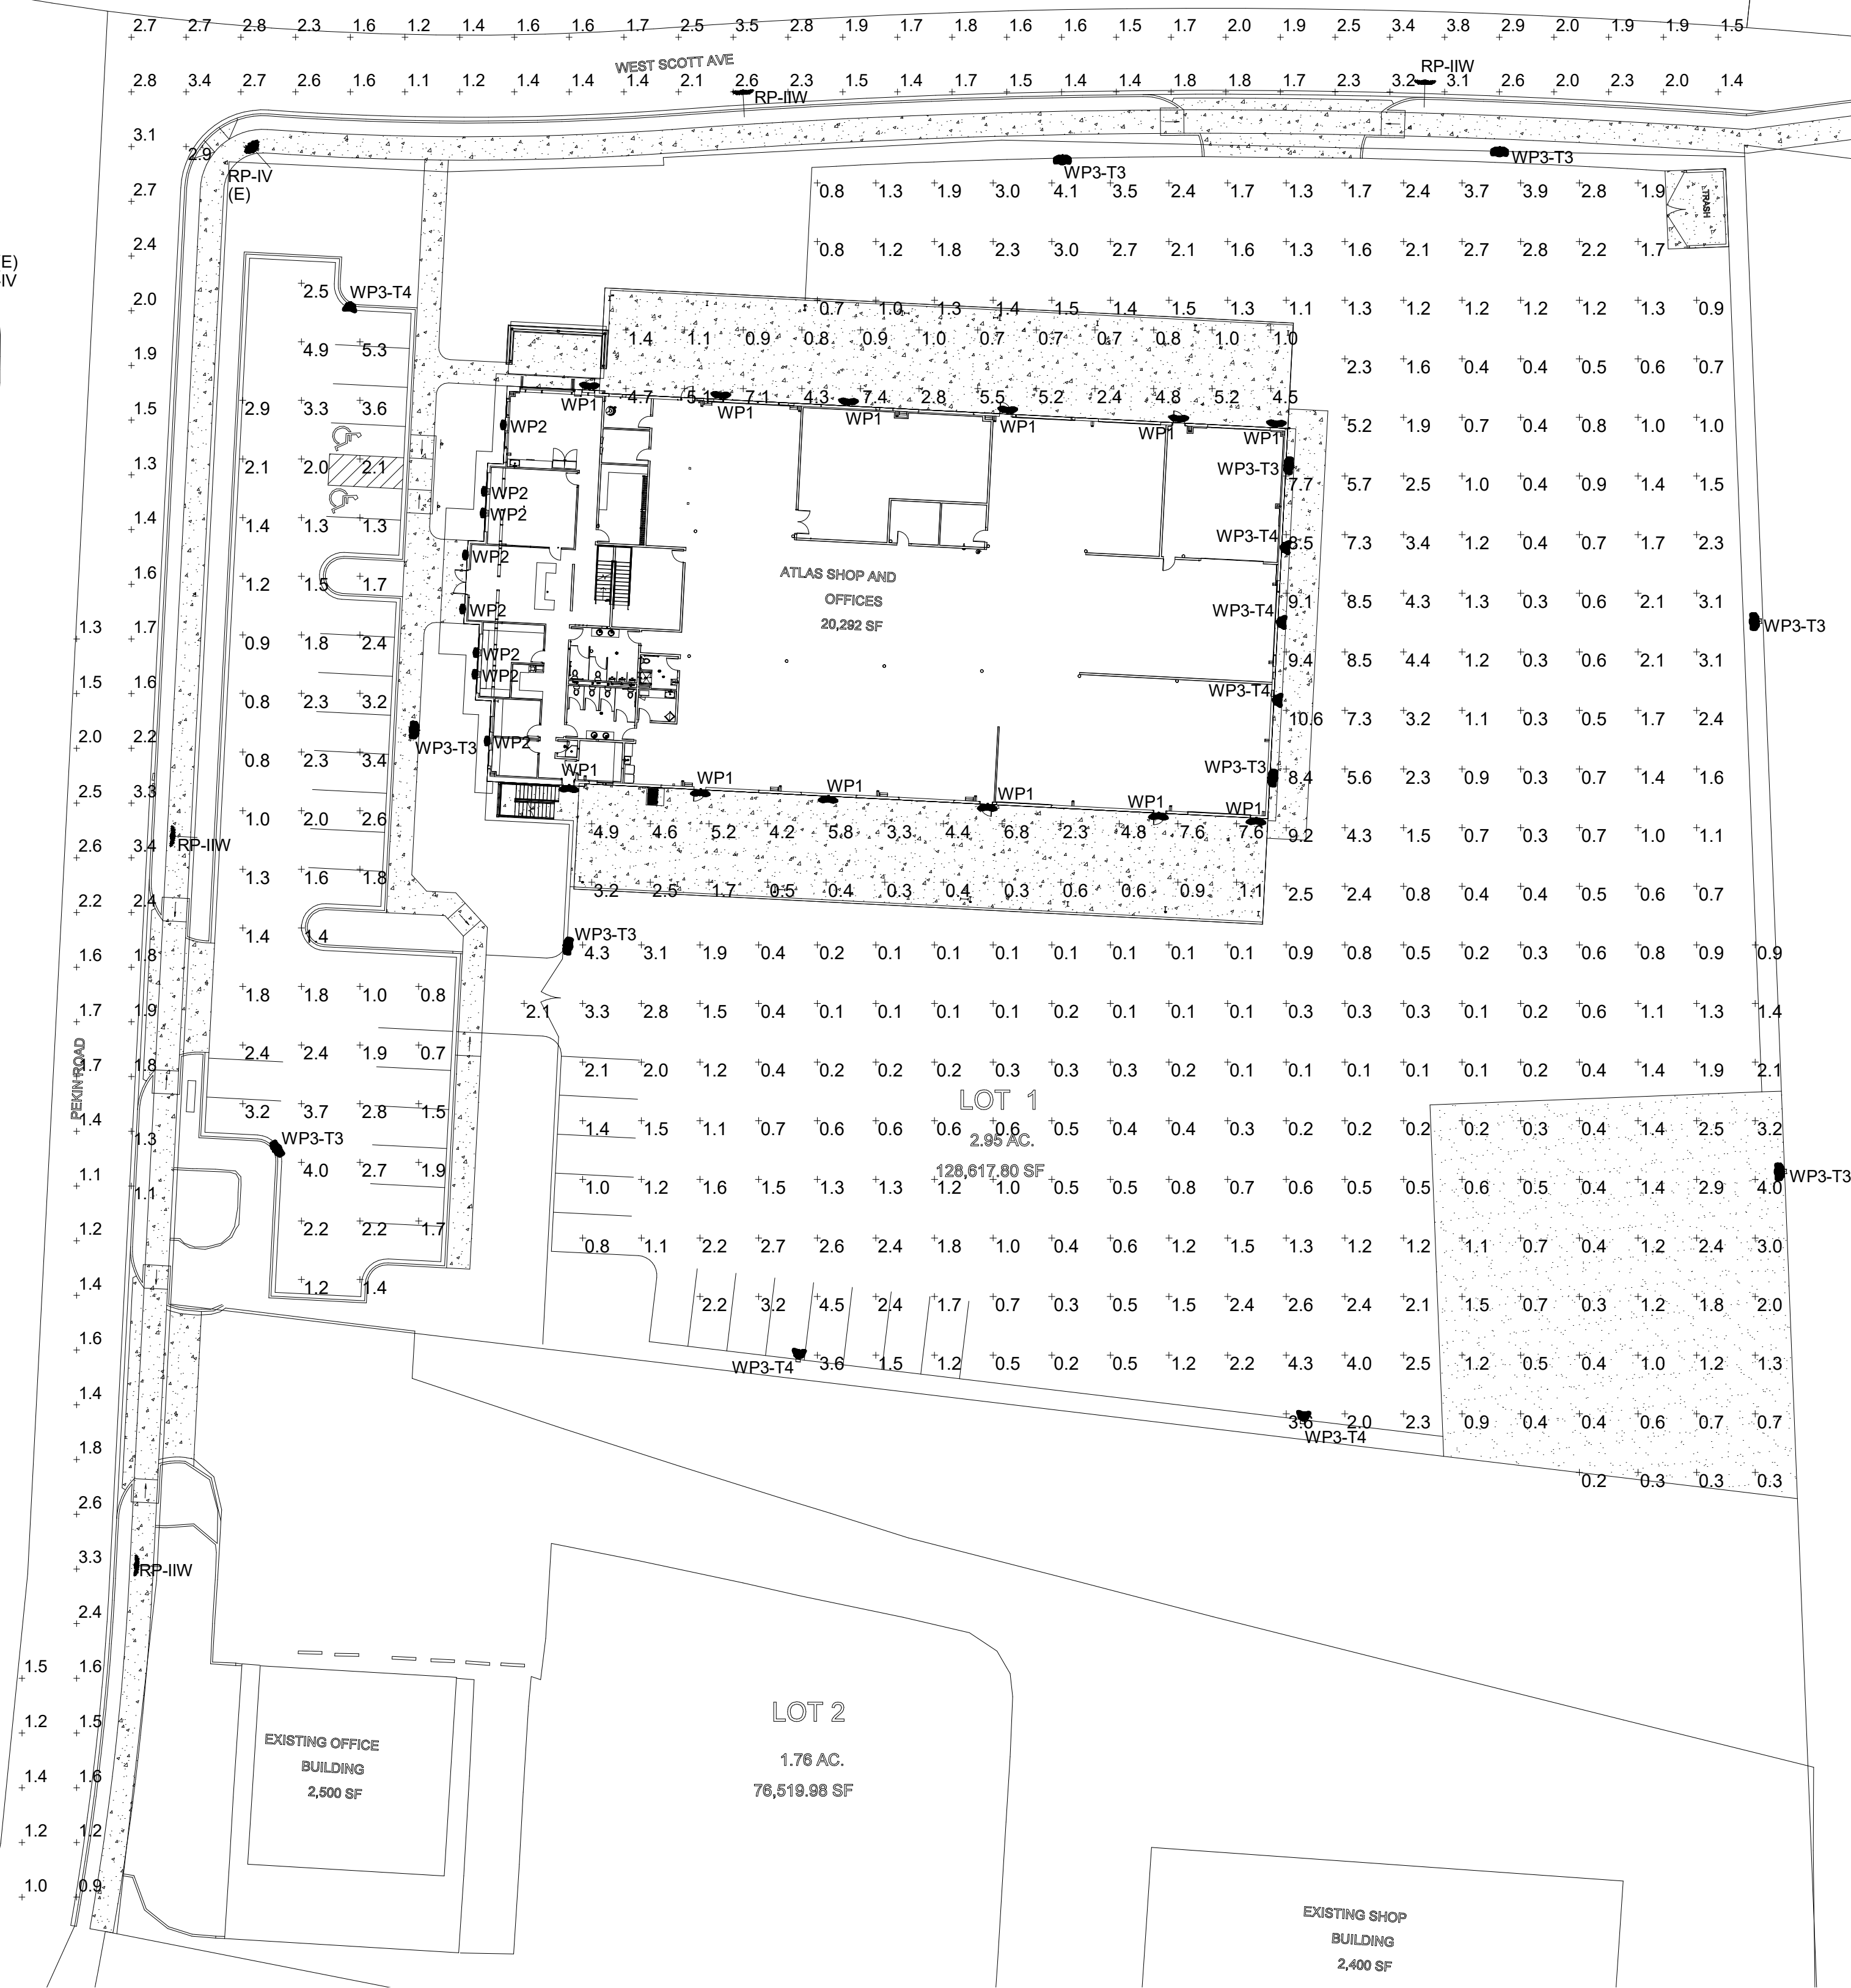

PROJECT #/Project Number: BIM 2020/Rev 2020/MEP20 Central Atlas Warehouse_BE_02014

1 PHOTOMETRIC SITE PLAN
1" = 30'-0"

